GENERAL FLOOR PLAN NOTES


- ALL NEW EXTERIOR WALLS TO BE 2X6 STUDS AT 16" O.C. WITH DOUBLE TOP PLATE AND SINGLE BOTTOM PLATE, U.O.N. WTIH INSULATION, VAPOR BARRIER, AND SHEATHING PER CODE, TYPICAL.
- ALL INTERIOR WALLS TO BE 2X4 STUDS U.O.N.
- WINDOWS SHOWN SHALL BE PER OWNER SELECTION.
- CEILING HEIGHT MAY VARY DUE TO STRUCTURAL
- ALL WINDOWS AND DOORS TO BE CENTERED IN ROOM U.N.O.
- . ALL WINDOW HEADER HEIGHTS SHALL BE 8'-0" U.N.O.
- OWNER TO SELECT ALL FINISHES FOR FLOORS, WALLS, CEILINGS, DOORS, TRIM, CABINETS, TOPS, ELEC & PLUMBING FIXTURES, ETC. AS REQUIRED, WITH THE BUILDER TO COORDINATE.
- STRUCTURAL FLOOR AND ROOF SYSTEMS PER OWNER, BUILDER AND ENGINEER, TYPICAL.
- GARAGE FINISH REQUIREMENTS: INSULATE PER CODE AND APPLY 5/8" FIRECODE TYPE "X" GYPSUM BOARD TO ALL WALLS ADJACENT TO LIVABLE SPACE. INSULATE GARAGE CEILINGS PER CODE AND APPLY 5/8" FIRECODE TYPE "X" GYPSUM BOARD WHERE LIVABLE SPACE OCCURS ABOVE THE GARAGE. WRAP ALL STRUCTURAL AND MECHANICAL COMPONENTS IN GARAGES TO CREATE CONTINUOUS FIRE RATED ASSEMBLY. PROVIDE SOLID CORE DOOR (MINIMUM 20 MINUTE
- RATING) WITH SPRING LOADED SELF CLOSING HINGES WITH TIGHT FITTING WEATHER-STRIPPING AT HOUSE TO GARAGE DOOR OPENING.
- 0. STAIRWAYS ARE TO CONFORM TO SECTION R311.5 OF THE IRC. TOP OF STAIR HANDRAILS TO BE MINIMUM 34" TO A MAXIMUM OF 38" ABOVE THE STAIR NOSING AND SHOULD BE CONTINUOUS THE FULL LENGTH OF THE STAIR RUN. HANDRAILS TO BE A MINIMUM OF 1-1/2" TO A MAXIMUM OF 2" IN DIAMETER SPACED 1-1/2" FROM THE WALL TERMINATING IN NEWEL POSTS OR RETURN
- TO WALL. MINIMUM HEADROOM CLEARANCE MEASURED ABOVE THE STAIR NOSING IS 6'-8". ALL GUARDRAILS TO BE MINIMUM 36" ABOVE THE FINISHED FLOOR OR STAIR NOSING. OPEN RAILINGS TO HAVE A MAXIMUM CLEAR OPENING OF 4" BETWEEN SPINDLES. RISERS NOT TO EXCEED 7-3/4" IN HEIGHT AND TREADS TO BE A MINIMUM OF 10".
- . ALL WORK TO COMPLY WITH LOCAL CODES AND ORDINANCES, TYPICAL.


SCALE: 1/4" = 1'-0" UPPER FLOOR AREA:

935 S.F.



PROJECT INFORMATION: BUILDER INFO:	PALMER RESIDENCE Builder: Phone: Phone: Email:
SHEET TITLE:	MAIN AND UPPER FLOOR PLAN
DESIGNER INFO:	JP Design, LLC Jason Pederson, AIBD jason@jpdesignhomes.com
SCALE: 1/8" = 1'-0" STATUS: Construction DESIGNER INFO:	All ideas, designs, arrangements and plans indicated or represented by this drawing are owned by, and the property of J.P. DESIGN LLC and were created, evolved and developed for use on, and in conjunction with, the original project. None of such ideas, designs, arrangements or plans shall be used by, or disclosed to any person, firm or corporation only purpose whosever without the written preserved.

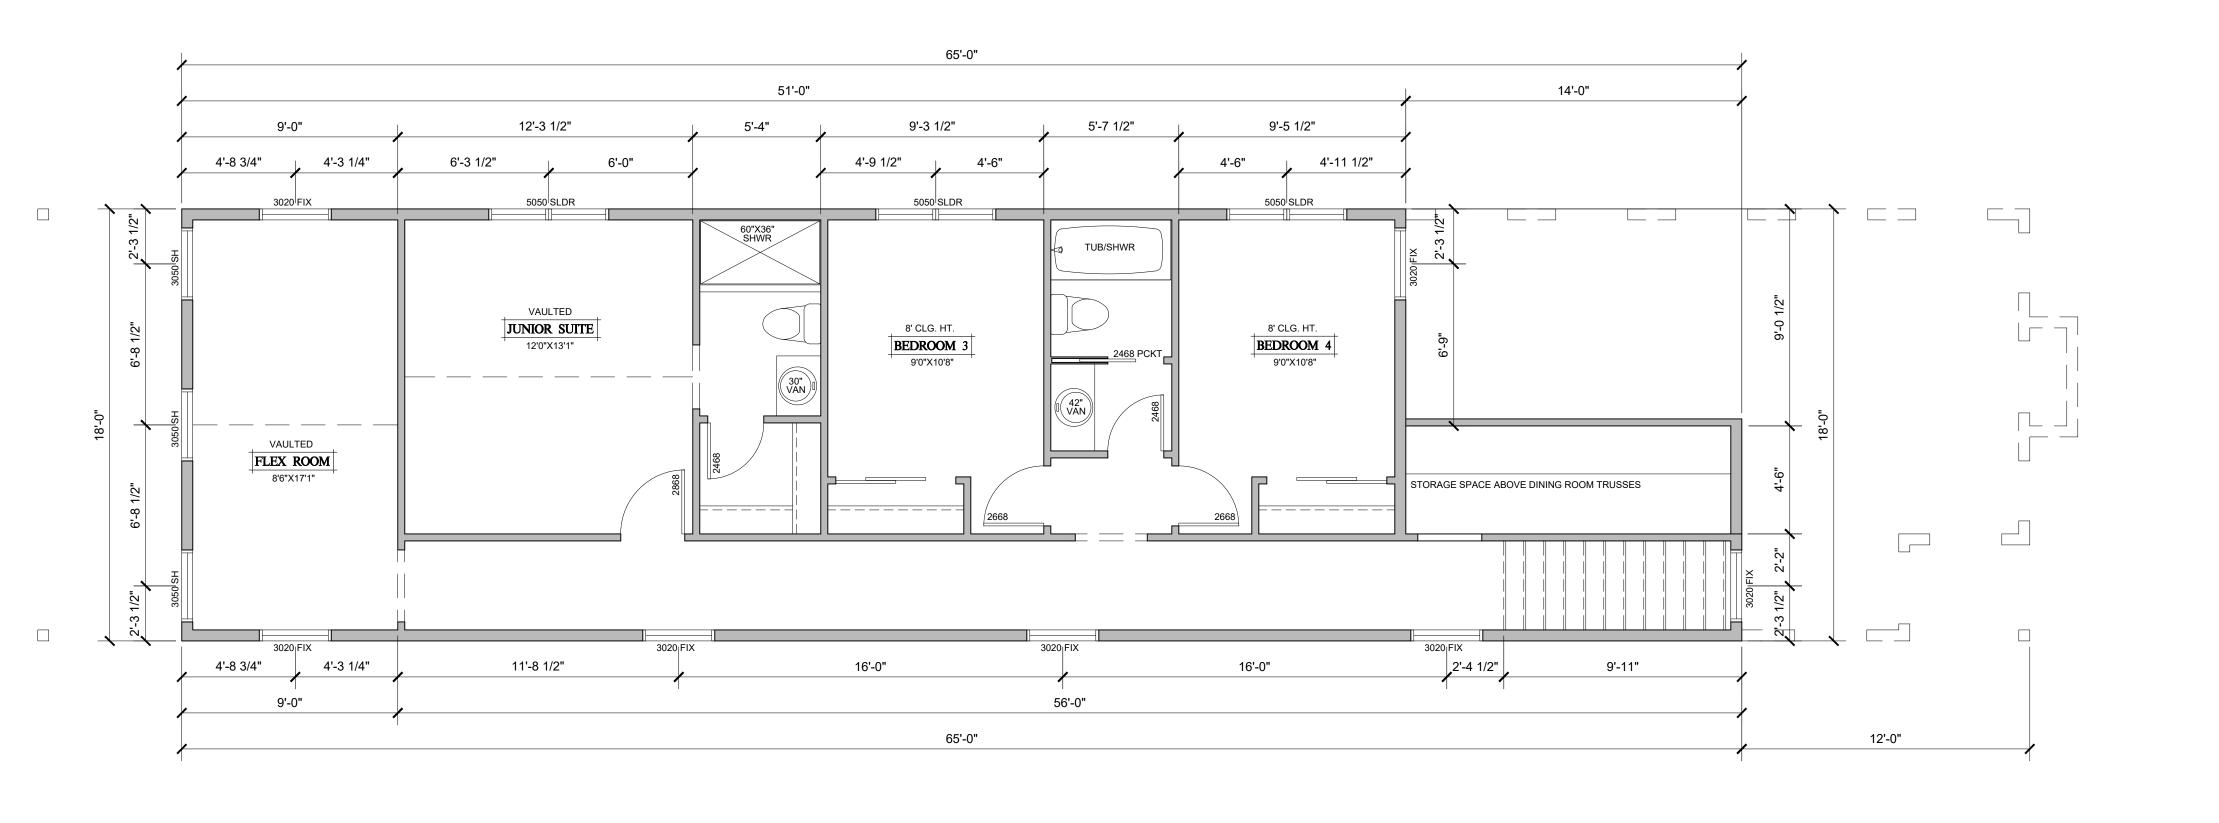

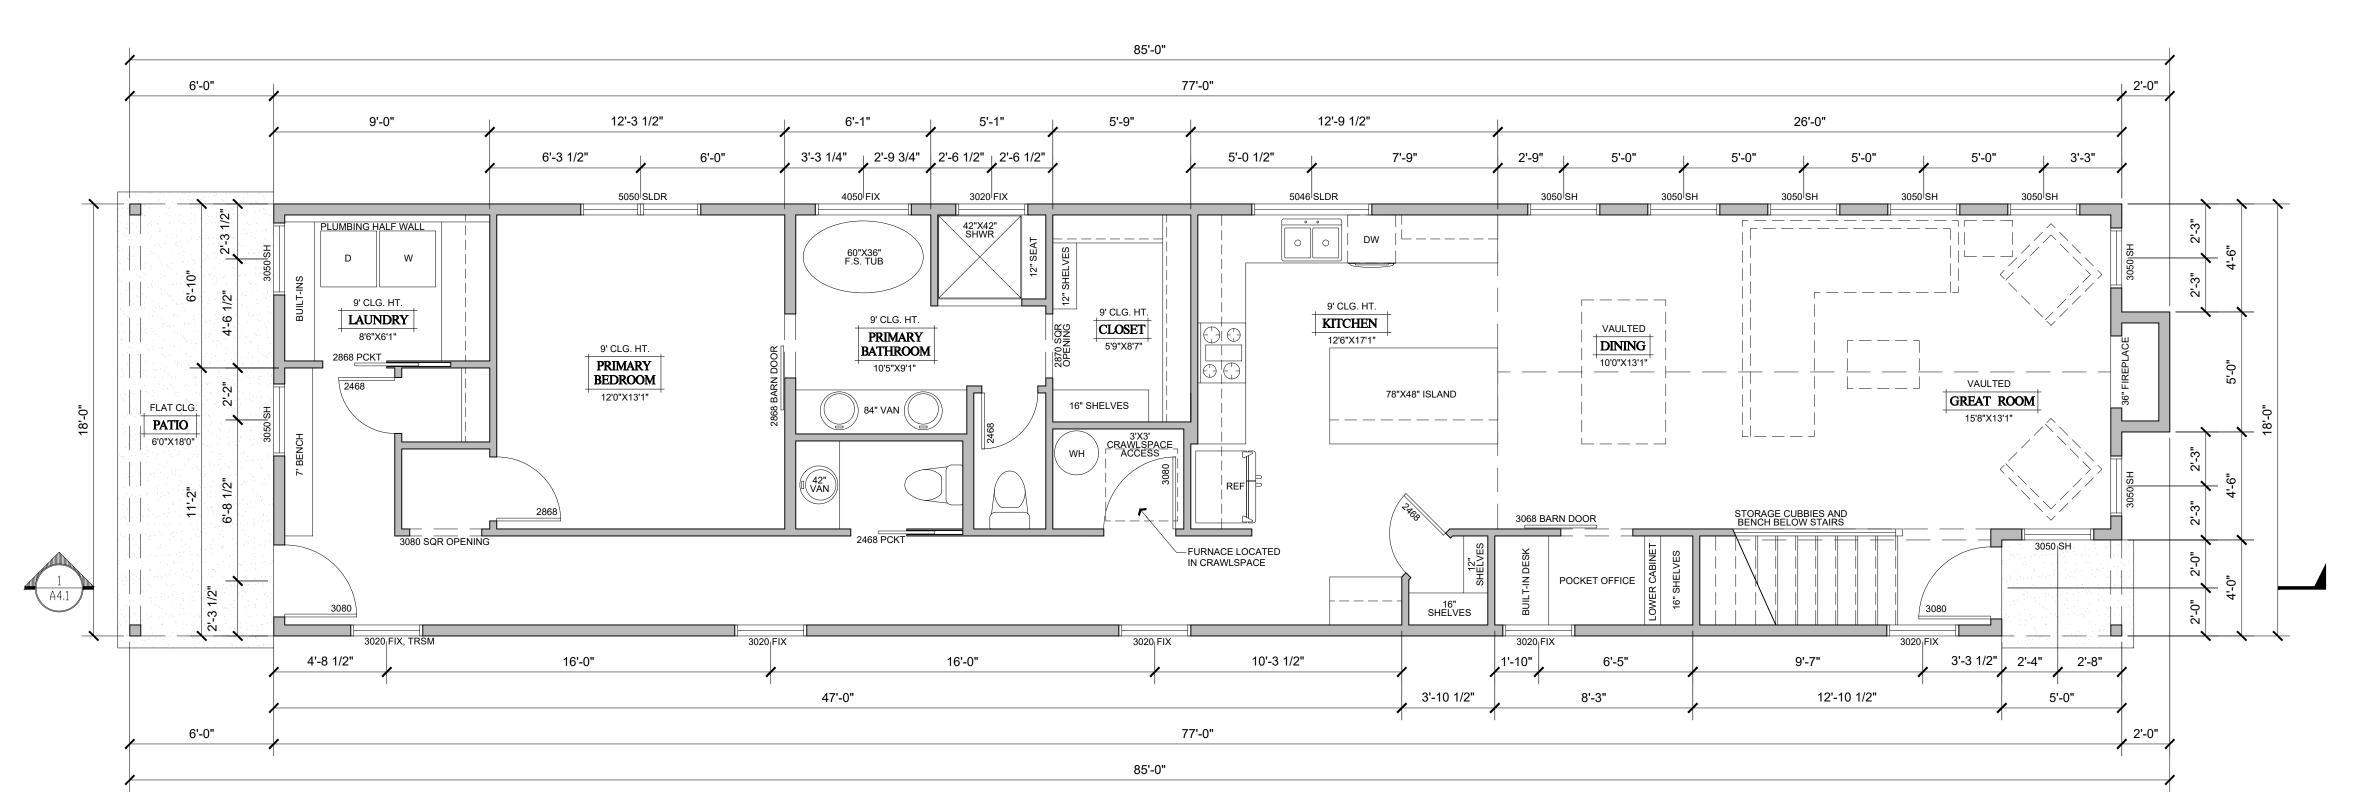

SCALE: 1/4" = 1'-0"


MAIN FLOOR AREA: FRONT PORCH AREA: **REAR PATIO AREA:** CRAWLSPACE AREA:

1,376 S.F. 20 S.F. 108 S.F. 1,376 S.F.

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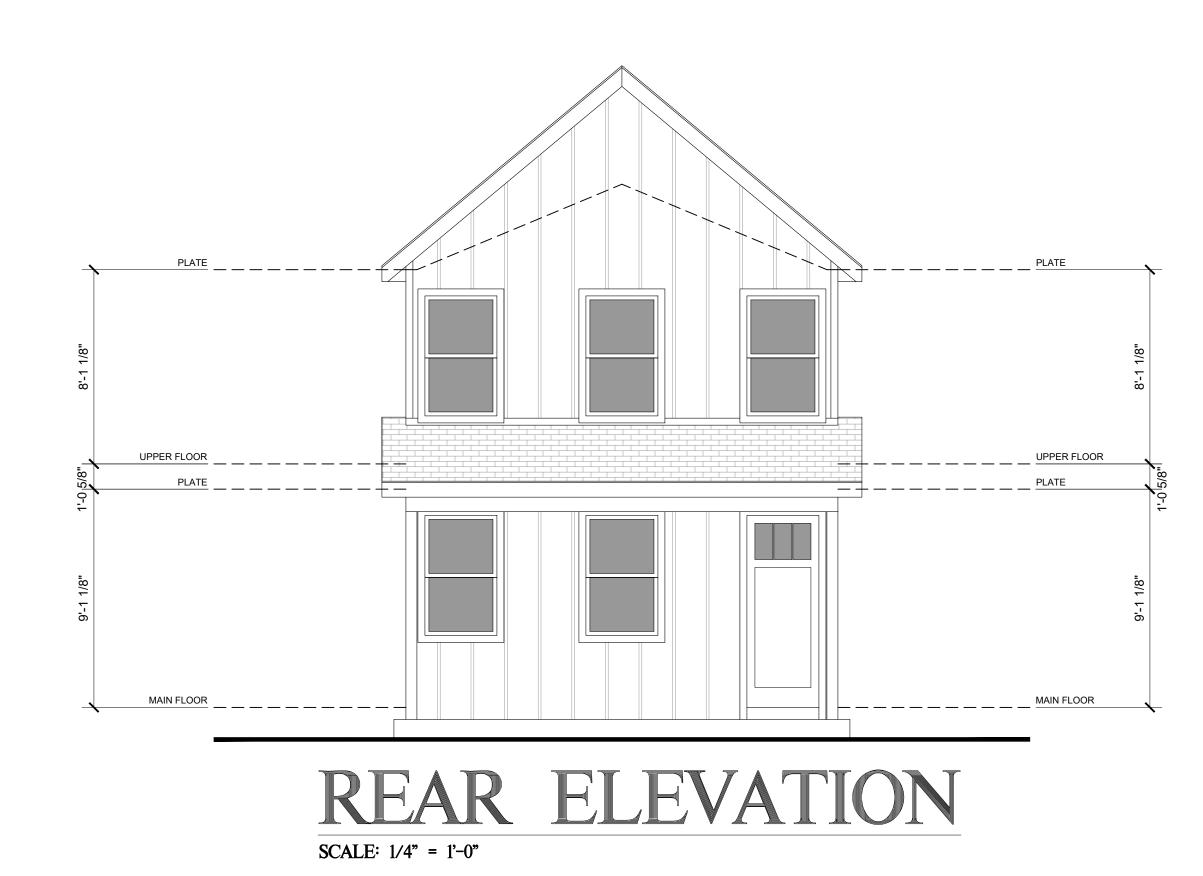
GENERAL ELEVATION NOTES


- I. BUILDER TO VENT ALL ROOFS PER CODE.
- 2. PROVIDE ALL FLASHING AS REQUIRED FOR WEATHER TIGHT CONSTRUCTION. INSTALL AND DETAIL PER SMACNA STANDARDS.
- 3. SLOPE GRADE AWAY FROM FOUNDATION PER SOILS REPORT. SOILS REPORT SHALL GOVERN FOUNDATION DRAINAGE AND SLABS.
- INSTALL ALL MATERIALS PER MANUFACTURER'S SPECIFICATIONS AND PER CODES, BUILDER TO COORDINATE.
- 5. WINDOW ROUGH OPENINGS TO BE VERIFIED WITH WINDOW SUPPLIER AND BUILDER TO COORDINATE.
- 6. BUILDER TO COORDINATE ALL EXTERIOR LIGHTING.
- 7. PROVIDE TEMPERED GLASS AT ALL SIDELIGHTS, EXTERIOR DOORS HAVING GLAZING AND WINDOWS AS REQUIRED BY LOCAL CODES, TYPICAL, BUILDER TO COORDINATE.
- 8. BUILDER TO PROVIDE AND INSTALL GUTTERS AND DOWNSPOUTS AS REQUIRED. PAINT TO MATCH ADJACENT SURFACES, BUILDER TO COORDINATE.

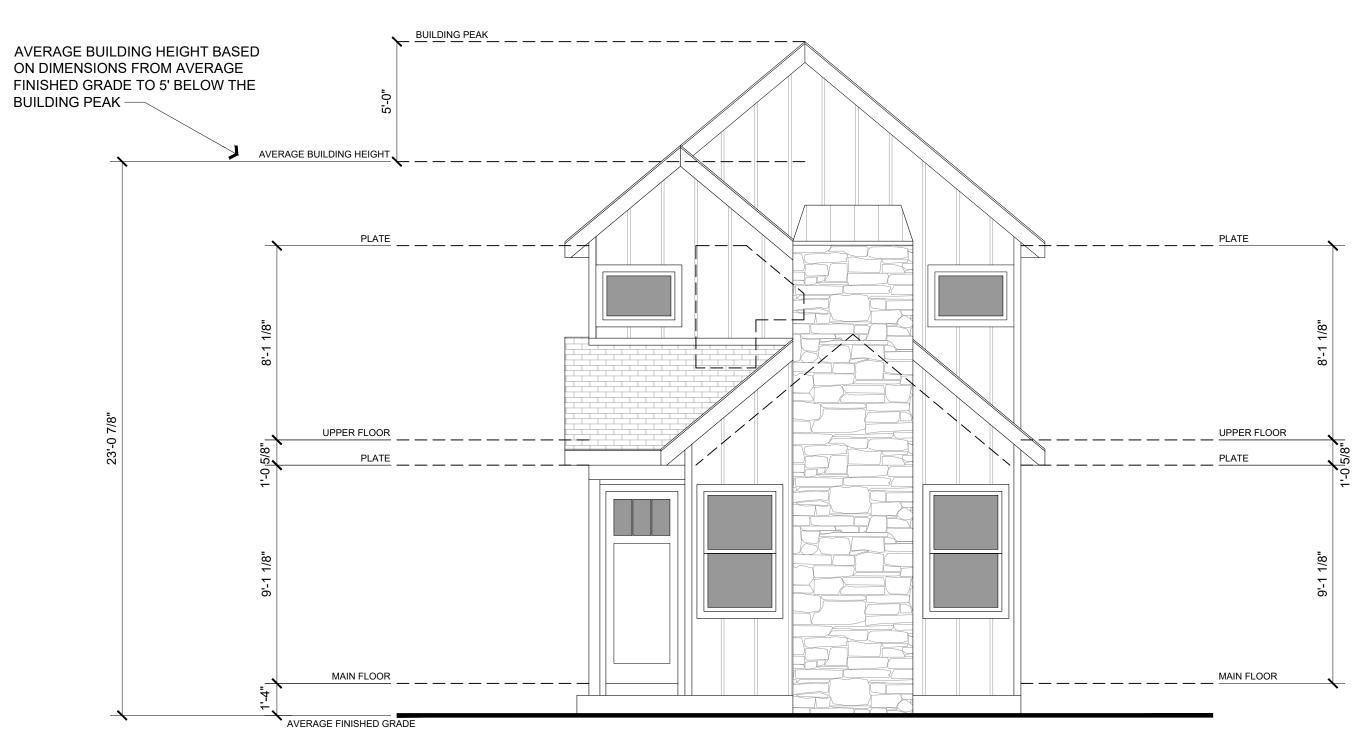


FRONT ELEVATION

SCALE: 1/4" = 1'-0"



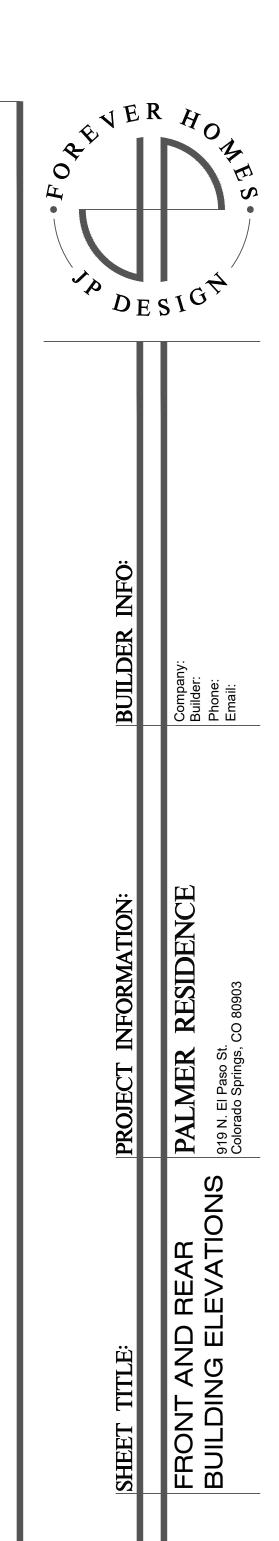

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All ideas, indicated owned by ord werred use on, project, project, project.

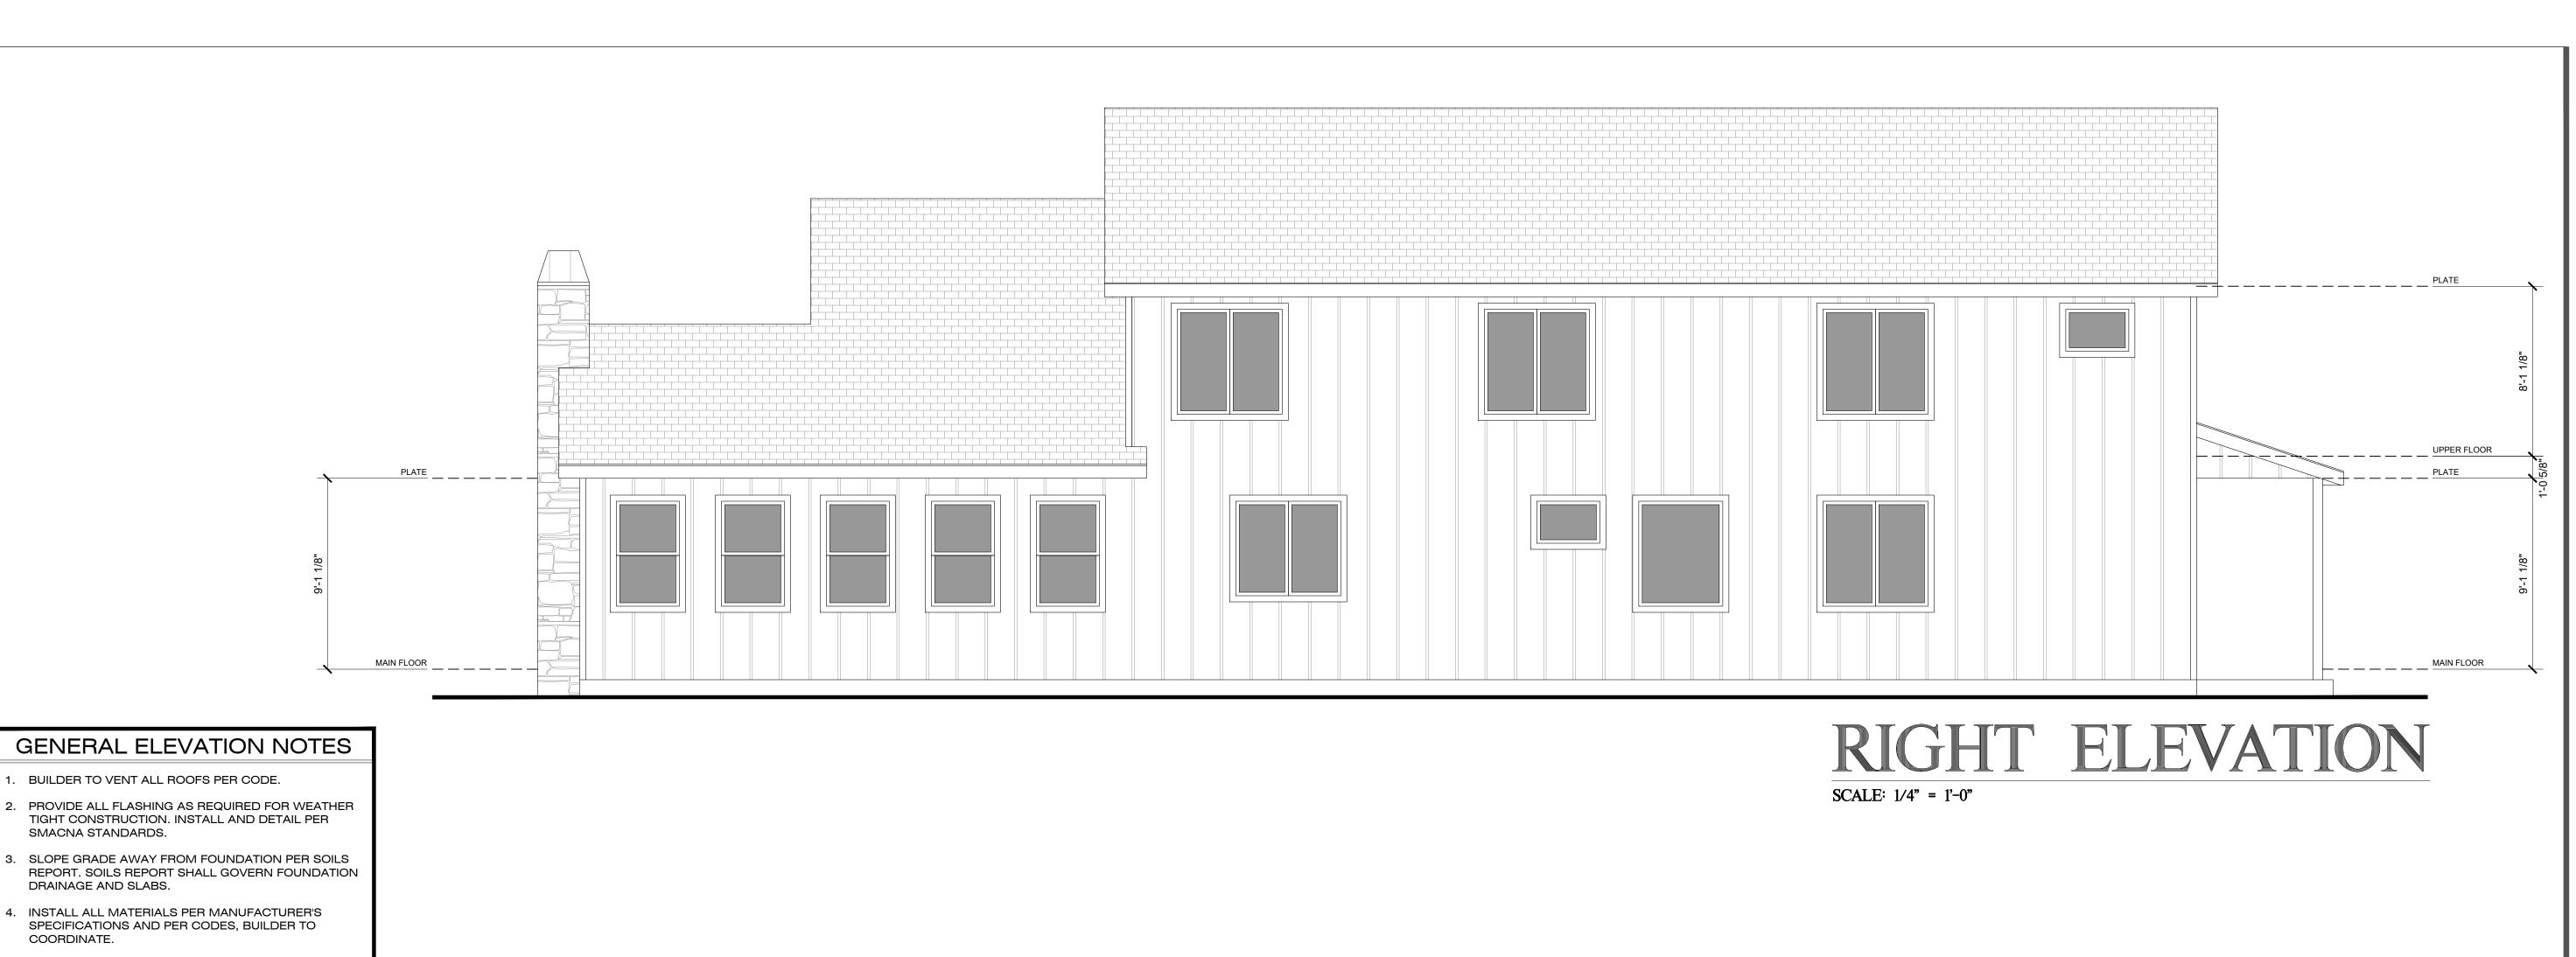

5. WINDOW ROUGH OPENINGS TO BE VERIFIED WITH


6. BUILDER TO COORDINATE ALL EXTERIOR LIGHTING.

PROVIDE TEMPERED GLASS AT ALL SIDELIGHTS,

BUILDER TO PROVIDE AND INSTALL GUTTERS AND DOWNSPOUTS AS REQUIRED. PAINT TO MATCH ADJACENT SURFACES, BUILDER TO COORDINATE.

WINDOW SUPPLIER AND BUILDER TO COORDINATE.

EXTERIOR DOORS HAVING GLAZING AND WINDOWS AS REQUIRED BY LOCAL CODES, TYPICAL, BUILDER TO

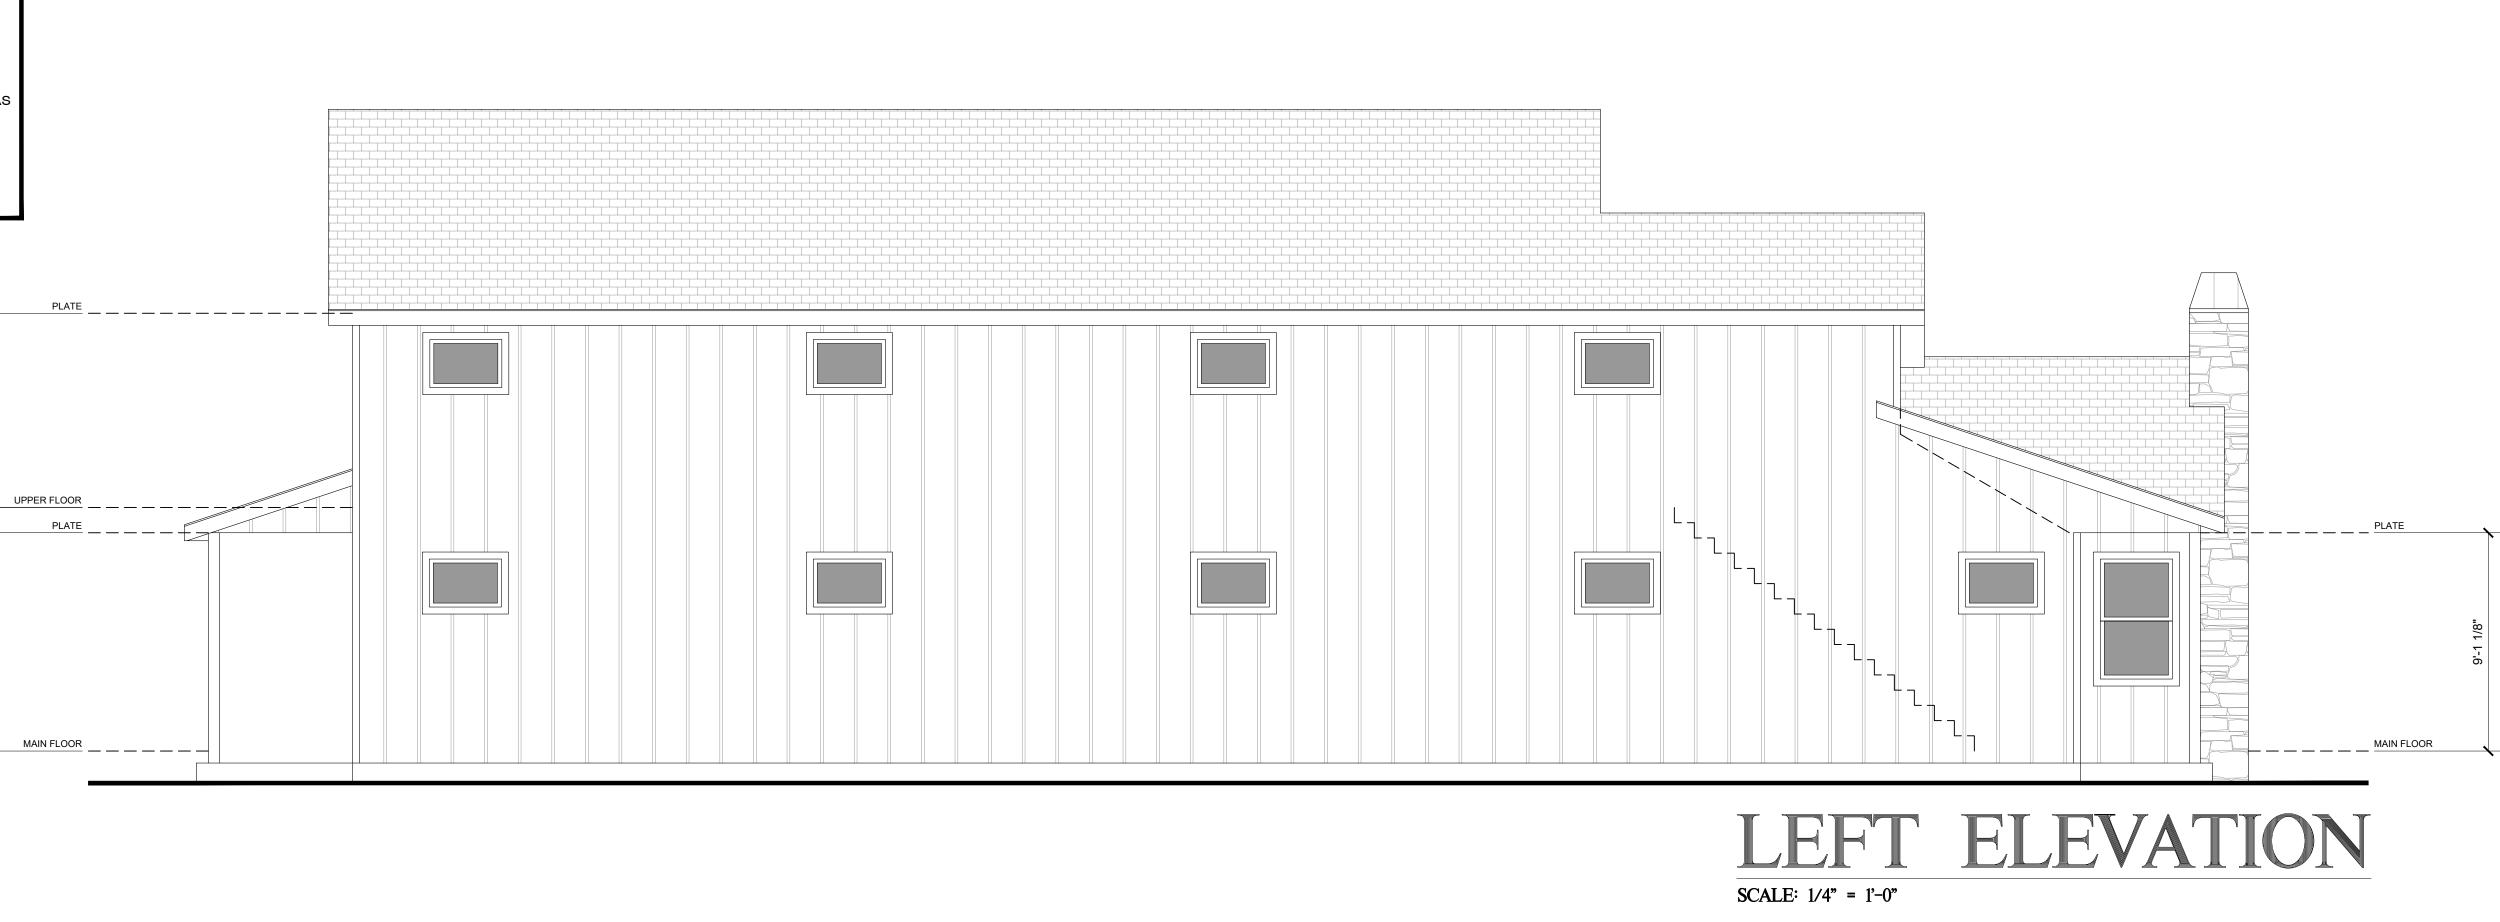


GENERAL ROOF PLAN NOTES

- 1. ROOF COVERING SHALL BE LOCALLY APPROVED MATERIAL ON FELTS (BUILDER TO VERIFY FELT WT. WITH MANUFACTURER) ON EXTERIOR GRADE ROOF SHEATHING PER CODE.
- 2. BUILDER TO VENT ALL ROOFS PER LOCAL CODES.
- B. PROVIDE ALL FLASHING PER SMACNA STANDARDS AS REQUIRED. BUILDER TO COORDINATE.
- 4. AS MUCH AS POSSIBLE, ALL ROOF PENETRATIONS SUCH AS FLUES, PLUMBING VENTS, ROOF VENTS, ETC. SHALL OCCUR ON THE BACKSIDE OF ALL RIDGES AWAY FROM STREET VIEW.
- 5. PAINT ALL VENTS, FLUES, ETC. TO MATCH ROOF COVERING, TYPICAL.
- 5. BUILDER TO PROVIDE AND INSTALL GUTTERS AND DOWNSPOUTS AS REQUIRED. PAINT TO MATCH ADJACENT SURFACES, BUILDER TO COORDINATE.
- 7. ROOFING VARIES PER SITE. BUILDER TO COORDINATE ROOFING MATERIAL AND FELT WT. PROVIDE ICE & WATER SHIELD UNDERLAYMENT AT LOCATIONS ABOVE 7000 FT. ELEVATION CONTINUOUS FROM EDGE OF ROOF / EAVE TO A POINT 2'-0" INSIDE EXTERIOR WALL LINE

ROOF VENTING CALCULATION

ROOF AREA = 1902 S.F.

1:300 = 6.34 S.F. x 144 SQ.IN. = 913 SQ.IN. REQUIRED
EAVE VENTING: 50% = CONTINUOUS
ROOF VENTING: 50% = 457 SQ.IN. REQUIRED
ROOF VENTING: >50% = 477 SQ.IN. PROVIDED
RV-53 ROOF VENTS = 53 SQ.IN. EACH
9 RV-53 REQUIRED IN UPPER 50% OF ROOF

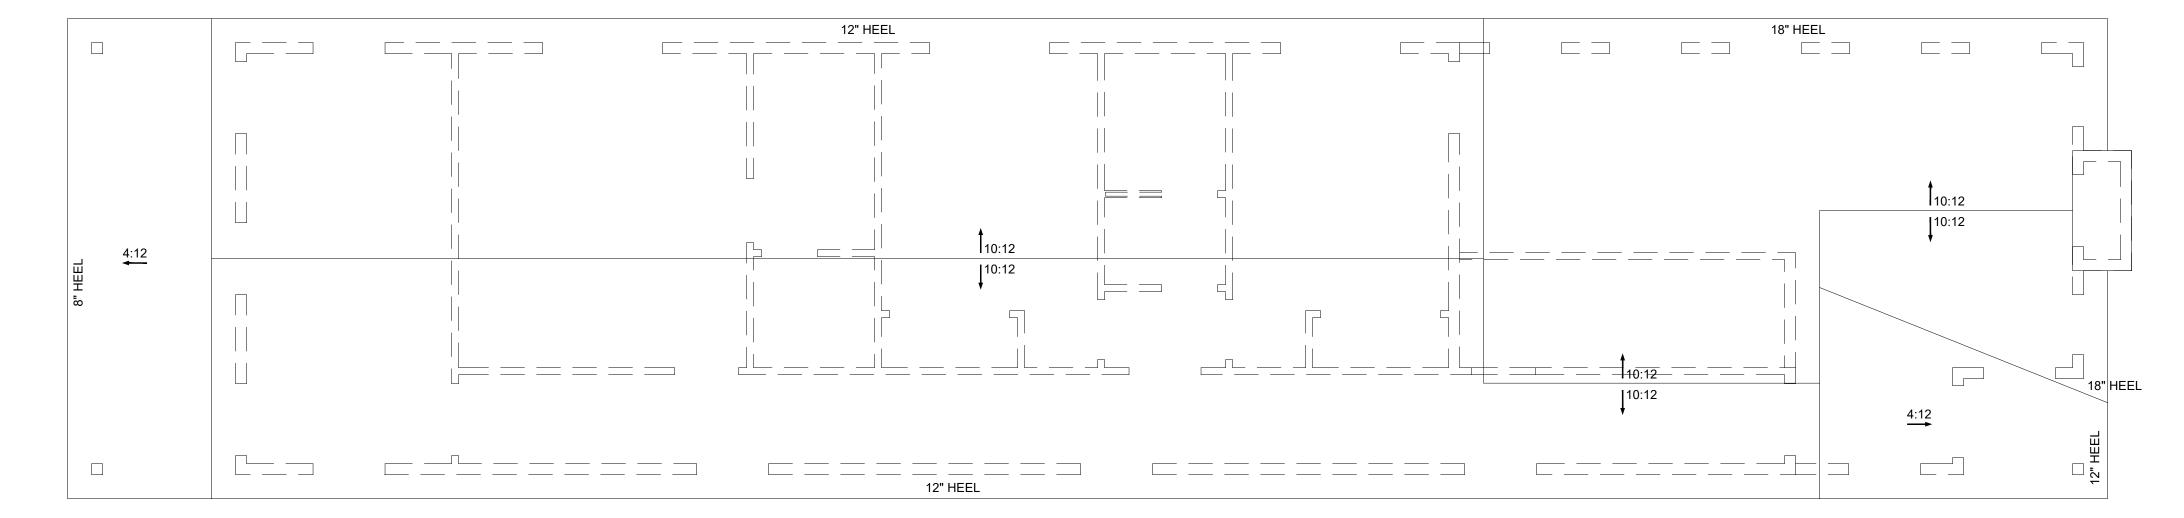




BUILDING SECTION

SCALE: 1/4" = 1'-0"



SHEET:	DATE: SUBD-23-0028 SCALE: 1/8" = 1'-0" STATUS: Construction	DATE: SUBD-23-0028 SCALE: 1/8" = 1'-0" STATUS: Construction DESIGNER INFO:	SHEET TITLE:	PROJECT INFORMATION:	BUILDER INFO:	DE
	All ideas, designs, arrangements and plans indicated or represented by this drowing are owned by, and the property of Ju.P. DESIGN LLC and were created, evolved and developed for use on, and in conjunction with, the original project. None of such ideas, designs, arrangements or plans shall be used by, or disclosed to any person, iffur or coproration for any purpose whatsever without the written	JP Design, LLC Jason Pederson, AIBD jason@jpdesignhomes.com	ROOF PLAN AND BUILDING SECTION	PALMER RESIDENCE 919 N. El Paso St. Colorado Springs, CO 80903	Company: Builder: Phone: Email:	SIGT

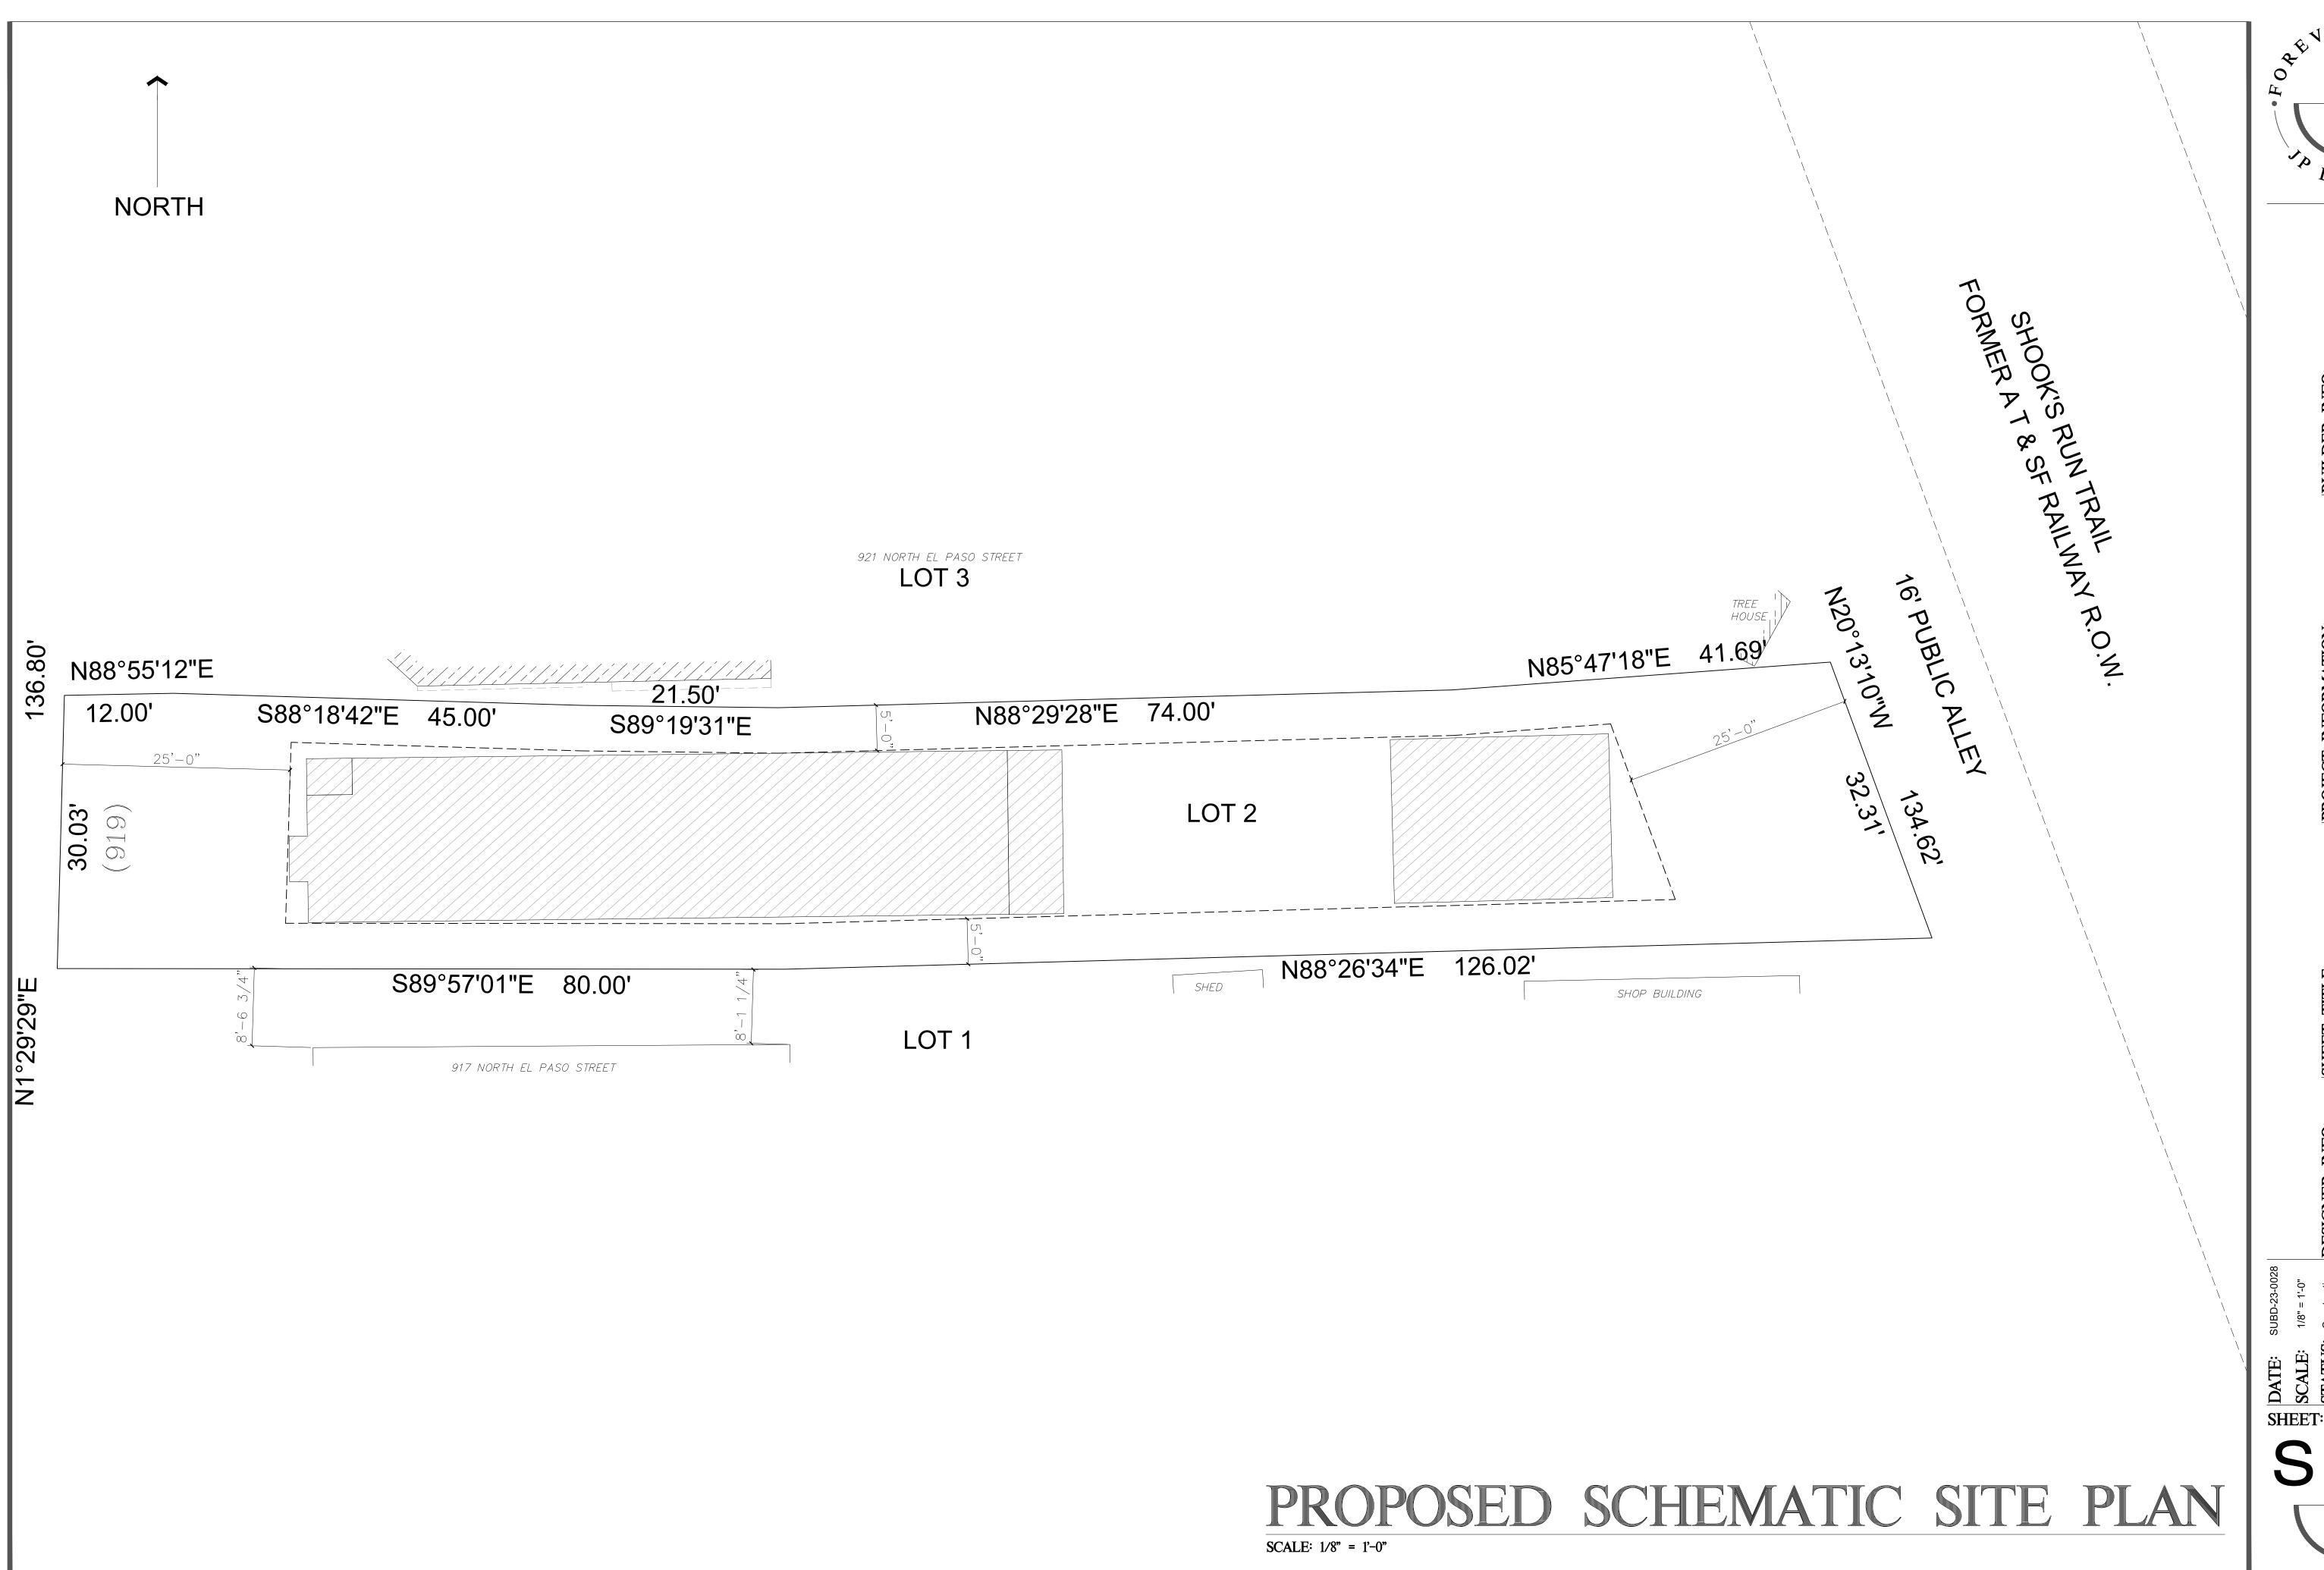

GENERAL ROOF PLAN NOTES

- ROOF COVERING SHALL BE LOCALLY APPROVED MATERIAL ON FELTS (BUILDER TO VERIFY FELT WT. WITH MANUFACTURER) ON EXTERIOR GRADE ROOF
- BUILDER TO VENT ALL ROOFS PER LOCAL CODES.
- PROVIDE ALL FLASHING PER SMACNA STANDARDS AS REQUIRED. BUILDER TO COORDINATE.
- AS MUCH AS POSSIBLE, ALL ROOF PENETRATIONS SUCH AS FLUES, PLUMBING VENTS, ROOF VENTS, ETC. SHALL OCCUR ON THE BACKSIDE OF ALL RIDGES AWAY
- PAINT ALL VENTS, FLUES, ETC. TO MATCH ROOF COVERING, TYPICAL.
- BUILDER TO PROVIDE AND INSTALL GUTTERS AND DOWNSPOUTS AS REQUIRED. PAINT TO MATCH ADJACENT SURFACES, BUILDER TO COORDINATE.
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9 RV-53 REQUIRED IN UPPER 50% OF ROOF

GENERAL FLOOR PLAN NOTES


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- THE IRC. TOP OF STAIR HANDRAILS TO BE MINIMUM 34" TO A MAXIMUM OF 38" ABOVE THE STAIR NOSING AND SHOULD BE CONTINUOUS THE FULL LENGTH OF THE STAIR RUN. HANDRAILS TO BE A MINIMUM OF 1-1/2" TO A MAXIMUM OF 2" IN DIAMETER SPACED 1-1/2" FROM THE WALL TERMINATING IN NEWEL POSTS OR RETURN TO WALL. MINIMUM HEADROOM CLEARANCE MEASURED ABOVE THE STAIR NOSING IS 6'-8". ALL GUARDRAILS TO BE MINIMUM 36" ABOVE THE FINISHED FLOOR OR STAIR NOSING. OPEN RAILINGS TO HAVE A MAXIMUM CLEAR OPENING OF 4" BETWEEN SPINDLES. RISERS NOT TO EXCEED 7-3/4" IN HEIGHT AND TREADS

STAIRWAYS ARE TO CONFORM TO SECTION R311.5 OF

11. ALL WORK TO COMPLY WITH LOCAL CODES AND

TO BE A MINIMUM OF 10".

ORDINANCES, TYPICAL.

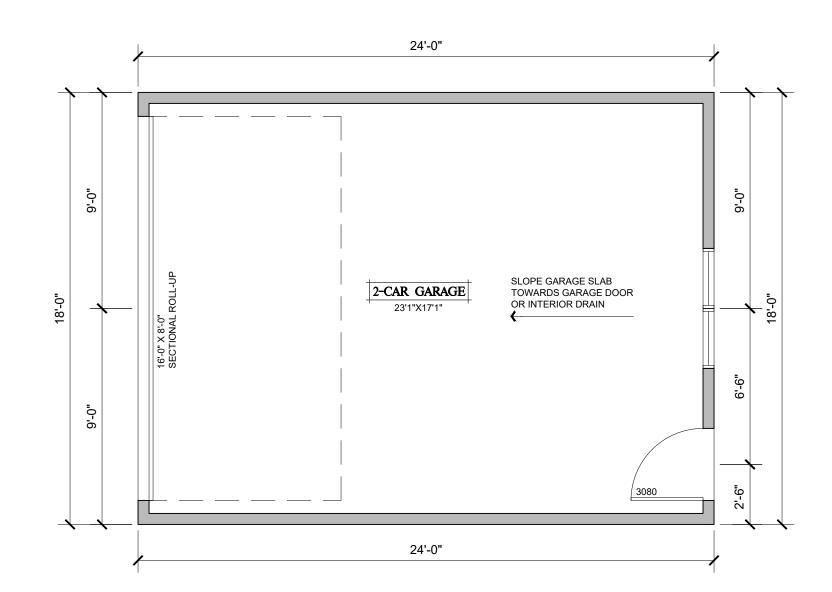


GARAGE FLOOR PLAN

SCALE: 1/4" = 1'-0"


GARAGE FLOOR AREA:

432 S.F.

SCALE: 1/4" = 1'-0"

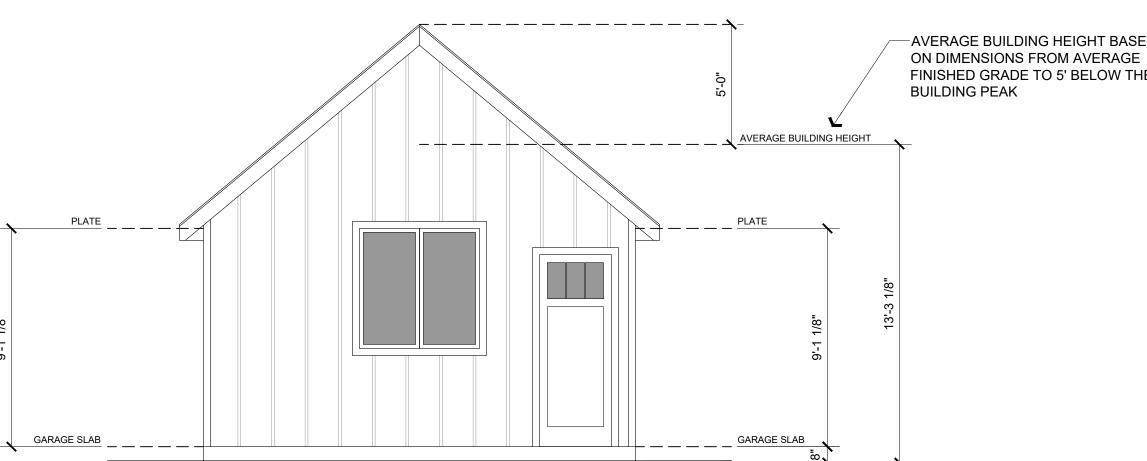

-AVERAGE BUILDING HEIGHT BASED ON DIMENSIONS FROM AVERAGE FINISHED GRADE TO 5' BELOW THE

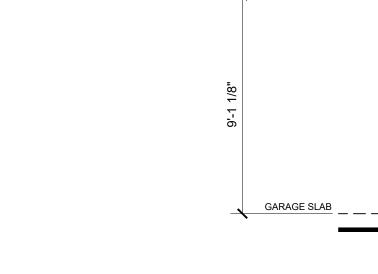

SCALE: 1/4" = 1'-0"


FRONT

PLATE

10:12


GARAGE ROOF PLAN

GARAGE ELEVATIONS

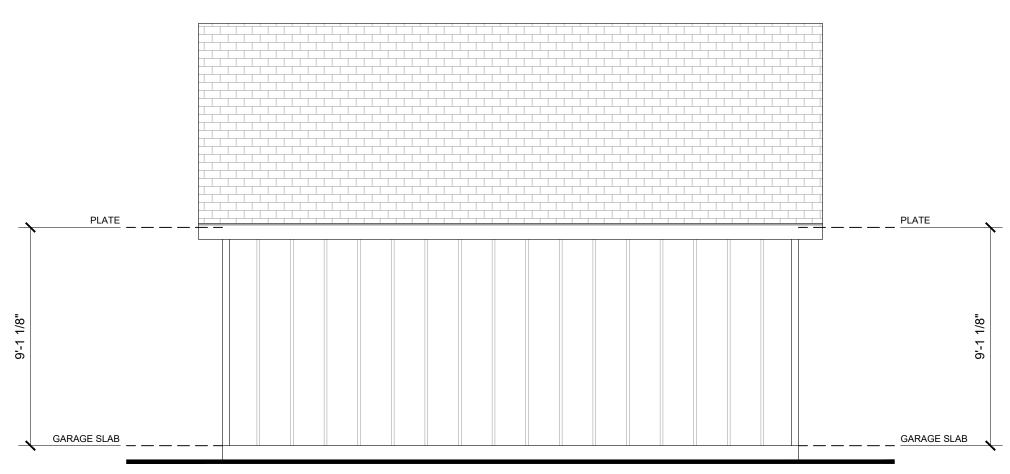

REAR

RIGHT

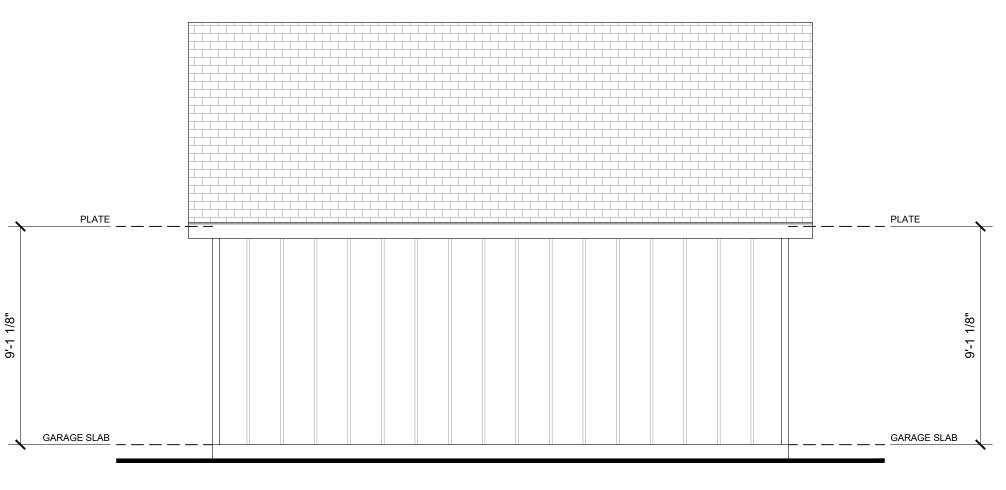



DESIGNER INFO:	SHEET TITLE:	PROJECT INFORMATION:	BUILDER INFO:	J
JP Design, LLC Ls Jason Pederson, AIBD	DETACHED GARAGE	PALMER RESIDENCE	Company: Builder:) <i>*</i>
jason@jpdesignhomes.com	PLANS	919 N. El Paso St.	Phone:	

