PROJECT CONTACTS

APPLICANT/DEVELOPER G LIGHT EQUITY, LLC. 5025 BOARDWALK DRIVE ST. 250 COLORADO SPRINGS, CO 80919 CONTACT: GAVIN LIGHT

EMAIL: GAVIN@GLIGHTEQUITY.COM

ATWELL, LLC 6200 S. SYRACUSE WAY, SUITE 470 GREENWOOD VILLAGE, CO, 80111 TEL: (303) 842-9191 CONTACT: KEVIN BLUMHARDT, P.E. EMAIL: KBLUMHARDT@ATWELL-GROUP.COM

<u>SURVEYOR</u> 2790 N ACADEMY BLVD. SUITE 311 COLORADO SPRINGS, CO 80917 TEL: (719) 360-6827 FAX: (719) 466-6527 CONTACT: SPENCER BARRON, PLS

TDG ARCHITECTURE 201 E. LAS ANIMAS STREET STE. 113 COLORADO SPRINGS, CO 80903 TEL: (719) 623-5641 CONTACT: KRISTIN KOTERA, AIA

LANDSCAPE ARCHITECT MATRIX DESIGN GROUP 2435 RESEARCH PARKWAY STE. 300 COLORADO SPRINGS, CO 80920 TEL: (719) 457-5612 CONTACT: ANDREA PAPIERSKI, PLA

		F + D + E	
PROPOSED DEVELOPMENT			
SITE LOCATION	GARDEN OF 1	NNIAL BLVD & THE GODS RD. ECTION	
TAX SCHEDULE NUMBER	73252	208191	
CONCEPT PLAN		T CONCEPT PLAN; 83-99	
EXISTING ZONING DISTRICT	CENTER/PLANNE OVERLAY/CON [ORDINANCE NO MX-M (MIXED	NNED BUSINESS ED PROVISIONAL DITIONAL USE) . 83-121]; UDC: USE-MEDIUM ALE)	
TOTAL ACREAGE	70,420 SF /	1.62 ACRES	
EXISTING USES/BUILDINGS	VACANT COM	MERCIAL LAND	
PROPOSED USE	MULTI-FAMILY RESIDENTIAL		
BUILDING SETBACKS	FRONT= 20'; SIE	E=5'; REAR=25'	
MAXIMUM BUILDING HEIGHT	45'		
TOTAL BUILDING FOOTPRINT		20 SF; BUILDING 6 SF PER UNIT)	
MAX PERCENT OF LOT COVERAGE	(STRU	0% CTURE) :VIOUS)	
MIN DENSITY	1	N LOT SIZE PER IIT)	
PROPOSED MIN DENSITY	946 SQ. FT	(PER UNIT)	
TOTAL UNITS	2	0	
PARKING DATA	REQUIRED	PROVIDED	
STANDARD SPACES	40	40	
ADA ACCESSIBLE SPACES	2	2	
TOTAL SPACES	40	40	

GEOLOGIC HAZARD DISCLOSURE STATEMENT

THIS PROPERTY IS SUBJECT TO THE FINDINGS, SUMMARY AND CONCLUSIONS OF A GEOLOGIC HAZARD REPORT PREPARED BY <u>CTL THOMPSON</u>, <u>INC.</u>, DATED <u>NOVEMBER 1</u>, 2022, WHICH IDENTIFIED THE FOLLOWING SPECIFIC GEOLOGIC HAZARDS ON THE PROPERTY: 1. UNDOCUMENTED FILL ON THE NORTHEASTERN HALF OF THE LOT 2. EXPANSIVE SOIL WITH (LOW) SWELL POTENTIAL

A COPY OF SAID REPORT HAS BEEN PLACED WITHIN FILE CUDP-22-0014, OR WITHIN THE SUBDIVISION FILE OF THE CITY OF COLORADO SPRINGS PLANNING AND DEVELOPMENT TEAM. CONTACT THE PLANNING AND DEVELOPMENT TEAM, 30 SOUTH NEVADA AVENUE, SUITE 701, COLORADO SPRINGS, CO, IF YOU WOULD LIKE TO REVIEW SAID REPORT. PERFORM SETTLEMENT CALCULATIONS/ESTIMATES ON POTENTIAL DIFFERENTIAL SETTLEMENT OF SUBGRADE DURING DESIGN-LEVEL GEOTECHNICAL INVESTIGATIONS, FOR FOUNDATION TYPE DETERMINATION.

DRAINAGE BASIN

DOUGLAS CREEK DRAINAGE BASIN

FLOODPLAIN INFORMATION

ACCORDING TO THE FEDERAL EMERGENCY MANAGEMENT AGENCY (FEMA) FLOOD INSURANCE RATE MAP NUMBER 08041C0513G, EFFECTIVE DATE DECEMBER 7, 2018. THE PROJECT LIES OUTSIDE OF THE 100-YEAR AND 500-YEAR FLOODPLAINS.

LEGAL DESCRIPTION

LOT 3 SAHIN SUBDIVISION

CONSISTS OF 9 UNITS.


GENERAL SITE DESCRIPTION


PROJECT DESCRIPTION: CONSTRUCTION OF (2) MULTI-FAMILY RESIDENTIAL BUILDINGS WITH ASSOCIATED LANDSCAPING, PARKING, AND DRIVES. BUILDING A CONSISTS OF 11 UNITS, BUILDING B

CONDITIONAL USE DEVELOPMENT PLAN


CENTENNIAL BLVD. TOWNHOMES LOT 3 SAHIN SUBDIVISION

A PORTION OF THE NORTHWEST QUARTER OF SECTION 25, TOWNSHIP 13 SOUTH, RANGE 67 WEST OF THE 6TH P.M. CITY OF COLORADO SPRINGS, COUNTY OF EL PASO, STATE OF COLORADO

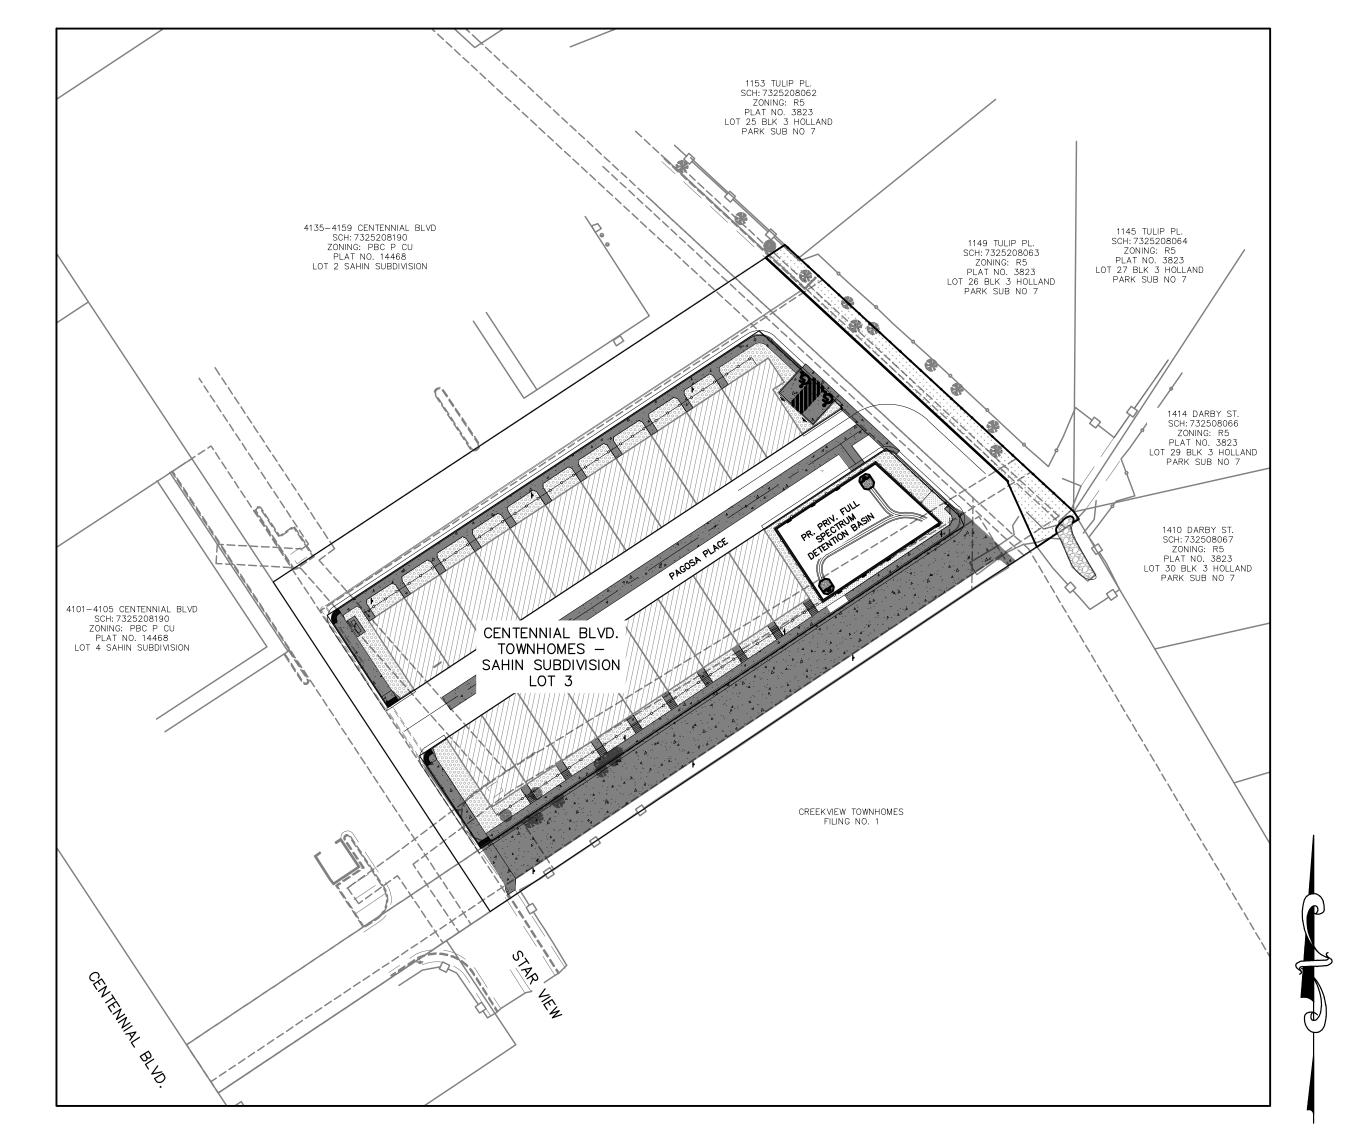

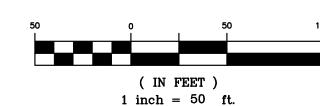

VICINITY MAP

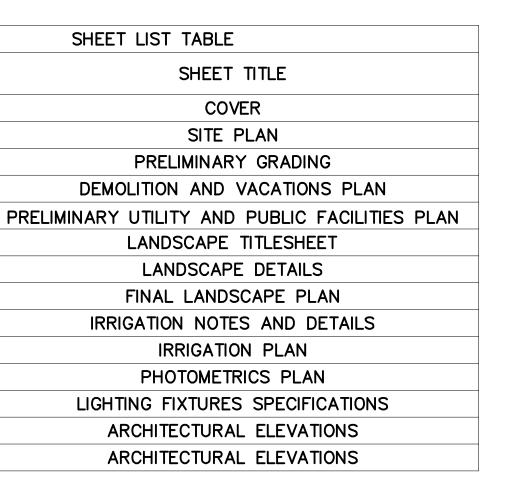

SHEET NUMBER

01

03

04

05

06

07

80

09

10

11

12

13

14



GENERAL NOTES

- THE PROPERTY OWNER IS RESPONSIBLE FOR THE MAINTENANCE FOR SHARED COMMON TRACTS, ACCESS DRIVES, LANDSCAPE AREAS ADJACENT TO THEIR PROPERTY. LANDSCAPE IMPROVEMENTS AND MAINTENANCE SHALL BE THE RESPONSIBILITY OF THE OWNER AND/OR THEIR ASSIGNS.
- STREET TREES, STREETSCAPE IMPROVEMENTS, AND VEGETATION WITHIN THE CITY RIGHT-OF-WAY SHALL BE MAINTAINED BY THE ABUTTING PROPERTY OWNER.
- SIGNAGE IS NOT APPROVED PER THIS PLAN. A SEPARATE SIGN PERMIT IS REQUIRED CONTACT DEVELOPMENT REVIEW ENTERPRISE AT 719-385-5982 TO BEGIN A SIGN
- PER CITY CODE SECTION 7.4.102.D, ALL LIGHTING FIXTURES SHALL BE FULL CUT-OFF OR HAVE SHIELDING TO REDUCE OFF-SITE LIGHTING IMPACTS ONTO ADJACENT PROPERTIES AND ROADWAYS. ALL EXTERIOR LIGHTING SHALL BE ARRANGED TO MITIGATE LIGHT DIRECTED AWAY FROM ADJACENT PROPERTIES AND ANY PUBLIC RIGHT-OF-WAY. AN AMENDMENT TO THIS PLAN MAY BE REQUIRED IF THE LIGHTING TYPE IS CHANGED.
- ACCESSIBLE PARKING SPACES, ACCESS AISLES, AND SIGNAGE SHALL MEET ALL APPLICABLE CITY CODE REQUIREMENTS INCLUDING:
 - * PARKING SPACES AND ACCESS AISLES SHALL BE LEVEL WITH SURFACE SLOPES NOT EXCEEDING ONE TO FIFTY (1:50) (2 PERCENT) IN ALL DIRECTIONS.
 - * ACCESSIBLE PARKING SPACES SHALL BE MARKED WITH FOUR-INCH (4") LINES. * ACCESSIBLE AISLES SHALL BE OUTLINED AND DIAGNOLLY STRIPED AT FORTY-FIVE-DEGREE (45°) ANGLES IN A CONTRASTING COLOR SUCH AS YELLOW,
- WHITE, OR BLUE. * EACH ACCESSIBLE PARKING SPACE SHALL BE DESIGNATED AS RESERVED BY A SIGN SHOWING THE INTERNATIONAL SYMBOL OF ACCESSIBILITY. VAN ACCESSIBLE SPACES SHALL HAVE AN ADDITIONAL SIGN CONTAINING THE DESIGNATION, "VAN ACCESSIBLE", MOUNTED BELOW THE SYMBOL OF ACCESSIBILITY. EACH ACCESSIBLE PARKING SPACE SIGN SHALL BE NO SMALLER THAN EIGHTEEN INCHES (18") TALL BY TWELVE INCHES (12") WIDE. EACH VAN ACCESSIBLE SIGN SHALL BE NO SMALLER THAN SIX INCHES (6") TALL BY TWELVE INCHES (12") WIDE. SIGNS SHALL

BE LOCATED AT THE HEAD OF THE SPACE WITH THE BOTTOM OF THE SIGN(S) BETWEEN FIVE FEET (5') AND SEVEN FEET (7') ABOVE THE FINISH FLOOR OR

- THE MINERAL ESTATE OWNER NOTIFICATION CERTIFICATION AFFIDAVIT WAS SUBMITTED AND CAN BE FOUND IN THE FILE NO. CUDP-22-0014. THE APPLICANT (OR PROPERTY OWNER) HAS ATTESTED THERE ARE NO SEPARATE MINERAL ESTATE OWNER(S) IDENTIFIED AND NO FURTHER ACTION WAS TAKEN.
- 7. THERE ARE NO SIGNIFICANT NATURAL FEATURES LOCATED UPON THIS PROPERTY
- THE APPROXIMATE SCHEDULE OF DEVELOPMENT IS TO START CONSTRUCTION FALL OF 2023 AND BE COMPLETE BY FALL OF 2024.
- THE PARTIES RESPONSIBLE FOR THIS PLAN HAVE FAMILIARIZED THEMSELVES WITH ALL CURRENT ACCESSIBILITY CRITERIA AND SPECIFICATIONS AND THE PROPOSED PLAN REFLECTS ALL SITE ELEMENTS REQUIRED BY THE APPLICABLE ADA DESIGN STANDARDS AND GUIDELINES AS PUBLISHED BY THE UNITED STATES DEPARTMENT OF JUSTICE. APPROVAL OF THIS PLAN BY THE CITY OF COLORADO SPRINGS DOES NOT ASSURE COMPLIANCE WITH THE ADA OR ANY OTHER FEDERAL OR STATE ACCESSIBILITY LAWS OR ANY REGULATIONS OR GUIDELINES ENACTED OR PROMULGATED UNDER OR WITH RESPECT TO SUCH LAWS. SOLE RESPONSIBILITY FOR COMPLIANCE WITH FEDERAL AND STATE ACCESSIBILITY LAWS LIES WITH THE PROPERTY OWNER.
- 10. ALL CURB, GUTTER, PEDESTRIAN RAMPS AND SIDEWALK POSING A SAFETY HAZARD, EXHIBITING EXCESSIVE DETERIORATION, DAMAGED OR DOES NOT MEET CURRENT CITY ENGINEERING STANDARDS ALONG THE PUBLIC RIGHT-OF-WAY (ROW) ADJACENT TO THE SITE WILL NEED TO BE REMOVED AND REPLACED PRIOR TO THE ISSUANCE OF THE CERTIFICATE OF OCCUPANCY (C.O.). AN ON-SITE MEETING CAN BE SET UP WITH THE ENGINEERING DEVELOPMENT REVIEW (EDRD) INSPECTOR TO DETERMINE WHAT, IF ANY IMPROVEMENTS ARE REQUIRED. THE EDRD INSPECTOR CAN BE REACHED AT 719-385-5977.
- 11. ALL TRAFFIC RELATED "SIGNS", "STRIPING" OR "CONTROL DEVICES" WILL BE INSTALLED BY THE DEVELOPER AT THE LOCATIONS SHOWN ON THE DEVELOPMENT PLAN TO MEET MUTCD STANDARDS. CONTACT TRAFFIC ENGINEERING, SIGNS & MARKINGS AT 719-385-6720 FOR ASSISTANCE.
- 12. THERE SHALL BE NO PARKING ON INTERNAL ACCESS ROADS.
- 13. THE DEVELOPER MUST MAKE FINANCIAL ARRANGEMENTS FOR THE PERPETUAL OWNERSHIP AND MAINTENANCE OF PRIVATE STREETS TO INCLUDE LIFE-CYCLE REPAIR AND REPLACEMENT OF THE FACILITIES.
- 14. THE OPERATION AND MAINTENANCE OF ALL AREAS WITHIN TO BE PLATTED LOT 3, SAHIN SUBDIVISION SHALL BE THE RESPONSIBILITY OF THE OWNER.
- PRIVATE FACILITIES AND COMMON AREAS ARE TO BE MAINTAINED BY THE OWNER. THESE FACILITIES INCLUDE BUT ARE NOT LIMITED TO: PAVED DRIVE AISLES WITHIN PRIVATE ACCESS EASEMENTS, PAVED PARKING LOTS, LANDSCAPED AREAS AND COMMON SPACE AMENITIES.
- 16. PUBLIC FACILITIES ARE PROPOSED WITHIN THE PROPERTY INCLUDING THE PUBLIC WASTEWATER MAIN, ELECTRIC LINES, AND GAS LINES WHICH ARE TO BE FURNISHED AND INSTALLED BY THE DEVELOPER AND MAINTAINED BY COLORADO SPRINGS
- 17. EXISTING PRIVATE AND PUBLIC UTILITY AND ACCESS EASEMENTS TO BE VACATED VIA REAL ESTATE SERVICES.
- 18. SEE FINAL PLAT APPLICATION FOR EXISTING AND FINAL PLAT CONDITIONS FOR EXISTING AND PROPOSED PRIVATE AND PUBLIC UTILITY AND ACCESS EASEMENTS.
- CONSTRUCTION SEQUENCING IS ANTICIPATED TO BEGIN WITH PRIVATE WET UTILITY INSTALLATIONS AND TRENCH/ROADWAY RESTORATION FOLLOWED BY OVERLOT SURFACE ROUGHENING AND GRADING, UTILITY SERVICE INSTALLATIONS AND STUBBING FOUNDATION EXCAVATION, THEN VERTICAL CONSTRUCTION OF THE BUILDING. PAVING AND FLATWORK ARE TO OCCUR DURING VERTICAL CONSTRUCTION. PERMANENT STABILIZATION AND LANDSCAPING ARE ANTICIPATED TO OCCUR IN SUMMER OF 2023. INITIAL, INTERIM, AND FINAL EROSION AND SEDIMENT CONTROL MEASURES ARE TO BE IN PLACE DURING CONSTRUCTION ACTIVITY PER CITY APPROVED G.E.C. PLAN AND STORMWATER MANAGEMENT PLAN.
- RENTERS SHOULD BE NOTIFIED THAT PARKING ON ADJACENT PROPERTIES IS NOT ALLOWED. VIOLATION OF PARKING BETWEEN THIS PROJECT AND ADJACENT PROPERTIES WILL BE A CIVIL ISSUE. PER CITY CODE SECTION 7.4.204(C)(1)(D)(1) "SHARED PARKING AGREEMENTS MUST BE MEMORIALIZED IN A WRITTEN AGREEMENT THAT PROVIDES FOR SHARED PARKING AND THE WRITING IS RECORDED IN THE OFFICE OF THE COUNTY CLERK AND RECORDER."
- 21. THE PROPOSED PRIVATE FULL SPECTRUM DETENTION BASIN IS TO BE OWNED AND MAINTAINED BY THE ESTABLISHED HOMEOWNER'S ASSOCIATION.



Call before you dig

ONLY AND HAVE NOT BEEN DEPENDENTLY VERIFIED BY T WNER OR ITS REPRESENTATI LLY RESPONSIBLE FOR UNDERGROUND UTILITIES

TRUCTION SITE SAFETY IS <u>IRACTOR;</u> NEITHER THE OWN DR THE ENGINEER SHALL BE EXPECTED TO ASSUME AN' ESPONSIBILITY FOR SAFETY WORK, OF PERSONS ENG N THE WORK, OF ANY NEARBY TRUCTURES, OR OF ANY OTHE PERSONS.

OPYRIGHT © 2024 ATWELL LLC REPRODUCTION SHALL BE MAD WITHOUT THE PRIOR WRITTEN CONSENT OF ATWELL LLC

OWN OLOT MEN

08/16/2022


ST SUBMITTAL TO CITY


REVISIONS


EAF HCH. KME


. KMB в 21002776

01

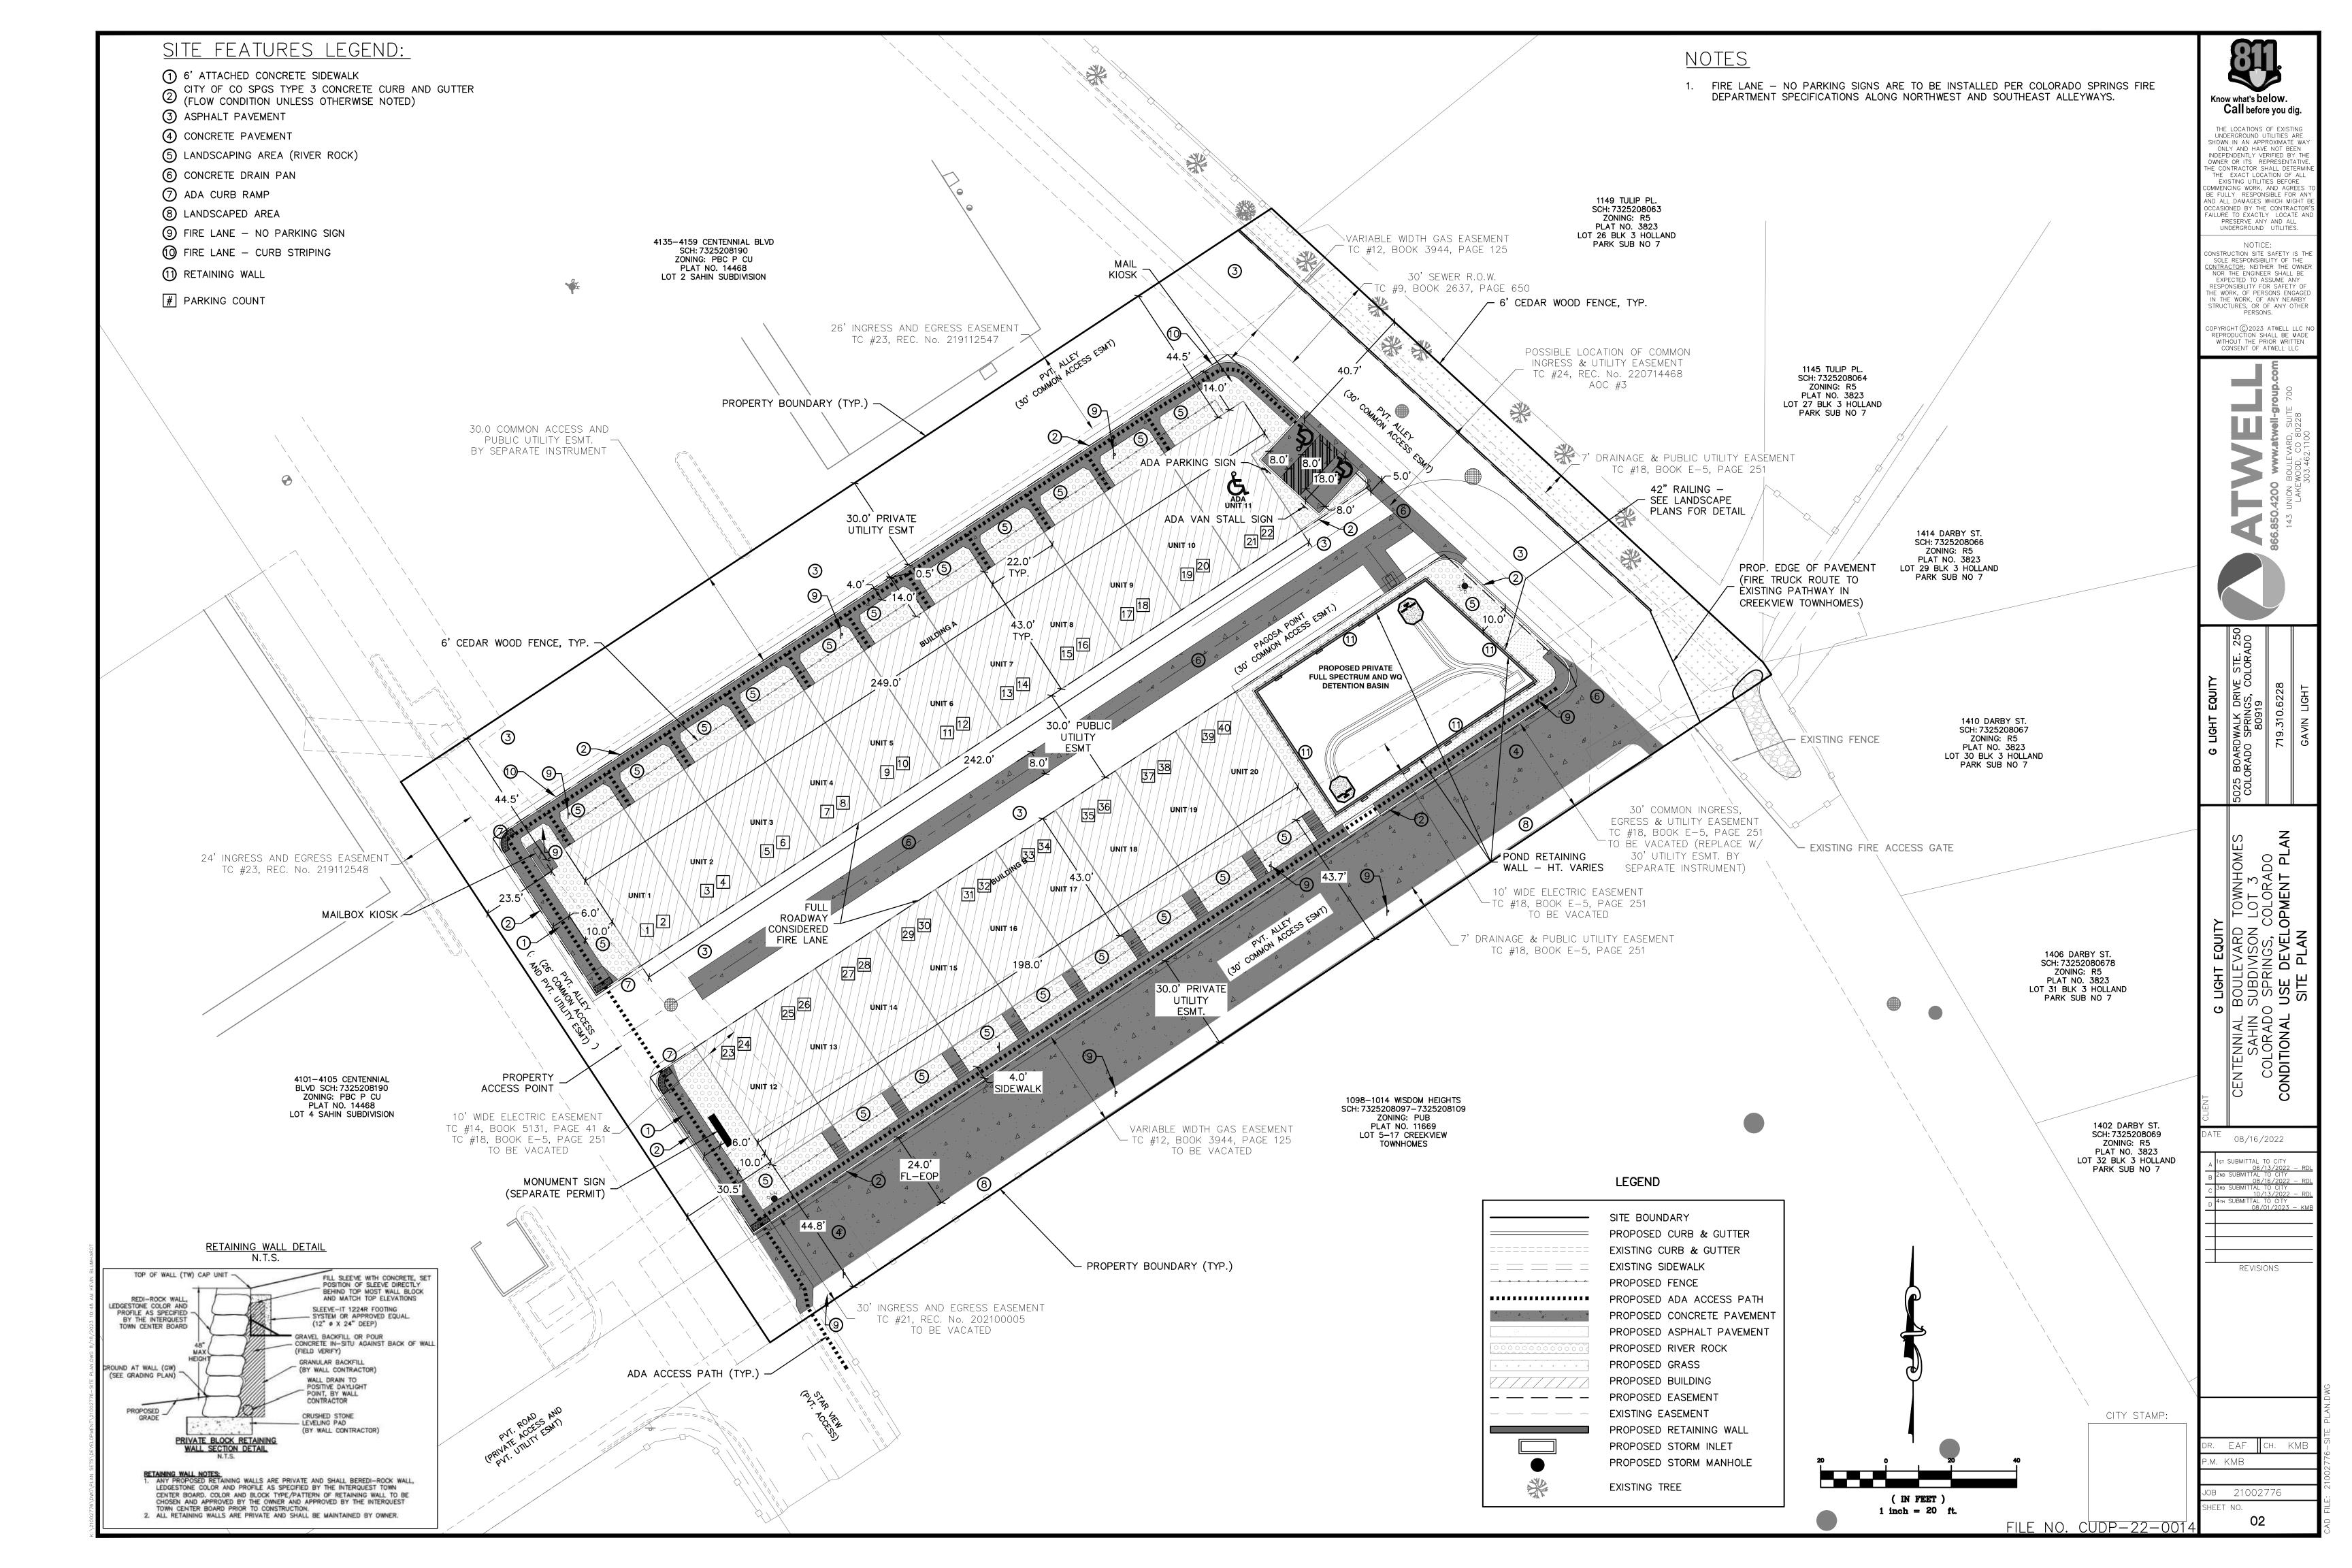

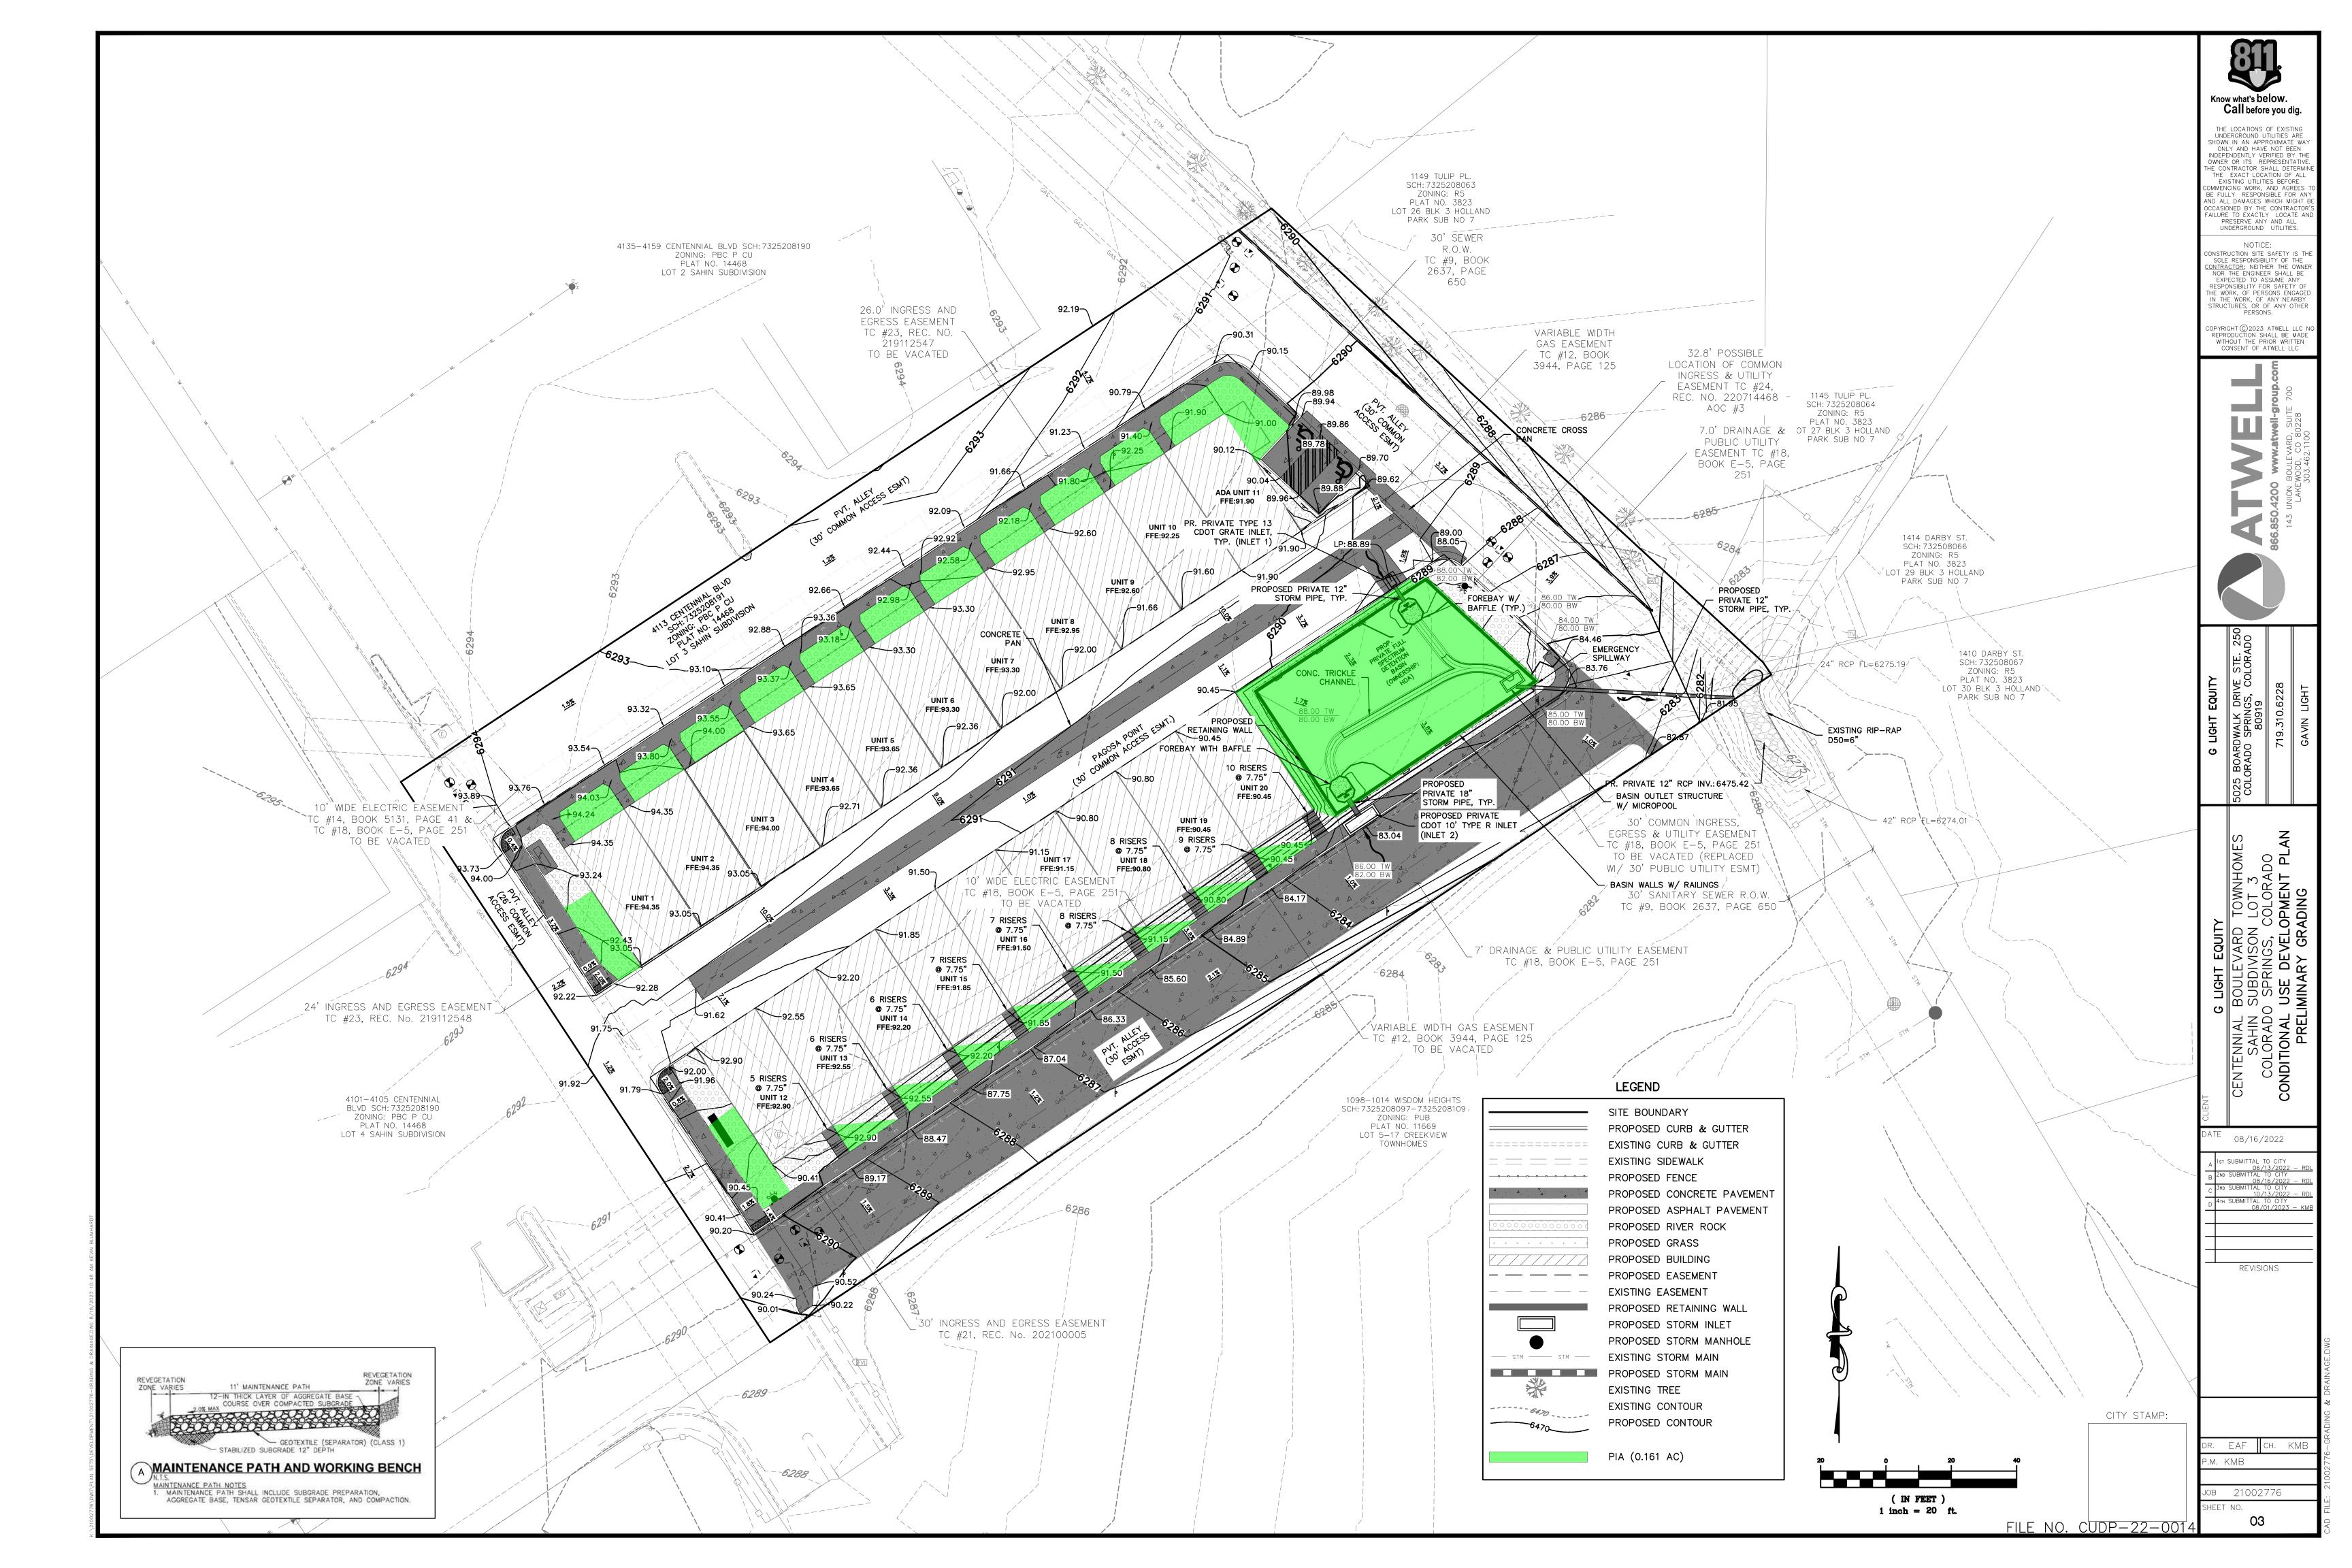

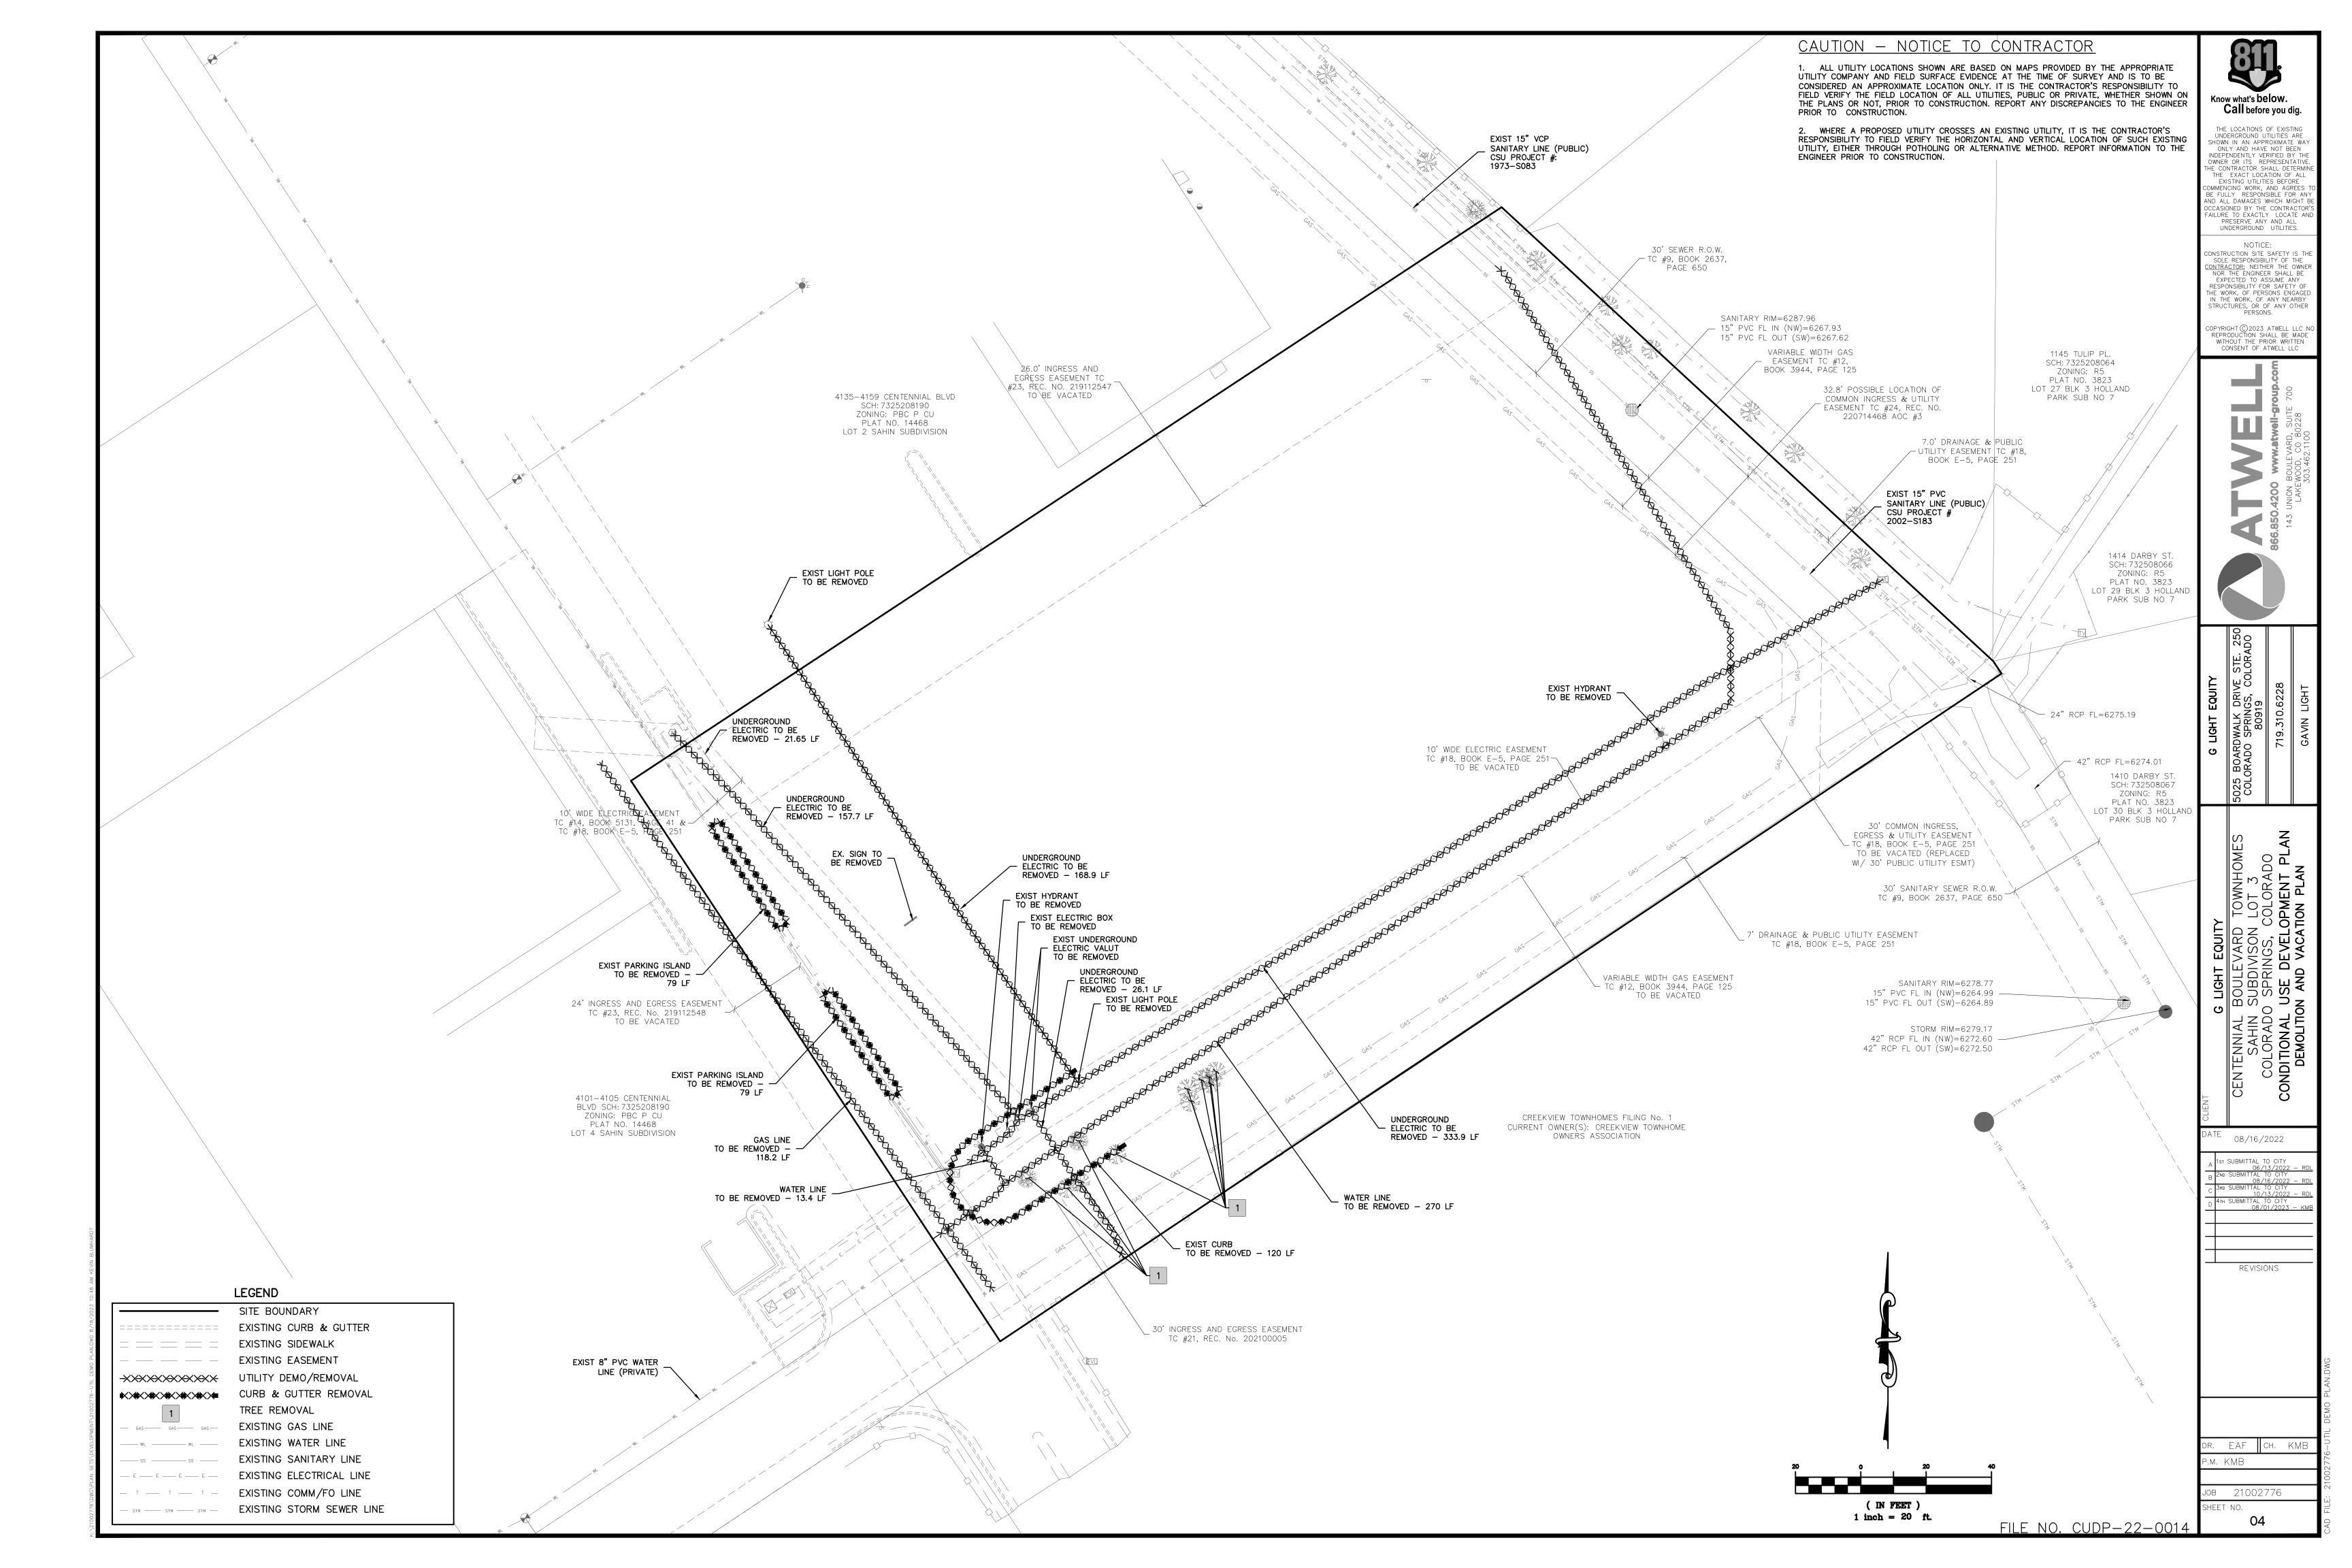

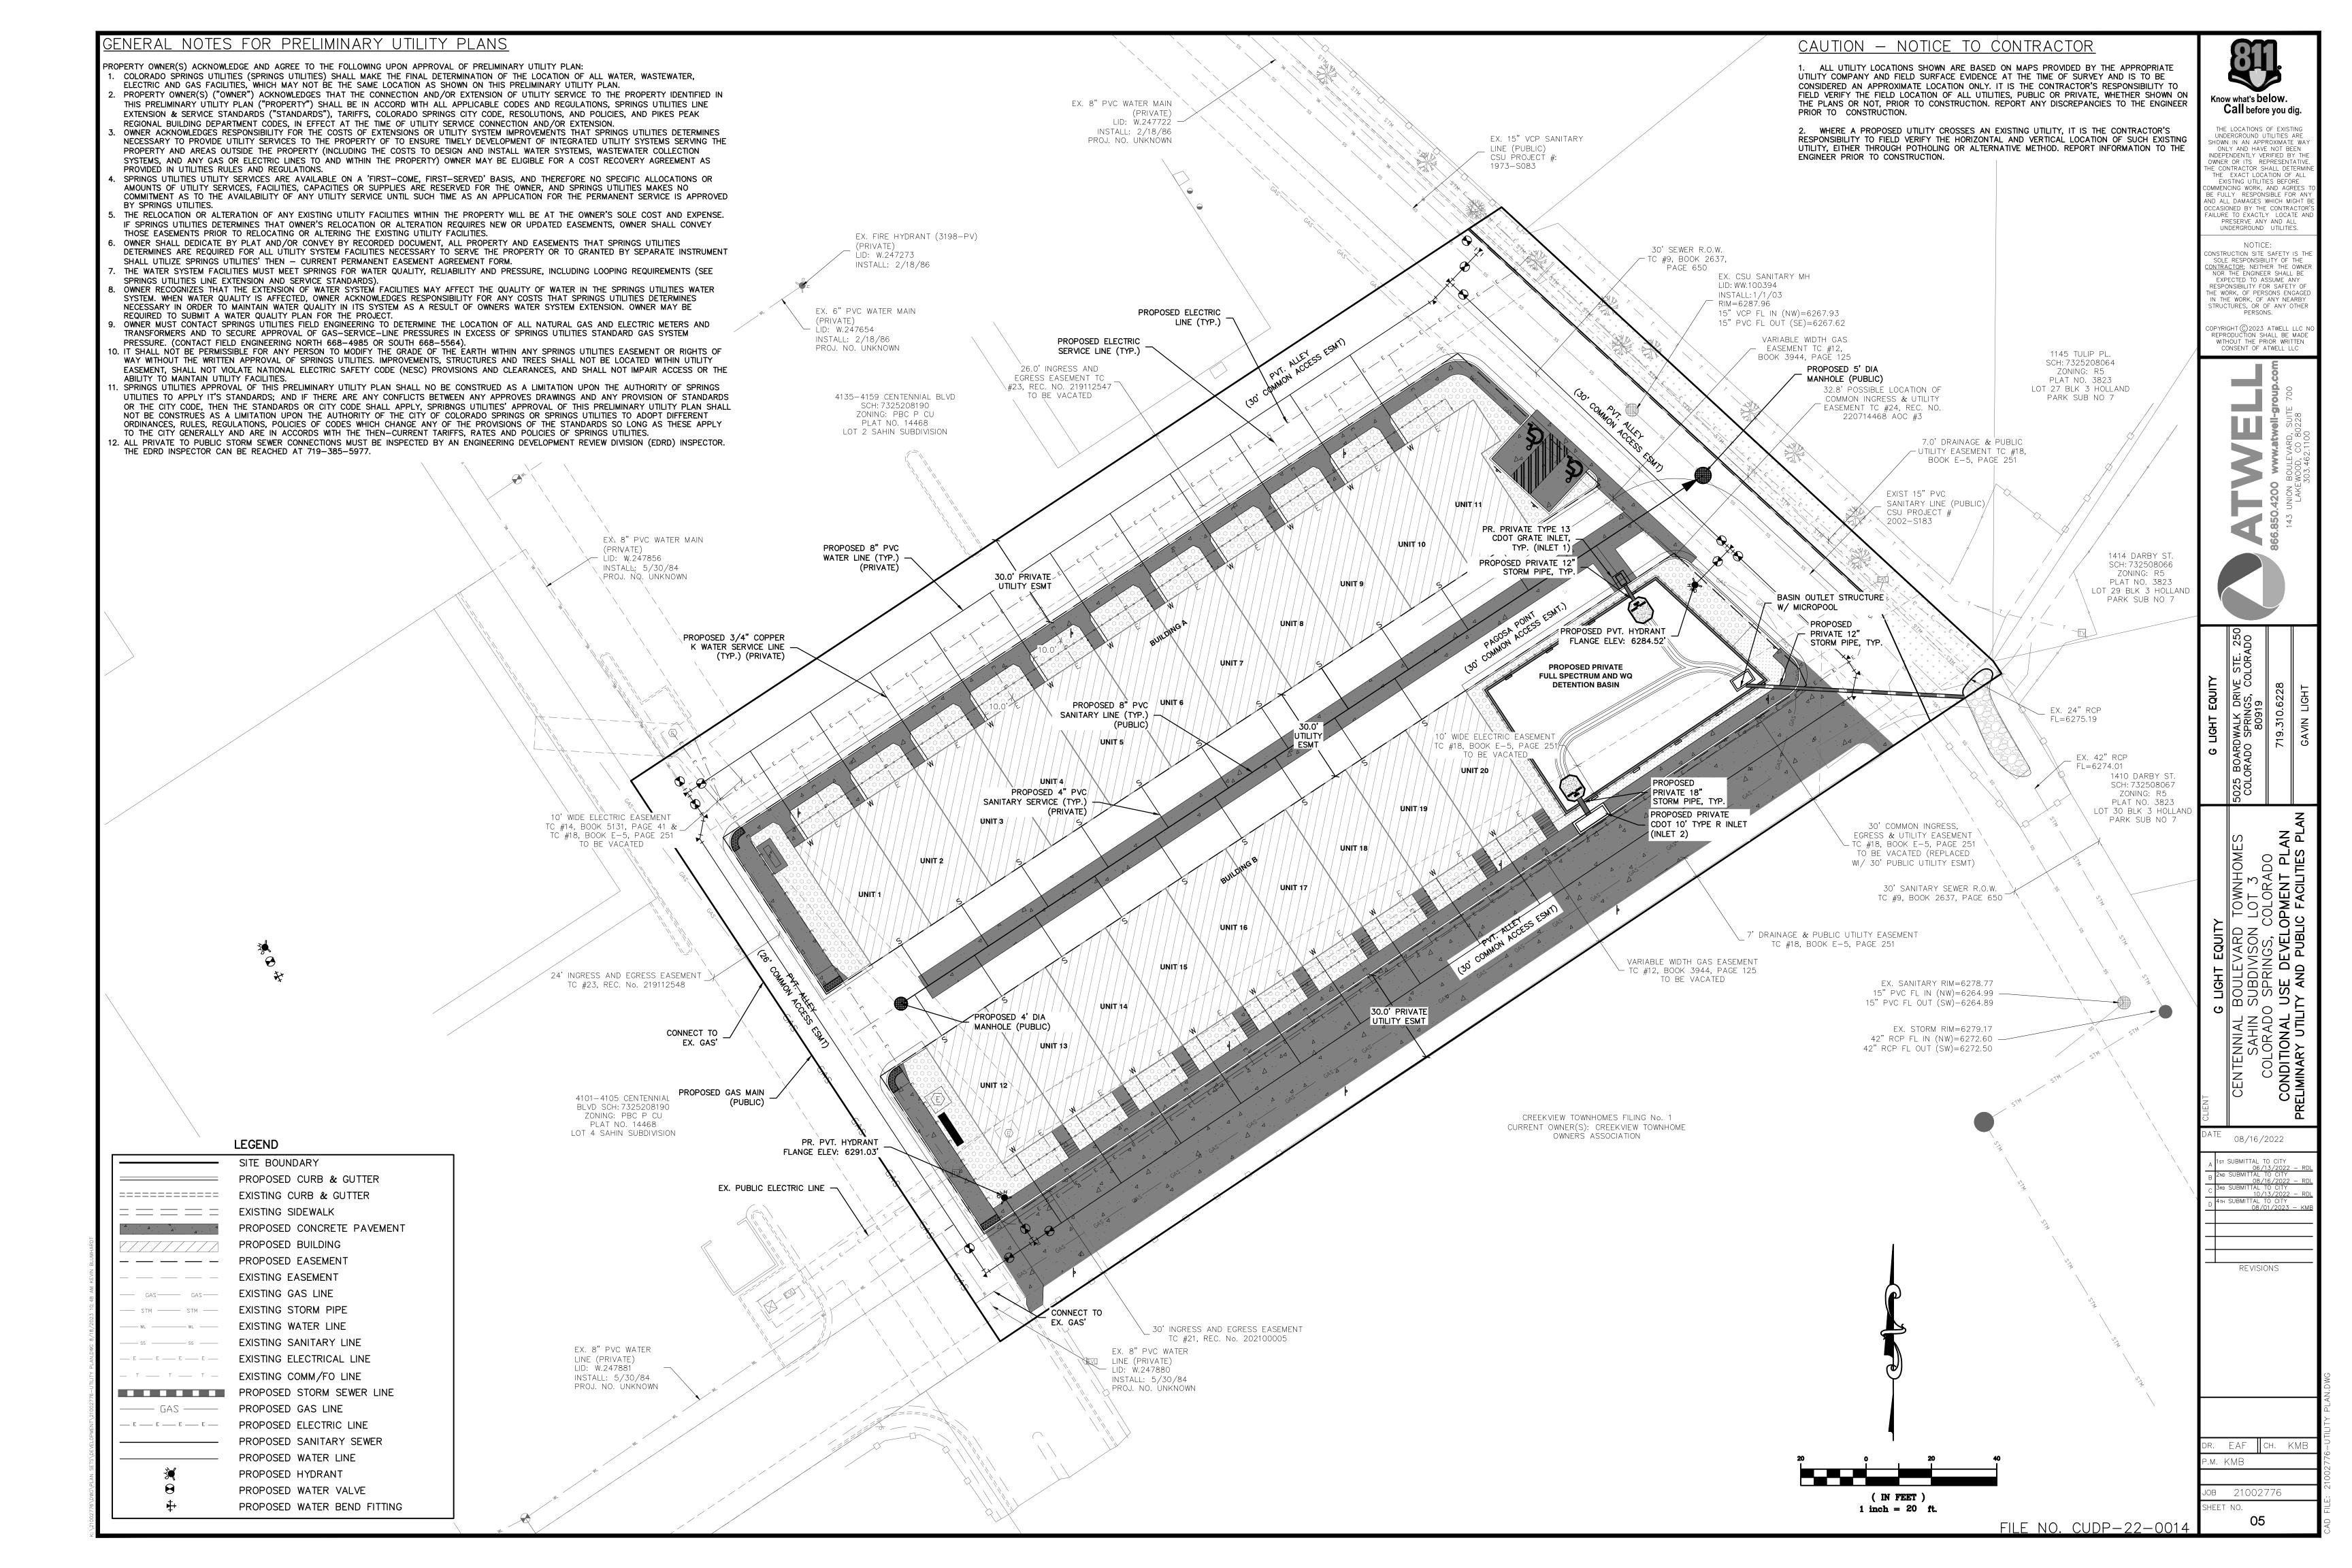

SCHEMATIC LANDSCAPE DIAGRAM

CLIMATE ZONE

FOOTHILLS FOOTHILLS AND PLAINS PLAINS

PLANT COMMUNITIES

- 1 SEMIARID SHRUBLANDS 2 - PINON-JUNIPER WOODLANDS
- 3 PRAIRIE
- 4 LOWER ELEVATION RIPARIAN
- 5 FOOTHILL SHRUBLANDS 6 - PONDEROSA PINE FOREST
- 7 UPPER ELEVATION RIPARIAN
- 8 DOUGLAS-FIR FOREST

HYDROZONES

- V VERY LOW (0 TO 7 INCHES PER YEAR)
- (7 TO 15 INCHES PER YEAR) M - MODERATE
- (15 TO 25 INCHES PER YEAR) H - HIGH

(25+ INCHES PER YEAR)

LANDSCAPE SITE REQUIREMENTS

LANDSCAPE BUFFERS										
PL	AN	STREET NAME/	BUFFER DEF	PTH	LINEAR					
ABR	EV	ZONE BOUNDARY	REQ.	PROV.	FOOTAGE					
\	ΝB	WEST BOUNDARY	15'	0' *	206'					
	NB	NORTH BOUNDARY	15'	0' *	320'					
	EΒ	EAST BOUNDARY	15'	12' *	210'					
ABR	EV NB NB	ZONE BOUNDARY WEST BOUNDARY NORTH BOUNDARY	REQ. 15' 15'	PROV. 0' * 0' *	FOOTAGE 206' 320'					

	NO. OF TREES	S (1/20')	EVERGREEN	TREES	% LIVE GROUND PLANE		
	REQ. PROV.		REQ.(50%)	PROV.	REQ.	PROV.	
WB	11	11	6	6	75%	75%	
NB	16	16	8	11	75%	75%	
EB	11	11	6	8	75%	75%	

INTERNA	٩L				
PLAN	NET SITE	INTERNAL	INTERNAL A	REA	
ABREV	AREA (SF)	AREA %	REQ.	PROV.	
INI	70.405	150/	10 561 SE	12 104 SE	

VERTICAL PICKETS

NO. OF TREES (1/500)		SHRUB SUBSTITUTES		ORN GRASSES SUBS.		% LIVE GROUND PLANE	
REQ. PROV.		REQ.	PROV.	REQ.	PROV.	REQ.	PROV.
22	11	110	90	40	40	75%	75%

· b · · b · ba

8'-0" O.C. TYP.

* ALTERNATIVE COMPLIANCE REQUESTED

ENTITLEMENT NOTES

- 1. LANDSCAPE IMPROVEMENTS AND MAINTENANCE SHALL BE THE RESPONSIBILITY OF THE HOA.
- 2. ALL NATIVE SEED AREAS AS ILLUSTRATED ON THE DRAWINGS, UNLESS OTHERWISE NOTED, TO BE PERMANENTLY IRRIGATED VIA AN AUTOMATED SYSTEM OF GEAR DRIVEN ROTORS AND/ OR POP-UP SPRAYS. EXACT AREAS OF IRRIGATED NATIVE SEED TO BE DETERMINED WITH THE FINAL LANDSCAPE PLAN/FINAL IRRIGATION PLAN.
- 3. NO MATERIAL SUBSTITUTIONS SHALL BE MADE WITHOUT LANDSCAPE ARCHITECT'S APPROVAL. ALTERNATE MATERIALS OF SIMILAR SIZE AND CHARACTER MAY BE CONSIDERED IF SPECIFIED PLANT MATERIALS CANNOT BE OBTAINED. OWNER'S REPRESENTATIVE RESERVES THE RIGHT TO REVISE PLANT LIST AS DEEMED NECESSARY.

GENERAL NOTES

PRIOR TO BEGINNING ANY WORK ON THE SITE, THE CONTRACTOR SHALL CONTACT THE OFFICE OF THE OWNER'S REPRESENTATIVE FOR SPECIFIC INSTRUCTIONS RELEVANT TO THE SEQUENCING OF WORK.

READ THOROUGHLY AND BECOME FAMILIAR WITH THE DRAWINGS. NOTATIONS. DETAILS AND SPECIFICATIONS FOR THIS AND RELATED

- WORK PRIOR TO CONSTRUCTION.
- LANDSCAPE CONTRACTOR SHALL PROVIDE ALL LABOR, MATERIALS AND SERVICES NECESSARY TO FURNISH AND INSTALL LANDSCAPE ELEMENTS AND PLANTINGS AS SPECIFIED HEREIN AND AS SHOWN ON THESE PLANS.
- REPORT ANY DISCREPANCIES IN THE LANDSCAPE PLANS IMMEDIATELY TO THE OWNER/ OWNER'S REPRESENTATIVE.
- 5. NO MATERIAL SUBSTITUTIONS SHALL BE MADE WITHOUT LANDSCAPE ARCHITECT'S APPROVAL. ALTERNATE MATERIALS OF SIMILAR SIZE AND CHARACTER MAY BE CONSIDERED IF SPECIFIED PLANT MATERIALS CANNOT BE OBTAINED. OWNER'S REPRESENTATIVE RESERVES THE RIGHT TO REVISE PLANT LIST AS DEEMED NECESSARY.
- ALL PLANT LOCATIONS ARE APPROXIMATE, ADJUST AS NECESSARY TO AVOID CONFLICTS.
- 7. QUANTITIES OF MATERIALS SHOWN IN PLANT SCHEDULE TAKE PRECEDENCE OVER QUANTITIES SHOWN ON THE LANDSCAPE PLAN. LANDSCAPE CONTRACTOR SHALL BE RESPONSIBLE FOR VERIFYING ALL QUANTITIES IN PLANT SCHEDULE.
- 8. CONTRACTOR SHALL LOCATE ALL UTILITIES BEFORE WORK. UTILITIES HAVE BEEN SHOWN ON PLAN FOR ROUGH LOCATION OF SERVICES. LOCATE EXACT UTILITY LOCATIONS BY CONTACTING "CALL BEFORE YOU DIG" AT (800) 922-1987 OR 811. CONTRACTOR WILL BE RESPONSIBLE FOR THE REPAIR OF ANY DAMAGE HE MAY CAUSE TO UTILITIES.
- 9. REMOVE ALL RUBBISH, EQUIPMENT AND MATERIAL AND LEAVE THE AREA IN A NEAT, CLEAN CONDITION EACH DAY. MAINTAIN PAVED AREAS UTILIZED FOR HAULING EQUIPMENT AND MATERIALS BY OTHER TRADES IN A CLEAN AND UNOBSTRUCTED CONDITION AT ALL TIMES.
- 10. STORAGE OF ANY MATERIALS, BUILDINGS, VEHICLES OR EQUIPMENT, FENCING AND WARNING SIGNS SHALL BE MAINTAINED THROUGHOUT THE SITE WORK AND CONSTRUCTION PERIODS BY THE CONTRACTOR.
- 11. CONTRACTOR TO UTILIZE STOCKPILED TOPSOIL FROM GRADING OPERATION AS AVAILABLE. TILL INTO TOP 6" OF SOIL. FOR GRADING SEE CIVIL ENGINEER DRAWINGS.
- 12. A 3' DIAMETER CLEAR SPACE SPACE SHALL BE MAINTAINED AROUND ALL FIRE HYDRANTS.

BE PER DRAWINGS, WITH PROPER ON-CENTER SPACING BETWEEN PLANTS.

TREE AND SHRUB PLANTING NOTES

- 1. ALL TREE AND SHRUB LOCATIONS ARE APPROXIMATE; ADJUST AS NECESSARY TO AVOID CONFLICTS. PLANTING LOCATIONS OF SHRUBS, GRASSES, AND PERENNIALS AS SPECIFIED. OBTAIN OWNER'S REPRESENTATIVE'S APPROVAL OF LOCATIONS PRIOR TO PLANTING TREES AND SHRUBS.
- 2. ALL PLANT MATERIAL SHALL BE WELL-FORMED AND DEVELOPED IN GOOD CONDITION, HEALTHY AND DISEASE-FREE, AND BE TYPICAL OF THE SPECIES. PLANTS SHALL COMPLY IN ALL APPLICABLE RESPECTS WITH ACCEPTABLE STANDARDS AS SET FORTH IN THE COLORADO NURSERY ACT OF 1965 - TITLE 35, ARTICLE 25, CRS 1974 (SEE LANDSCAPE THE NURSERY ACT).
- OWNER AND OWNER'S REPRESENTATIVE RESERVES THE RIGHT TO REJECT AT ANY TIME OR PLACE PRIOR TO FINAL ACCEPTANCE OF WORK, ANY AND ALL PLANTS WHICH, IN THEIR OPINION, FAIL TO MEET THE REQUIREMENTS OF THE SPECIFICATIONS.
- 4. AT THE COMPLETION OF PLANTING OPERATIONS ALL PLANTS SHALL BE INSPECTED BY THE OWNER AND OWNER'S REPRESENTATIVE CONTRACTOR SHALL REPLACE IMMEDIATELY ANY PLANTS NOT IN HEALTHY AND VIGOROUS CONDITION AT THAT TIME AT NO EXPENSE TO THE OWNER. ANY PLANT NOT IN HEALTHY CONDITION DURING THE WARRANTY PERIOD SHALL BE REPLACED AS PER THE ORIGINAL SPECIFICATIONS, AT NO CHARGE TO THE OWNER.
- 5. PLANTING BEDS RECEIVING MULCH ARE TO BE FREE OF WEEDS AND GRASS. WOOD MULCH IS TO BE SHREDDED CEDAR WOOD MULCH UNLESS OTHERWISE SPECIFIED. POROUS WEED BARRIER FABRIC, SHALL BE INSTALLED WHERE NOTED IN THE DETAILS.
- PLANT GROUND COVER WITHIN ONE FOOT (1') OF TRUNK OF TREES OR SHRUBS PLANTED WITHIN AREA. PLANTING ARRANGEMENT SHALL
- 7. ALL PLANT MATERIALS SHALL HAVE BACKFILL CAREFULLY PLACED AROUND BASE AND SIDES OF BALL TO TWO-THIRDS (2/3) DEPTH OF BALL THEN THOROUGHLY SOAKED WITH WATER TO ALLOW SETTLEMENT. ALL WIRE. BURLAP FASTENERS AND LOOSE BURLAP AROUND BASE OF TRUNK SHALL BE REMOVED AT THIS TIME. REMAINDER OF PIT SHALL THEN BE BACKFILLED, ALLOWING FOR DEPTH OF MULCH, SAUCER AND 11. SETTLEMENT OF BACKFILL. BACKFILL SHALL THEN BE THOROUGHLY WATERED AGAIN.
- 8. LANDSCAPE CONTRACTOR TO REMOVE TREE STAKES, TREE WRAP, AND ALL DEAD WOOD ON TREES AND SHRUBS ONE YEAR AFTER PROVISIONAL ACCEPTANCE
- 9. ALL WORK ON TREES TO REMAIN, INCLUDING CROWN AND ROOT PRUNING SHALL BE PERFORMED BY A TREE SERVICE LICENSED BY THE CITY FORESTER.
- 10. THE CONTRACTOR SHALL PROVIDE ALL WATER, WATERING DEVICES AND LABOR NEEDED TO IRRIGATE PLANT MATERIALS UNTIL AUTOMATIC IRRIGATION SYSTEMS ARE OPERATIONAL AND ACCEPTED. THE CONTRACTOR SHALL SUPPLY ENOUGH WATER TO MAINTAIN THE PLANT'S HEALTHY CONDITION BASED ON SEASONAL CONSIDERATIONS.
- 11. ALL PLANT MATERIALS SHALL BE PROTECTED FROM THE DRYING ACTION OF THE SUN AND WIND AFTER BEING DUG, WHILE BEING TRANSPORTED, AND WHILE AWAITING PLANTING. BALLS OF PLANTS THAT CANNOT BE PLANTED IMMEDIATELY SHALL BE PROTECTED FROM DRYING ACTION BY COVERING THEM WITH MOIST MULCH. PERIODICALLY, APPLY WATER TO MULCH-COVERED BALLS TO KEEP MOIST. IF PLANTING SHOULD OCCUR DURING GROWING SEASON, APPLY ANTI-DESICCANT TO LEAVES BEFORE TRANSPORT TO REDUCE LIKELIHOOD OF WINDBURN. REAPPLY ANTI-DESICCANT AFTER PLANTING TO REDUCE TRANSPIRATION.
- 12. AFTER PLANTING IS COMPLETED, REPAIR INJURIES TO ALL PLANTS AS REQUIRED. LIMIT AMOUNT OF PRUNING TO A MINIMUM NECESSARY TO REMOVE DEAD OR INJURED TWIGS AND BRANCHES. PRUNE IN SUCH A MANNER AS NOT TO CHANGE NATURAL HABIT OR SHAPE OF PLANT. CENTRAL LEADERS SHALL NOT BE REMOVED.

8'-0" O.C. (STANDARD FENCE SECTION)

SODDING AND SEEDING NOTES

- CONTRACTOR IS RESPONSIBLE FOR MAINTAINING EXISTING EROSION CONTROL MEASURES DURING THE DURATION
- GENERAL CONTRACTOR SHALL PROVIDE 4" OF TOPSOIL AT ALL SOD AND PLANTING AREAS IN ADDITION TO ANY REQUIRED SOIL AMENDMENTS. GRADE SHALL BE ADJUSTED FOR SOD/ GROUND COVER THICKNESS. ALL FINISH GRADING SHALL BE PERFORMED BY LANDSCAPE CONTRACTOR.
- FINE GRADE SOD AREAS TO ELIMINATE IRREGULARITIES ON THE SURFACE. ROLL OR PERFORM ADDITIONAL FINE GRADING.
- ALL AREAS TO BE SEEDED SHALL BE TILLED AS SPECIFIED AND THEN HARROWED, RAKED OR ROLLED TO PRODUCE A FIRM SEED BED FOR PLANTING. IMPORTED TOPSOIL MAY BE REQUIRED TO PROVIDE AN ACCEPTABLE PLANTING MEDIUM. LARGE ROCKS (1 INCH DIAMETER) AND DEBRIS THAT MAY IMPEDE SEEDING SHALL BE CLEARED FROM THE SITE. ANY REQUIRED EROSION CONTROL FEATURES (E.G., WATER BARS, BERMS, BASINS, TURNOUTS) SHALL BE CONSTRUCTED PRIOR TO SEEDING. SITES THAT ARE NOT ADEQUATELY PREPARED PRIOR TO SEEDING (E.G., COMPACTED SOIL, INSUFFICIENT TOPSOIL, ROCKY, ERODED SURFACE, ETC.) SHALL BE REJECTED.
- ALL SPECIFIED SEED MIXES SHALL CONSIST OF CERTIFIED SEED VARIETIES THAT ARE FREE OF NOXIOUS WEEDS AND HAVE BEEN TESTED FOR PURITY AND GERMINATION WITHIN SIX MONTHS OF THE PLANTING DATE. CERTIFICATION LABELS WHICH INDICATE THE SPECIES, PURITY, GERMINATION, WEED CONTENT, ORIGIN, AND TEST DATE SHALL BE SUBMITTED FOR ALL SEED MATERIALS.
- SEEDING SHALL OCCUR DEPENDING ON THE PROJECT SCHEDULE, IT IS PREFERABLE THAT SEEDING OCCUR DURING THE FALL (SEPTEMBER-NOVEMBER) OR SPRING (MARCH-MAY) TO MAXIMIZE PLANTING SUCCESS. IF THE PROJECT SCHEDULE DOES NOT COINCIDE WITH THE PREFERRED SEEDING PERIODS, OR IF THERE ARE UNSUITABLE SITE CONDITIONS (I.E. FROZEN GROUND), THEN SOIL STABILIZATION AND/OR STORM WATER BEST MANAGEMENT PRACTICES SHALL BE IMPLEMENTED TO STABILIZE THE AREA UNTIL THE NEXT APPROPRIATE SEEDING DATE. ANY SEEDING CONDUCTED OUTSIDE THE PREFERRED MONTHS SHALL BE APPROVED BY THE OWNER.
- SEEDING METHOD: DRILL SEEDING OR BROADCAST SEEDING SHALL BE USED. AS OUTLINED BELOW, THE SIZE AND SLOPE OF THE SEEDED AREA SHALL DETERMINE WHICH SEEDING METHOD(S) IS APPROPRIATE AND ACCEPTABLE. REFER TO MANUFACTURER'S SPECIFICATIONS FOR ADJUSTING SEEDING RATES FOR APPLICATIONS DIFFERING FROM THE SEED MIX TABLE.
- A. SLOPES LESS THAN 3:1 SEED SHALL BE PLANTED USING A RANGELAND DRILL. SEEDING SHALL BE ACCOMPLISHED USING BI-DIRECTIONAL DRILLING AND FOLLOWING THE SLOPE CONTOUR. THE DRILL EQUIPMENT SHALL BE CALIBRATED EACH DAY OR WHENEVER THERE IS A CHANGE IN THE SEED MIX TO ENSURE PROPER SEED DISTRIBUTION AND RATE.
- SLOPES GREATER THAN 3:1 OR AREAS LESS THAN 0.10 ACRE SEED SHALL BE BROADCAST BY HAND OR MECHANICAL SPREADER. BROADCAST SEEDED AREAS SHALL BE RAKED OR HARROWED TO INCORPORATE THE SEED INTO THE SOIL AT A DEPTH NOT EXCEEDING 0.75 INCHES.
- BROADCAST SEEDING SHALL BE AVOIDED WHEN WIND SPEED EXCEEDS 15 MILES PER HOUR.
- ALTERNATIVE METHODS TO BE REVIEWED AND APPROVED BY OWNER OR LANDSCAPE ARCHITECT.
- FINE GRADE SEED TO ELIMINATE IRREGULARITIES ON THE SURFACE. ROLL OR PERFORM ADDITIONAL FINE GRADING. SEED AREAS BY MEANS OF APPROVED BROADCAST OR HYDRAULIC-TYPE SPREADERS. DO NOT SEED DURING WINDY WEATHER
- WEED-FREE NATIVE HAY, WEED-FREE STRAW, OR VIRGIN WOOD FIBER HYDRO-MULCH SHALL BE USED PER NOTES BELOW TO CONTROL EROSION AND PROMOTE SEED GERMINATION AND PLANT ESTABLISHMENT. NATIVE HAY, STRAW, OR HYDRO-MULCH SHALL BE APPLIED PER SEED SUPPLIER'S RECOMMENDATIONS FOR OPTIMAL GROWTH PER SEED MIX TYPE AND SLOPE.
- HYRDO-MULCHING: ALL IRRIGATED SEEDING SHALL BE HYDRO MULCHED. ORGANIC TACKIFIER SHALL BE USED. MULCH SEEDED AREAS WITHIN 24 HOURS OF SEEDING. HYDRO-MULCH SHALL BE APPLIED USING A COLOR DYE AND THE MANUFACTURER'S RECOMMENDED RATE OF AN ORGANIC TACKIFIER.
- STRAW CRIMPING: ALL NON-IRRIGATED OR TEMPORARILY IRRIGATED TO BE NATIVE HAY OR STRAW CRIMPED INTO THE SOIL TO A DEPTH OF AT LEAST 3 INCHES, AND SHALL PROTRUDE ABOVE THE GROUND AT LEAST 3
- C. ALTERNATIVE METHODS TO BE REVIEWED AND APPROVED BY OWNER OR LANDSCAPE ARCHITECT
- EROSION CONTROL BLANKETS ARE TO BE APPLIED ON SLOPES 3:1 AND GREATER
- 10. IF A WATER HOOK-UP IS AVAILABLE A SPRINKLER SYSTEM MAY BE USED TO PROMOTE RAPID PLANT ESTABLISHMENT. GENERALLY. WATERING AT 0.75-1.0 INCHES/WEEK IS RECOMMENDED DURING THE APRIL-OCTOBER GROWING SEASON DEPENDING ON NATURAL RAINFALL. THE USE OF WATER TRUCKS FOR IRRIGATION IS PROHIBITED DUE TO TRAFFIC IMPACTS ON THE SEEDED AREAS AND TYPICAL POOR WATER DISTRIBUTION OBSERVED WITH THIS TYPE OF WATERING.
- APPROVAL OF SEEDED TURF AREAS SHALL BE BASED UPON THE SEED PRODUCERS GUARANTEED SEEDING GERMINATION RATE FOR A ONE SQUARE FOOT AREA. IF GUARANTEED GERMINATION RATE IS NOT ACHIEVED, THE CONTRACTOR SHALL OVERSEED UNTIL THE GERMINATION RATE IS ACHIEVED. REVEGETATION SHALL HAVE AT LEAST 3 NATIVE GRASS SEEDLINGS/SQUARE FOOT AND NO BARE AREAS EXCEEDING ONE SQUARE METER AFTER THE SECOND GROWING SEASON. FOR DRILL SEEDED AREAS, PLANTING ROWS SHALL BE NOTICEABLE BY THE END OF THE FIRST FULL GROWING SEASON. IF A PARTIAL OR TOTAL SEEDING FAILURE IS APPARENT AFTER THE SECOND GROWING SEASON, POORLY VEGETATED AREAS SHALL BE RESEEDED IN THE SAME MANNER DESCRIBED ABOVE. APPROPRIATE SITE PREPARATION PRACTICES SHALL BE USED TO CREATE A SUITABLE SEEDBED FOR PLANTING, BUT ANY ESTABLISHED NATIVE VEGETATION SHALL BE UNDISTURBED TO THE EXTENT POSSIBLE. AREAS THAT ERODE BEFORE GERMINATION AND ESTABLISHMENT CAN OCCUR SHALL BE REPAIRED AND IMMEDIATELY RESEEDED DURING THE SAME SEASON.
- ALL BARE AREAS TO BE RESEEDED WITH PROPER REMOVAL OF WEEDS. ALL NATIVE SEED AREAS ARE TO MEET STANDARD LOCAL JURISDICTION REQUIREMENTS FOR GERMINATION AND ESTABLISHMENT

- INTO TOP 6-8" OF SOIL. COMPOST TO BE TYPE I CONSISTING OF 1-YEAR OLD ORGANIC MATERIAL AND SHALL NOT INCLUDE CHICKEN MANURE.
- 2. CONTRACTOR TO APPLY FERTILIZERS AS RECOMMENDED PER THE SOILS ANALYSIS.

NITRATE:

SULFATE: 1 LBS PER 1000SF

0.2 LBS PER 1000SF

TOP OF

REMAIN

PARALLEL

WITH FINISH

GRADE, TYP.

- FINISH GRADE

TYP

CONCRETE

FOOTER PER

MANUFACTURER

SPECIFICATIONS,

RAILING TO

0.06 LBS PER 1000SF

BORON: 0.01 LBS PER 1000SF

SOIL AMENDMENT NOTES

- 1. CONTRACTOR TO APPLY TO ALL AREAS 3 CY/ 1,000 SF ORGANIC MATTER COMPOST. TILL
- 3. FERTILIZER RECOMMENDATIONS:

1 LBS PER 1000SF THREE TIMES DURING THE GROWING SEASON

0.25 LBS PER 1000 SF

MAGANESE: 0.25 LBS PER 1000SF

CONSULTANTS:




2435 RESEARCH PARKWAY, SUITE 300 COLORADO SPRINGS, CO 80920 PHONE: (719) 575-0100 FAX: (719) 575-0208

OWNER/DEVELOPER:

G LIGHT EQUITY 5025 BOARDWALK DR. STE 250' COLORADO SPRINGS, CO 80919 (719) 310-6228

APPROVAL

VICINITY MAP

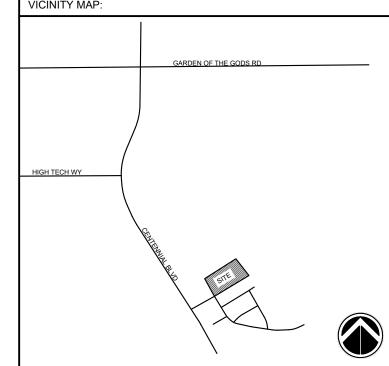

CENTENNIAL BLVD TOWNHOMES CONDITIONAL USE DEVELOPMENT PLAN **EL PASO COUNTY**

JUNE 6, 2022

SHEET TITLE

REV	ISION HISTOR	RY:	
NO.	DATE	DESCRIPTION	BY
1	8/15/2022	PER CITY COMMENTS	AV
2	10/12/2022	PER CITY COMMENTS	AV
3	4/27/2023	PER CITY COMMENTS AND CLIENT REVIEW	BP
4	8/1/23	PER CITY COMMENTS	BP

DRAWING INFORMATION: PROJECT NO: 22.1258.002 DRAWN BY: CHECKED BY: AJP APPROVED BY: AJP

> LANDSCAPE **TITLESHEET**

> > LT01

SHEET 6 OF 14

6' WOOD FENCE

MS-STD-FC-04


-2" X 4" HORIZONTAL STRINGER

" X 4" POST, BURIED 24"

FINISHED GRADE

-CONCRETE FOOTER

3'-6" METAL RAILING

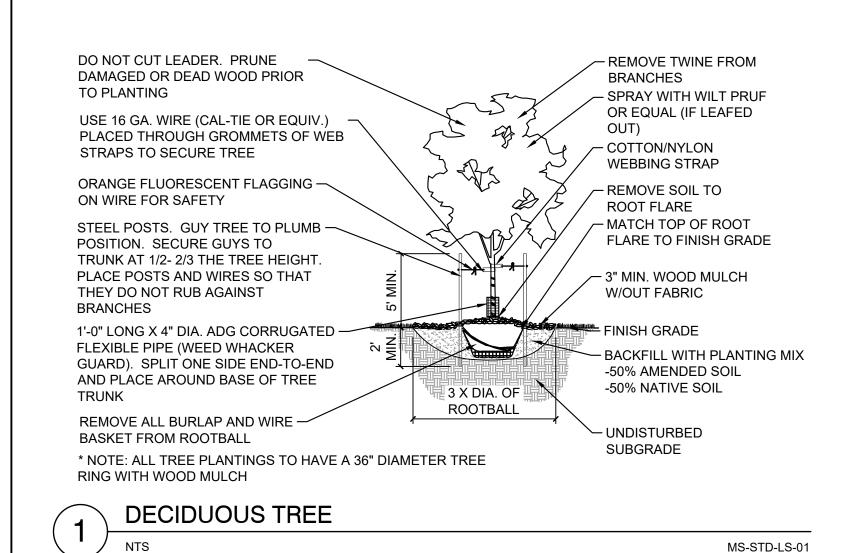


745454 ي المنافعة المارية MULCH PER PLAN, 3" MIN., FABRIC UNDER COBBLE/ROCK, WOOD MULCH W/OUT FABRIC - FINISH GRADE - BACKFILL WITH PLANTING MIX -50% AMENDED SOIL -50% NATIVE SOIL UNDISTURBED

SUBGRADE

- 1. CONTRACTOR TO WATER PLANT MATERIAL DAILY UNTIL AN AUTOMATIC IRRIGATION SYSTEM IS OPERATIONAL OR OTHER IRRIGATION PROVISIONS ARE PROVIDED.
- 2. THE FINISH GRADES SHALL PROVIDE POSITIVE DRAINAGE AWAY FROM WALLS
- AND BUILDINGS. 3. THE TILLING OF PLANTING BEDS AND PLACEMENT OF BACKFILL IS TO OCCUR JUST PRIOR TO PLANTING; THEREAFTER, PROTECTION FROM COMPACTION AND CONSTRUCTION TRAFFIC SHOULD BE PROVIDED.

MS-STD-LS-03

PLANT ORNAMENTAL GRASSES, PERENNIALS

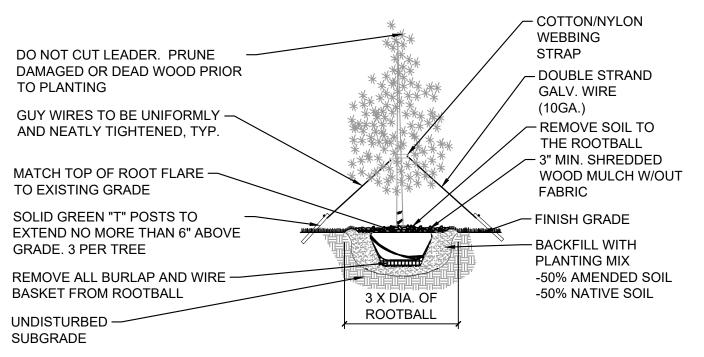

* NOTE: ALL TREE PLANTINGS TO HAVE A 36" DIAMETER TREE RING WITH WOOD MULCH

EVERGREEN TREE 3

AND GROUNDCOVER AT FINISH GRADE - MULCH PER PLAN, 3" MIN., FABRIC UNDER COBBLE/ROCK AND WOOD W/OUT FABRIC - FINISH GRADE BACKFILL WITH PLANTING MIX -50% AMENDED SOIL -50% NATIVE SOIL NOTES: - UNDISTURBED SUBGRADE

- 1. CONTRACTOR TO KEEP PLANTS MOIST AND SHADED UNTIL PLANTING. 2. CONTRACTOR TO WATER PLANT MATERIAL DAILY UNTIL AN AUTOMATIC IRRIGATION SYSTEM IS OPERATIONAL
- 3. THE FINISH GRADES SHALL PROVIDE POSITIVE DRAINAGE AWAY FROM WALLS AND
- BUILDINGS. 4. THE TILLING OF PLANTING BEDS AND PLACEMENT OF BACKFILL IS TO OCCUR JUST PRIOR TO PLANTING; THEREAFTER, PROTECTION FROM COMPACTION AND CONSTRUCTION TRAFFIC SHOULD BE PROVIDED.

MS-STD-LS-02


GRASSES AND PERENNIALS

MS-STD-LS-04

- PROVIDE A SMOOTHLY RAKED FINISH GRADE, PROVIDE POSITIVE DRAINAGE. **AMENDMENTS** - GROUNDCOVER PER NOTES PER PLAN APPLICATION **EVENLY SPREAD** TOPSOIL 4" DEEP SUBGRADE, RIP 6" DEEP

1. TOPSOIL TO CONSIST OF DARK, LIGHT LOAM SOIL FREE OF ROCKS, ROOTS, AND FOREIGN MATERIALS.

- 2. COMPOST TO BE TYPE I CONSISTING OF OF 1-YEAR OLD ORGANIC MATERIAL AND SHOULD NOT INCLUDE CHICKEN MANURE.
- 3. FROZEN MATERIALS OR MATERIALS GREATER THAN 1" DIA. SHOULD BE REMOVED.

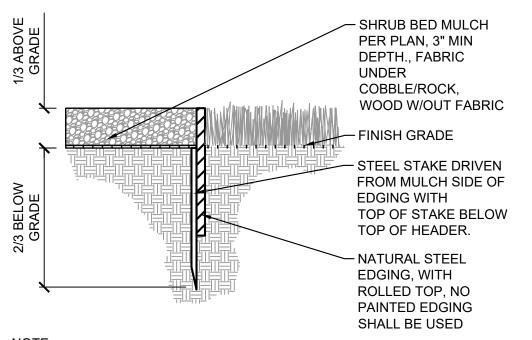

ALL SHRUB BEDS COVERED WITH WOOD MULCH AND/OR ROCK MULCH (UP TO 6" SIZE) ARE TO BE ENCLOSED WITH STEEL EDGING TO SEPARATE BEDS FROM SOD AND SEED. NO EDGING NEEDED BETWEEN SOD AND NATIVE SEED OR BETWEEN TWO MULCH TYPES UNLESS OTHERWISE SPECIFIED.

STEEL EDGING MS-STD-LS-12

EVERGREEN TREES	CODE	<u>QTY</u>	BOTANICAL / COMMON NAME	PLANT SIZE	CONTAINER	MAT. H.	MAT. W.	CITY KEY
60000000000000000000000000000000000000	JM	8	JUNIPERUS SCOPULORUM 'MOONGLOW' MOONGLOW JUNIPER	6` HT.	B&B	12`	8,	125678D
on the state of th	IF	15	PICEA PUNGENS 'ISELI FASTIGIATE' FASTIGIATE SPRUCE	6` HT.	B&B	12`	6`	678S
	TN	10	PINUS MUGO `TANNENBAUM` MUGO PINE	6` HT.	B&B	12`	8`	1256D
ORNAMENTAL TREES	CODE	<u>QTY</u>	BOTANICAL / COMMON NAME	PLANT SIZE	CONTAINER	MAT. H.	MAT. W.	CITY KEY
	MP	3	MALUS X `PRAIRIFIRE` PRAIRIFIRE CRABAPPLE	1.5" CAL.	B&B	15`	15`	467S
	AP	13	PRUNUS AMERICANA AMERICAN PLUM	1.5" CAL.	B&B	15`	10`	2345678DA
DECIDUOUS SHRUBS	CODE	QTY	BOTANICAL / COMMON NAME	PLANT SIZE	CONTAINER	<u>MAT. H.</u>	MAT. W.	CITY KEY
\odot	ARA	4	ARONIA ARBUTIFOLIA RED CHOKEBERRY	#5 CONT.	CONT.	6`	4`	47S
\odot	вта	6	BERBERIS THUNBERGII `ATROPURPUREA` RED LEAF JAPANESE BARBERRY	#5 CONT.	CONT.	4`	4`	45A
\odot	CHV	10	CHRYSOTHAMNUS VISCIDIFLORUS YELLOW RABBITBRUSH	#3 CONT.	CONT.	2`	2`	1235D
\odot	cos	10	CORNUS STOLONIFERA RED TWIG DOGWOOD	#5 CONT.	CONT.	4`	4`	457S
\odot	PAB	11	PEROVSKIA ATRIPLICIFOLIA 'BLUE SPIRES' BLUE SPIRES RUSSIAN SAGE	#5 CONT.	CONT.	4`	4`	12D
\bigcirc	PHM	16	PHYSOCARPUS MONOGYNUS MOUNTAIN NINEBARK	#5 CONT.	CONT.	3,	3,	568A
\odot	PRB	6	PRUNUS BESSEYI SAND CHERRY	#5 CONT.	CONT.	5`	5`	1345A
\bigcirc	SJL	12	SPIRAEA JAPONICA 'LITTLE PRINCESS' LITTLE PRINCESS JAPANESE SPIREA	#5 CONT.	CONT.	1`	2`	SA
EVERGREEN SHRUBS	CODE	QTY	BOTANICAL / COMMON NAME	PLANT SIZE	CONTAINER	<u>MAT. H.</u>	MAT. W.	CITY KEY
\odot	JHW	5	JUNIPERUS HORIZONTALIS 'WILTONII' BLUE RUG JUNIPER	#5 CONT.	CONT.	1.5`	6`	2568A
\odot	PMM	10	PINUS MUGO `MOPS` MUGO PINE	#5 CONT.	CONT.	2`	2`	1256D
ORNAMENTAL GRASSES	CODE	QTY	BOTANICAL / COMMON NAME	PLANT SIZE	CONTAINER	<u>MAT. H.</u>	MAT. W.	CITY KEY
AND	BOG	25	BOUTELOUA GRACILIS BLUE GRAMA GRASS	#1 CONT.	CONT.	2`	2`	1235D
MANA MANA MANA MANA MANA MANA MANA MANA	PEA	15	PENNISETUM ALOPECUROIDES FOUNTAIN GRASS	#1 CONT.	CONT.	3,	2`	А
SIGNATURE PLANTS TREES 49/49 SHRUBS 78/90	100% 86%							ŀ

SEED MIX SCHEDIII E

PLANT SCHEDULE

SEED MIX SCHE	DULE				
MIX NAME	SUPPLIER	SPECIES	CONDITION	APPLICATION METHOD	APPLICATION RATE
EL PASO COUNTY CONSERVATION DISTRICT ALL- PURPOSE LOW GROW MIX		25% BUFFALOGRASS 20% BLUE GRAMA 29% SIDEOATS GRAMA 5% GREEN NEEDLEGRASS 20% WESTERN WHEATGRASS 1% DROPSEED	IRRIGATION	PER SEEDING NOTES	42 PLS/AC HYDROSEED 21 PLS/AC DRILLED
EL PASO COUNTY CONSERVATION DISTRICT ALL- PURPOSE MIX		20% BIG BLUE STEM 10% BLUE GRAMA 10% GREEN NEEDLEGRASS 20% WESTERN WHEATGRASS 10% SIDEOATS GRAMA 10% SWITCHGRASS 10% PRAIRIE SANDREED 10% YELLOW INDIANGRASS	NON-IRRIGATED	PER SEEDING NOTES	19.3 PLS/AC HYDROSEED 9.7 PLS/AC DRILLED

2435 RESEARCH PARKWAY, SUITE 300 COLORADO SPRINGS, CO 80920 PHONE: (719) 575-0100 FAX: (719) 575-0208 OWNER/DEVELOPER: G LIGHT EQUITY 5025 BOARDWALK DR. STE 250' COLORADO SPRINGS, CO 80919 (719) 310-6228 APPROVAL: VICINITY MAP: HIGH TECH WY

CONSULTANTS:

PLANNER/ LANDSCAPE ARCHITECT/ CIVIL ENGINEER:

CENTENNIAL BLVD TOWNHOMES CONDITIONAL USE DEVELOPMENT **EL PASO COUNTY** JUNE 6, 2022

RE\	REVISION HISTORY:								
NO.	DATE	DESCRIPTION	BY						
1	8/15/2022	PER CITY COMMENTS	AV						
2	10/12/2022	PER CITY COMMENTS	AV						
3	4/27/2023	PER CITY COMMENTS AND CLIENT REVIEW	ВР						
4	8/1/23	PER CITY COMMENTS	ВР						

DRAWING INFORMATION: PROJECT NO: 22.1258.002 DRAWN BY: CHECKED BY: AJP APPROVED BY: AJP SHEET TITLE:

> LANDSCAPE **DETAILS**

> > LD01

SHEET 7 OF 14

SOIL PREP FOR ALL AREAS

MS-STD-LS-05



IRRIGATION EQUIPMENT NOTES


- . 60 PSI IS ASSUMED, CONTRACTOR TO VERIFY ON SITE AND NOTIFY THE OWNER OR OWNERS REPRESENTATIVE OF ACTUAL PRESSURE ON SITE
- 2. BACKFLOW PREVENTER TO BE WATTS U009 1 INCH, TO BE INSTALLED AS SHOWN ON PLAN AND SHALL BE WITHIN AN ENCLOSURE TO MATCH DETAIL.
- 3. ALL IRRIGATION EQUIPMENT IS TO BE INSTALLED PER MANUFACTURER SPECIFICATIONS.

GENERAL IRRIGATION NOTES

- THE CONTRACTOR IS RESPONSIBLE FOR OBTAINING A COPY OF THE PROJECT SPECIFICATIONS PRIOR TO BIDDING. THE PROJECT SPECIFICATIONS ARE A PART OF THESE PLANS AND SHALL BE CONSULTED BY THE IRRIGATION CONTRACTOR. THE CONTRACTOR IS RESPONSIBLE FOR IMPLEMENTING WORK AS SPECIFIED IN THE PROJECT SPECIFICATIONS AND ON THE PLANS.
- CONTRACTOR SHALL VERIFY ALL DIMENSIONS, ELEVATIONS, EQUIPMENT QUANTITIES, AND UTILITY LOCATIONS PRIOR TO BEGINNING WORK.
- CONTRACTOR SHALL NOTIFY OWNER OF ANY DISCREPANCIES IN PLANS OR SPECIFICATIONS PRIOR TO BEGINNING OR CONTINUING WORK.
- THE CONTRACTOR SHALL MAKE NO SUBSTITUTIONS. DELETIONS, OR ADDITIONS TO THIS PLAN WITHOUT APPROVAL OF THE LANDSCAPE ARCHITECT OR
- ALL CONSTRUCTION SHALL CONFORM TO CITY, COUNTY, STATE, AND FEDERAL REQUIREMENTS. IT SHALL BE THE RESPONSIBILITY OF THE IRRIGATION CONTRACTOR TO ENSURE THAT ALL IRRIGATION EQUIPMENT MEETS GOVERNMENT REGULATIONS. CONTRACTOR SHALL ALSO BE RESPONSIBLE FOR OBTAINING ANY NECESSARY PERMITS OR APPROVALS.
- CONTRACTOR IS TO VERIFY ACTUAL AVAILABLE WATER PRESSURE BEFORE BEGINNING INSTALLATION. CONTRACTOR SHALL NOTIFY LANDSCAPE ARCHITECT OR LICENSED IRRIGATOR IF AVAILABLE WATER PRESSURE EXCEEDS 5 PSI HIGHER OR LOWER THAN THE DESIGN WATER PRESSURE.
- IRRIGATION SYSTEMS CONNECTED TO POTABLE WATER SUPPLY, SHALL HAVE A BACKFLOW PREVENTER INSTALLED PER LOCAL REQUIREMENTS.
- ANY EXISTING TREES TO REMAIN ARE TO BE PROTECTED FROM DAMAGE. DO NOT TRENCH OR EXCAVATE WITHIN THE CRITICAL ROOT ZONE OF ANY TREE. SUPPLY LINE AND METER TO BE PROVIDED BY GENERAL CONTRACTOR. IRRIGATION CONTRACTOR'S POINT OF CONNECTION TO BEGIN AFTER THE IRRIGATION WATER METER. BACKFLOW PREVENTER TO BE PROVIDED BY IRRIGATION CONTRACTOR, UNLESS SPECIFIED TO BE LOCATED INSIDE AT WHICH POINT WILL BE
- IRRIGATION CONTRACTOR SHALL REVIEW WINTERIZATION PROCEDURES FOR IRRIGATION SYSTEM WITH OWNERS REPRESENTATIVE.
- IRRIGATION CONTRACTOR IS RESPONSIBLE FOR INSTALLING MANUAL DRAIN VALVES AT LOWEST POSSIBLE ELEVATION ON IRRIGATION MAIN SO AS TO PROVIDE POSITIVE DRAINAGE OF IRRIGATION MAIN DURING WINTER MONTHS OR PROVIDE BLOWOUT ASSEMBLY.
- ALL LATERAL LINES SHALL BE EQUIPPED WITH AUTOMATIC DRAIN VALVES AT LOW POINTS


PROVIDED BY THE GENERAL CONTRACTOR OR PLUMBER.

- 3. IRRIGATION CONTRACTOR SHALL COORDINATE CONTROLLER LOCATION WITH GENERAL CONTRACTOR. GENERAL CONTRACTOR SHALL PROVIDE (2) 1" ELECTRICAL CONDUITS FOR IRRIGATION CONTRACTOR'S POWER/DATA CONNECTION TO CONTROLLER. SEE ARCHITECTURAL ELECTRICAL PLAN FOR ELECTRICAL CONNECTION TO THE IRRIGATION CONTROLLER. IRRIGATION CONTRACTOR SHALL COORDINATE CONSTRUCTION OF IRRIGATION SYSTEM WITH GENERAL CONTRACTOR AND LANDSCAPE CONTRACTOR PRIOR TO COMMENCEMENT OF CONSTRUCTION.
- THE CONTRACTOR IS SPECIFICALLY CAUTIONED THAT THE LOCATION AND/OR ELEVATION OF EXISTING UTILITIES AS SHOWN ON THESE PLANS IS BASED ON RECORDS OF THE VARIOUS UTILITY COMPANIES, AND WHERE POSSIBLE, MEASUREMENTS TAKEN IN THE FIELD. THE INFORMATION IS NOT TO BE RELIED ON AS BEING EXACT OR COMPLETE. THE CONTRACTOR MUST CALL THE APPROPRIATE UTILITY COMPANIES AT LEAST 72 HOURS BEFORE ANY EXCAVATION TO REQUEST EXACT FIELD LOCATION OF UTILITIES. IT SHALL BE THE RESPONSIBILITY OF THE CONTRACTOR TO RELOCATE ALL EXISTING UTILITIES WHICH CONFLICT WITH THE PROPOSED IMPROVEMENTS SHOWN ON THE PLANS.
- 5. $\,$ ALL BELOW GRADE LOW VOLTAGE WIRING CONNECTIONS SHALL BE INSTALLED PER WIRE CONNECTION DETAIL.
- $16.\;\;$ DO NOT INSTALL IRRIGATION AT PYLON / MONUMENT SIGN LOCATION UNTIL SIGN HAS BEEN INSTALLED.
- LOCATION FOR IRRIGATION SYSTEM AS SHOWN IS FOR DRAWING PURPOSES ONLY. UNSLEEVED PIPES MAY BE SHOWN IN PAVEMENT AREAS FOR CLARITY ONLY. INSTALL THESE PIPES IN ADJACENT LANDSCAPE AREAS WHERE NECESSARY. CONTRACTOR SHALL VERIFY THE EXACT LOCATION IN FIELD PRIOR TO THE COMMENCEMENT OF CONSTRUCTION OF PROPOSED IRRIGATION SYSTEM. ALL PROPOSED IRRIGATION LINES AND EQUIPMENT SHALL BE INSTALLED WITHIN THE BOUNDARIES OF THE PROJECT SITE. CONTRACTOR SHALL NOTIFY LANDSCAPE ARCHITECT OR LICENSED IRRIGATOR IF THE DESIGN AS SHOWN IS NOT ACHIEVABLE.
- MINIMUM COVER FROM TOP OF PIPING TO FINISHED GRADE SHALL BE AS PER DETAIL.
-). IRRIGATION CONTRACTOR SHALL COORDINATE IRRIGATION INSTALLATION WITH PLANTING PLAN AND SITE CONDITIONS TO PROVIDE COMPLETE COVERAGE WITH MINIMUM OVERSPRAY. THE IRRIGATION CONTRACTOR SHALL MAKE MINOR ADJUSTMENTS TO ENSURE PROPER COVERAGE AT NO ADDITIONAL COST TO
- 0. VALVE BOXES SHALL BE INSTALLED FLUSH WITH GRADE, PER DETAIL
- . ALL MAIN LINE PIPING, NON-PRESSURE PIPING AND CONTROL WIRE SLEEVING SHALL BE INSTALLED IN SEPARATE SLEEVES. ALL LATERAL LINE PIPING UNDER PAVING SHALL BE PVC SCHEDULE 40 AND SHALL BE INSTALLED PRIOR TO ANY HARDSCAPE MATERIAL. IRRIGATION CONTRACTOR TO PROVIDE SLEEVES BETWEEN 12" AND 15" BELOW GRADE AT ALL DRIVE ENTRANCES AND SIDEWALKS. MAINLINE SLEEVE SIZE SHALL BE A MINIMUM OF TWICE (2X) THE DIAMETER OF THE PIPE TO BE SLEEVED. CONTROL WIRE SLEEVES SHALL BE OF SUFFICIENT SIZE FOR THE REQUIRED NUMBER OF WIRES.
- . IT IS THE RESPONSIBILITY OF THE IRRIGATION CONTRACTOR TO FAMILIARIZE HIMSELF WITH ALL GRADE DIFFERENCES, LOCATION OF FENCES, RETAINING WALLS, AND UTILITIES. THE IRRIGATION CONTRACTOR SHALL REPAIR OR REPLACE ALL ITEMS DAMAGED BY HIS WORK. THEY SHALL COORDINATE HIS WORK WITH OTHER CONTRACTORS FOR THE LOCATION AND INSTALLATION OF PIPE SLEEVES AND LATERALS THROUGH WALLS, UNDER ROADWAYS AND PAVING AND TIMING, ETC. REFER TO CIVIL ENGINEERING PLANS FOR GRADING, METHODS OF DRAINAGE, IRRIGATION METERS, AND BACKFLOW PREVENTION DEVICE
- . ALL IRRIGATION EQUIPMENT NOT OTHERWISE DETAILED OR SPECIFIED, SHALL BE INSTALLED AS PER MANUFACTURER'S RECOMMENDATIONS, DETAILS AND SPECIFICATIONS. ACCEPTABLE MANUFACTURERS INCLUDE RAINBIRD, HUNTER, TORO, OR NETAFIM
- 4. ANY DRIP SYSTEM PIPING IN PLANTING BEDS IS DIAGRAMMATIC. CONTRACTOR CAN ROUTE PIPING IN A FREEFORM MANNER (AVOIDING OBJECTS SUCH AS LIGHT POLES, TRANSFORMERS PADS, EQUIPMENT VAULTS, SUBSURFACE ROCK TOO LARGE TO REMOVE, ETC...) AS LONG AS ALL PLANT MATERIAL RECEIVES THE PROPER NUMBER OF EMITTERS PER SCHEDULE AND THE VINYL DISTRIBUTION TUBING DOES NOT EXCEED THE MAXIMUM DESIGN LENGTHS PER MANUFACTURER'S RECOMMENDATIONS
- 5. UNLESS OTHERWISE REQUIRED, BACKFLOW PREVENTION DEVICES LESS THAN 2" SHALL BE PLACED IN A WIRE MESH BASKET ENCLOSURE AND PAINTED TO MATCH THE PRIMARY BUILDING COLORS. SEE CIVIL PLANS FOR LOCATION.
- 6. ALL JOINTS AND BENDS 2" OR LARGER SHALL HAVE CONCRETE THRUST BLOCKING. THRUST BLOCKING SHALL BE A MINIMUM OF 1 CUBIC FOOT OF CONCRETE. PIPE SHALL NOT BE ENCASED IN CONCRETE. SEE DETAIL 31C FOR THRUST BLOCKING.
- CONTRACTOR WILL PROVIDE OWNER WITH A COMPLETE AND REPRODUCIBLE DRAWING OR IRRIGATION SYSTEM LAYOUT AS IT WAS INSTALLED. DRAWING SHOULD INCLUDE, BUT NOT BE LIMITED TO, LOCATIONS OF ZONES VALVES, MAIN, LATERAL AND DISTRIBUTION LINES, SLEEVES, WATER METER, BACKFLOW PREVENTION DEVICE, SENSORS AND CONTROLLER.
- 8. ALL LATERAL LINE SIZING SHALL REFER TO PIPE SCHEDULE ON THIS PLAN.
- ALL EXISTING AND PROPOSED SIDEWALKS, BARRIER-FREE RAMPS, HANDICAP PARKING, DRIVEWAY CROSSWALKS, DRIVEWAYS AND ACCESSIBLE ROUTES SHALL COMPLY WITH A.D.A., T.A.S., AND CITY OF GREENWOOD VILLAGE REQUIREMENTS. EXISTING INFRASTRUCTURE NOT COMPLYING SHALL BE REMOVED AND REPLACED TO MEET STANDARDS
- THE CITY HAS ADOPTED PERMANENT WATER-WISE REGULATION AT THE START OF 2020 WHICH WILL AFFECT THE OVERALL OPERATION OF THE IRRIGATION
- FROM MAY 1 TO OCTOBER 15, SPRINKLERS CAN BE OPERATED BEFORE 10 A.M. AND AFTER 6 P.M.
- WATERING IS LIMITED TO THREE DAYS A WEEK (DRIP IRRIGATION ALLOWED AT ANYTIME).
- ESTABLISHMENT PERMITS ARE REQUIRED FROM COLORADO SPRINGS UTILITIES FOR CUSTOMERS WHO NEED TO TEMPORARILY WATER MORE THAN THREE DAYS A WEEK TO ESTABLISH NEW LANDSCAPES.
- ALLOCATION PLANS ARE AVAILABLE FOR CUSTOMER WHO NEED MORE WATERING SCHEDULE FLEXIBILITY FROM COLORADO SPRINGS UTILITIES.

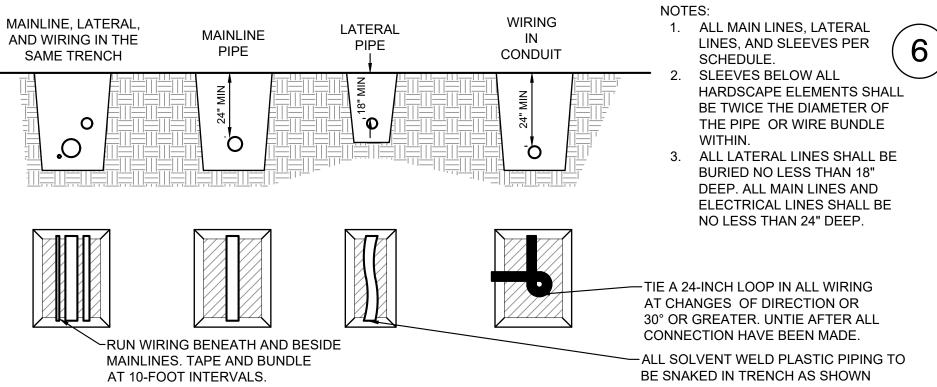

REDUCED PRESSURE **BACKFLOW DEVICE** BACKFLOW COVER, CAGE GALVANIZED NIPPLES AND ELL AS REQUIRED - GALVANIZED UNIONS AT EACH SIDE - GALVANIZED RISERS GALVANIZED NIPPLES AND ELL AS REQUIRED 3" MIN PVC COUPLER OR REDUCER ON ALL AS REQUIRED, TYP. SIDES - IRRIGATION MAIN LINE CONCRETE THRUST BLOCKS, 90 LBS OF CONCRETE EACH - WATER SERVICE LINE REDUCED PRESSURE BACKFLOW WITH ENCLOSURE

- PEDESTRIAN MOUNT

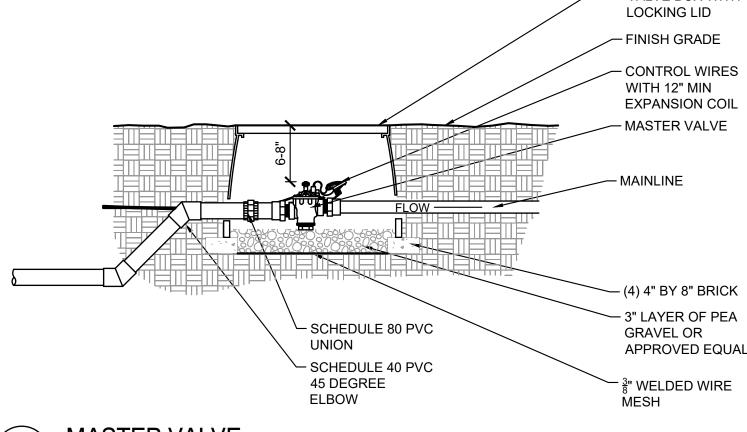

- RECTANGULAR VALVE BOX WITH MASTER VALVE SHALL BE MAKE

- AND MODEL NUMBER AS PRESCRIBED PER SCHEDULE 2. INSTALL MASTER VALVE PER MANUFACTURER'S
- SPECIFICATIONS AND RECOMMENDATIONS. MASTER VALVE WIRE SHALL BE 14
- AWG OR LARGER. 4. ALL WIRE RUNS SHALL BE CONTINUOUS WITHOUT ANY SPLICES. WIRE CONNECTIONS SHALL BE MADE USING DBR-Y/6

CONNECTORS OR APPROVED

- **EQUAL** 5. SEE MASTER VALVE/ FLOW SENSOR DETAIL FOR LINEAR DIMENSIONS.
- VALVE BOXES SHALL BE LOCATED IN PLANTING AREAS.

PLANNER/ LANDSCAPE ARCHITECT/ CIVIL ENGINEER

2435 RESEARCH PARKWAY, SUITE 300

COLORADO SPRINGS, CO 80920

PHONE: (719) 575-0100 FAX: (719) 575-0208

CONSULTANTS:

OWNER/DEVELOPER: G LIGHT EQUITY

5025 BOARDWALK DR. STE 250' COLORADO SPRINGS, CO 80919 (719) 310-6228

APPROVAL:

VICINITY MAP: HIGH TECH WY

CENTENNIAL BLVD TOWNHOMES CONDITIONAL USE DEVELOPMENT PLAN **EL PASO COUNTY**

JUNE 6, 2022

REVISION HISTORY DATE DESCRIPTION 8/15/2022 PER CITY COMMENTS 10/12/2022 PER CITY COMMENTS 4/27/2023 PER CITY COMMENTS AND CLIENT REVIEW 8/1/23 PER CITY COMMENTS

DRAWING INFORMATION: PROJECT NO: 22.1258.002

BTP DRAWN BY: CHECKED BY: AJP

APPROVED BY: AJP SHEET TITLE

IRRIGATION NOTES AND DETAILS

IR01

SHEET 9 OF 14

ENCLOSURE, SEE LEGEND FOR MODEL TUBING STAKE - CONTROLLER, PER SCHEDULE, SECURELY TOP OF ROCK/WOOD BOLT TO ENCLOSURE, MULCH INSTALL BACK UP BATTERIES AS REQUIRED. $-\frac{1}{4}$ " DISTRIBUTION GROUND PER MFG. TUBING, 48" MAX **SPECIFICATIONS** - INSERT FITTING - GFI RECEPTACLE AND BARB CONNECTION CONTROLLER SWITCH, TO FILL WITH SEALANT OR INSERT BARBED BE PROVIDED BY CONTRACTOR - WIRES FROM FIELD - 1" DIA. SC. 40 CONDUIT FOR 120 VOLT ELECTRICAL SOURCE, CRIMP SLEEVE USE **INSTALLED PER LOCAL** RECOMMENDED TOOL - 2" DIA. PVC CONDUIT FOR RCV WIRES - DRIP TUBING - COPPER GROUND, PER LOCAL CODE - RAIN BIRD · CONCRETE BASE, 6" MIN XERI-BUG EMITTER THICKNESS, EXTEND 6" 2 PER PLANT BEYOND OUTSIDE **GENERAL NOTES:** - TIE DOWN STAKE AT **DIMENSIONS OF** 1. PEDESTAL MOUNT CONTROLLER TO BE INSERT

20" BY 14" PLASTIC VALVE -- FILTER - PRESSURE REGULATOR CONTROLLER WIRE WITH - PVC UNION W/ SHORT 30" LINEAR LENGTH OF NIPPLES COIL, WITH PLASTIC I.D. TAG AND WATERPROOF - OUTLET PIPE SAME CONNECTORS SIZE AS VALVE, 24" MIN. LENGTH TO SET BOX FLUSH AT FIRST FITTING SOD/SEED, SET BOX 2" ABOVE FINISH GRADE IN - 45 DEGREE DOWN AS ROCK/WOOD MULCH REQUIRED TO LATERAL RCV -PIPE DEPTH PVC TRUE UNION BALL -- (4) 4" BY 8" BRICK VALVE 3" LAYER OF PEA SCHEDULE 80 PVC RISER **GRAVEL OR** APPROVED EQUAL NIPPLE AT MAINLINE

ENCLOSURE. SLOPE TO

MS-STD-IRR-11

LOCATED PER PLAN

PEDESTAL MOUNT CONTROLLER

AUTOMATIC CONTROL VALVE

LOCATE VALVE BOX WITHIN 24" OF PAVEMENT **EDGE IN PLANTING AREA WHERE EASILY** ACCESSIBLE WHENEVER POSSIBLE COMMON WIRE AND CONTROLLER WIRE SHALL

MS-STD-IRR-10

- BE DIRECT BURIAL 14 AWG OR LARGER. COLOR: COMMON (WHITE), CONTROLLER WIRE FOR TURF (BLUE), AND CONTROLLER WIRE FOR SHRUBS (RED). (SEE SPECIFICATIONS FOR 2-WIRE CONTROLLERS). ALL WIRE RUNS SHALL BE CONTINUOUS WITHOUT ANY SPLICES UNLESS APPROVED BY THE OWNER'S REPRESENTATIVE. SEE SPLICE
- BOX DETAIL. WIRE CONNECTIONS SHALL BE MADE USING DBR/Y-6 CONNECTORS OR APPROVED EQUAL. MAINLINES 4" OR LARGER SHALL USE SADDLES AT THE CONNECTIONS POINTS TO THE IRRIGATION VALVE. (SEE SPECIFICATIONS FOR
- IRRIGATIONS SADDLES). ALL SCH. 80 PVC TO SCH. 40 PVC THREADED CONNECTIONS SHALL BE MADE USING TEFLON TAPE.

NOTES:

1. PLACE TIE DOWN STAKES EVERY 3' O.C.

LEG OF THE CHANGE OF DIRECTION.

- TIE DOWN STAKE

MS-STD-IRR-05

2. AT FITTINGS WHERE THERE IS A CHANGE OF DIRECTION

SUCH AS TEES OR ELBOWS, USE TIE-DOWN STAKES ON EACH

MS-STD-IRR-09

- POLYETHYLENE TUBING

RAIN BIRD XFD-CROSS

- ON-SURFACE DRIPLINE:

RAIN BIRD XFF-TEE

RAIN BIRD XFF-TEE

RAIN BIRD XFF-TEE

- POLYETHYLENE TUBING

- ROOT BALL

POLYETHYLENE TUBING

- BARB TEE INSERT FITTING:

POTABLE: XFCV DRIPLINE

- BARB TEE INSERT FITTING:

- BARB TEE INSERT FITTING:

- BARB CROSS INSERT FITTING:

RAIN BIRD XF SERIES DRIPLINE


PVC/POLYETHYLENE TUBING

PVC SCH 40 TEE OR EL

IRRIGATION PIPE & WIRE TRENCHING


8

MS-STD-IRR-06

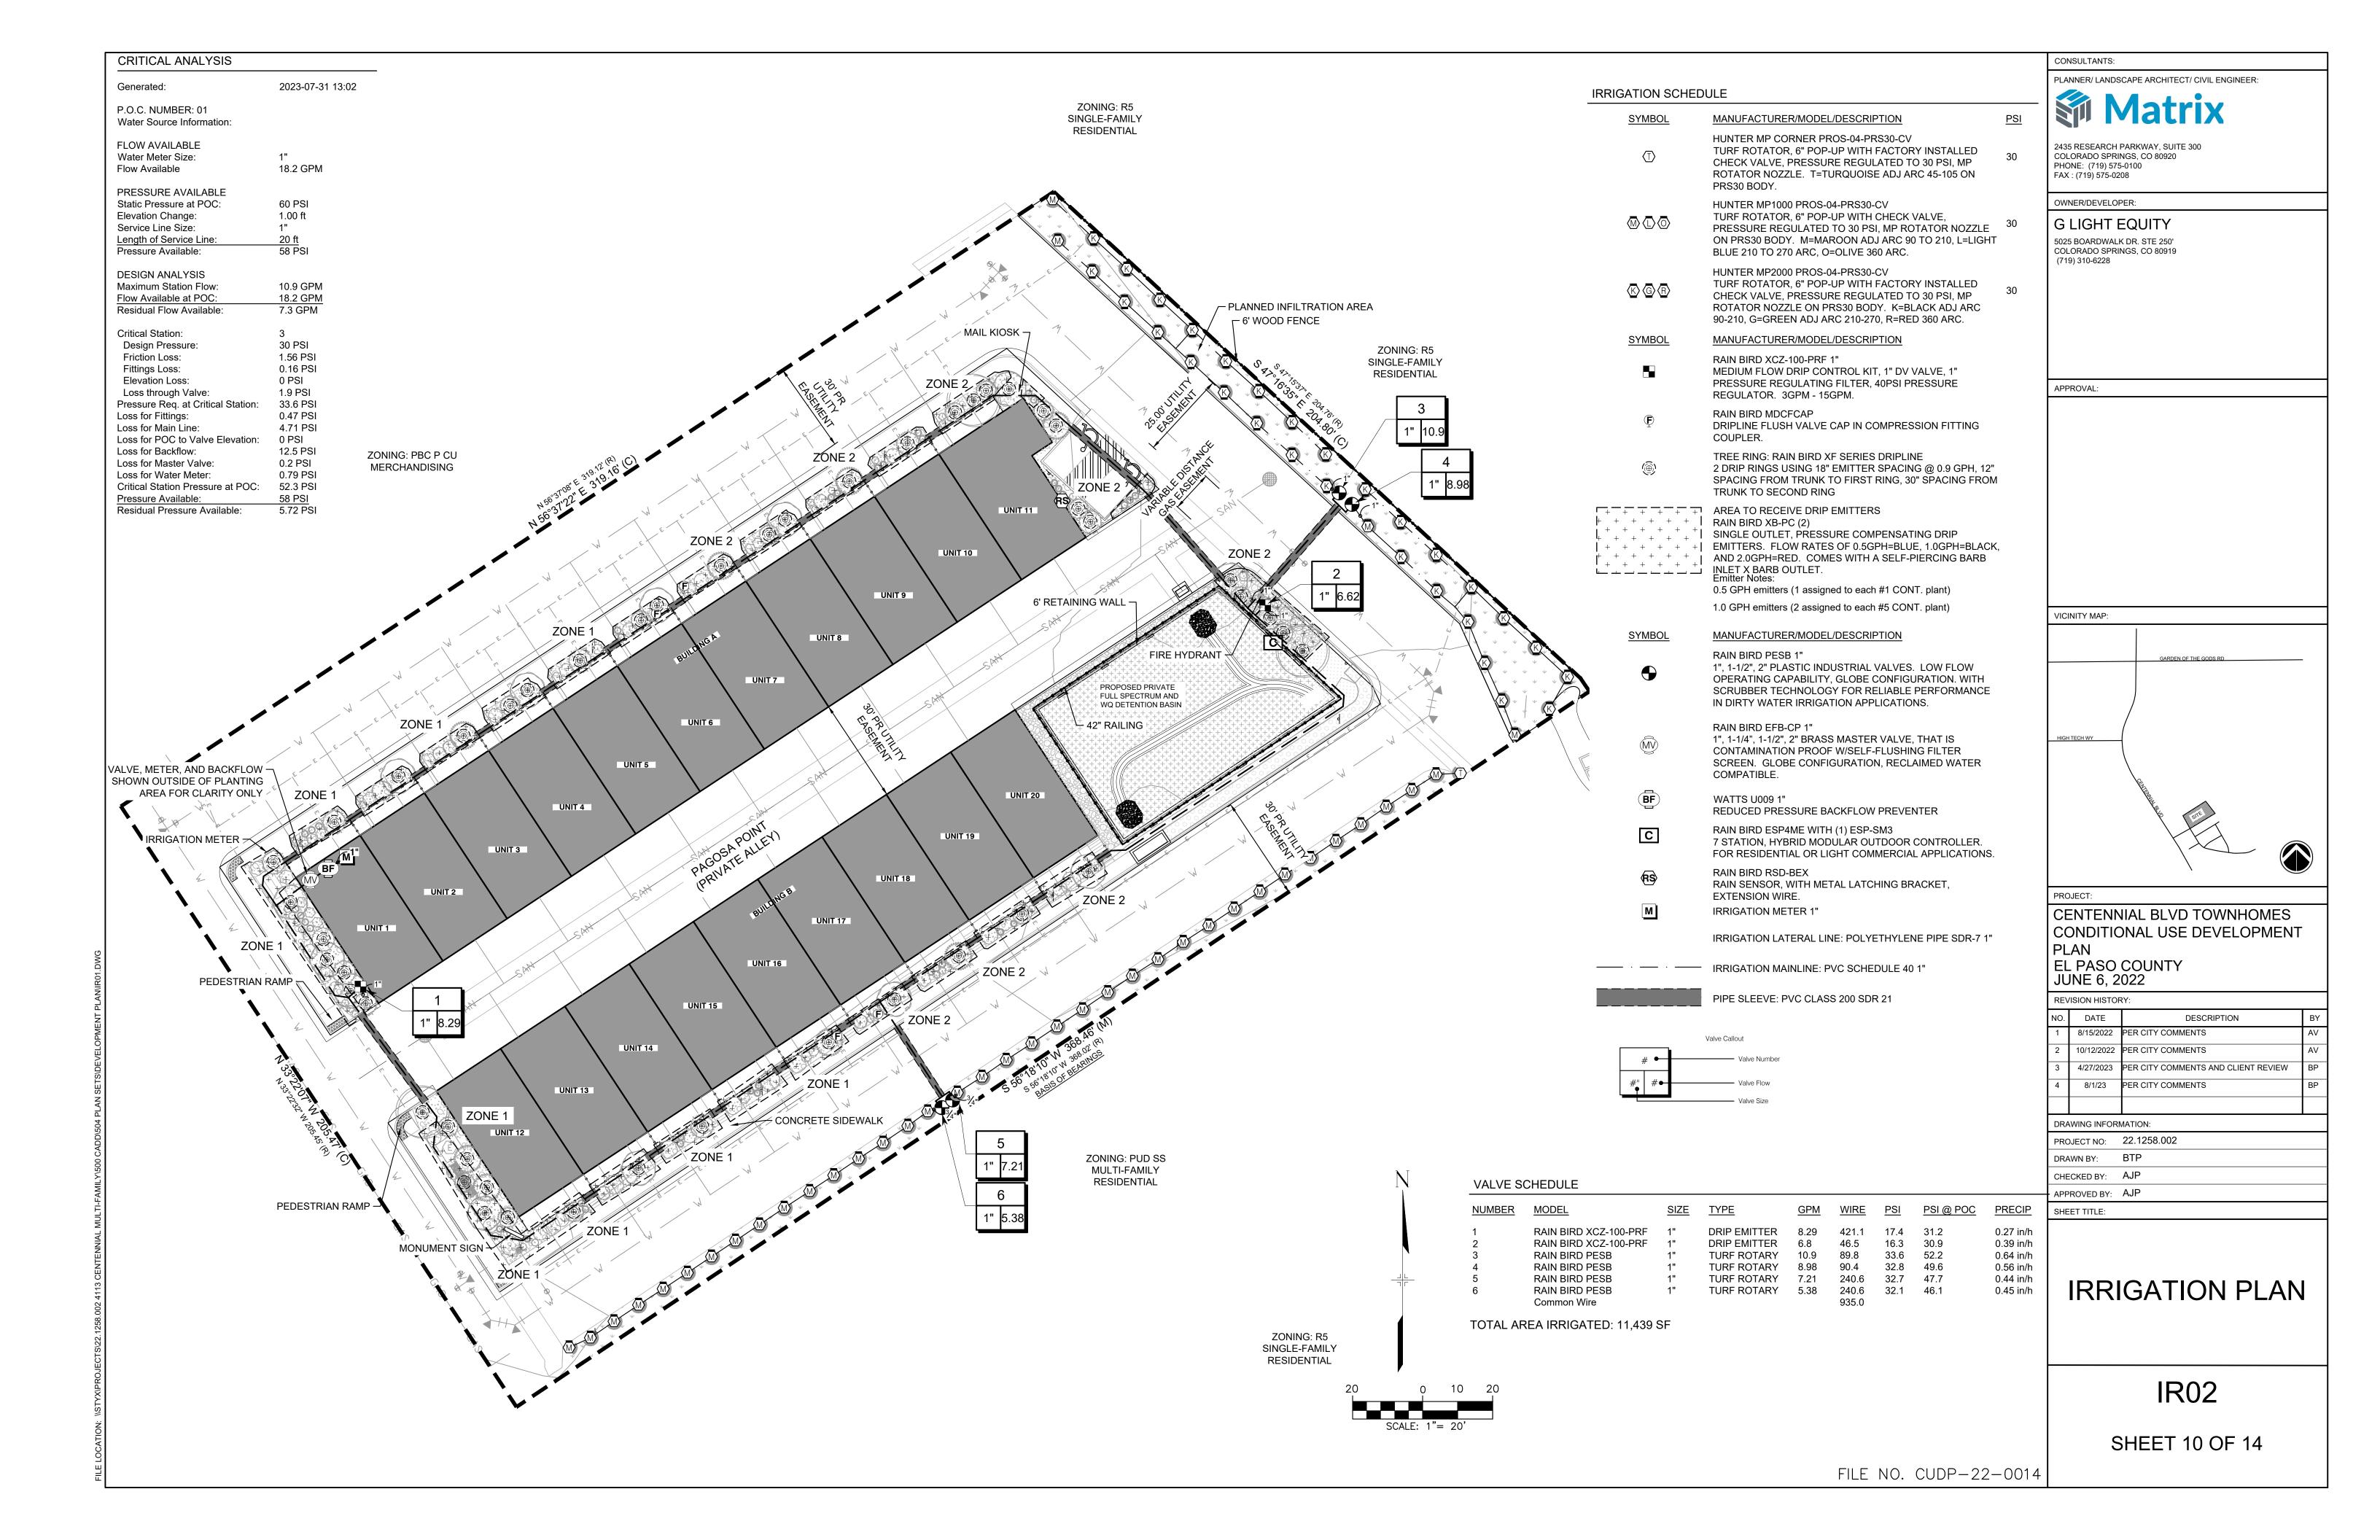

Schedul	е										
Symbol	Label	Image	Quantity	Manufacturer	Catalog Number	Description	Number Lamps	Lumens Per Lamp	Light Loss Factor	Wattage	Plot
	A		9	Lithonia Lighting	WPX1 LED P1 30K Mvolt	WPX1 LED wallpack 1500lm 3000K color temperature 120-277 Volts	1	1537	1	11.49	Max: 687cd "
	В		20	Lithonia Lighting	OLCS 8 DDB	OUTDOOR CAST SCONCE W/DR3 FROSTED LENS; BROWN	1	470	1	8.93	Max: 166cd
	С		21	Lithonia Lighting	WDGE1 LED P1 27K 90CRI VF	WDGE1 LED WITH P1 - PERFORMANCE PACKAGE, 2700K, 90CRI, VISUAL COMFORT FORWARD OPTIC	1	967	1	10.0002	Max: 673cd

Statistics						
Description	Symbol	Avg	Max	Min	Max/Min	Avg/M
Calc Zone #2	+	0.4 fc	4.6 fc	0.0 fc	N/A	N/A

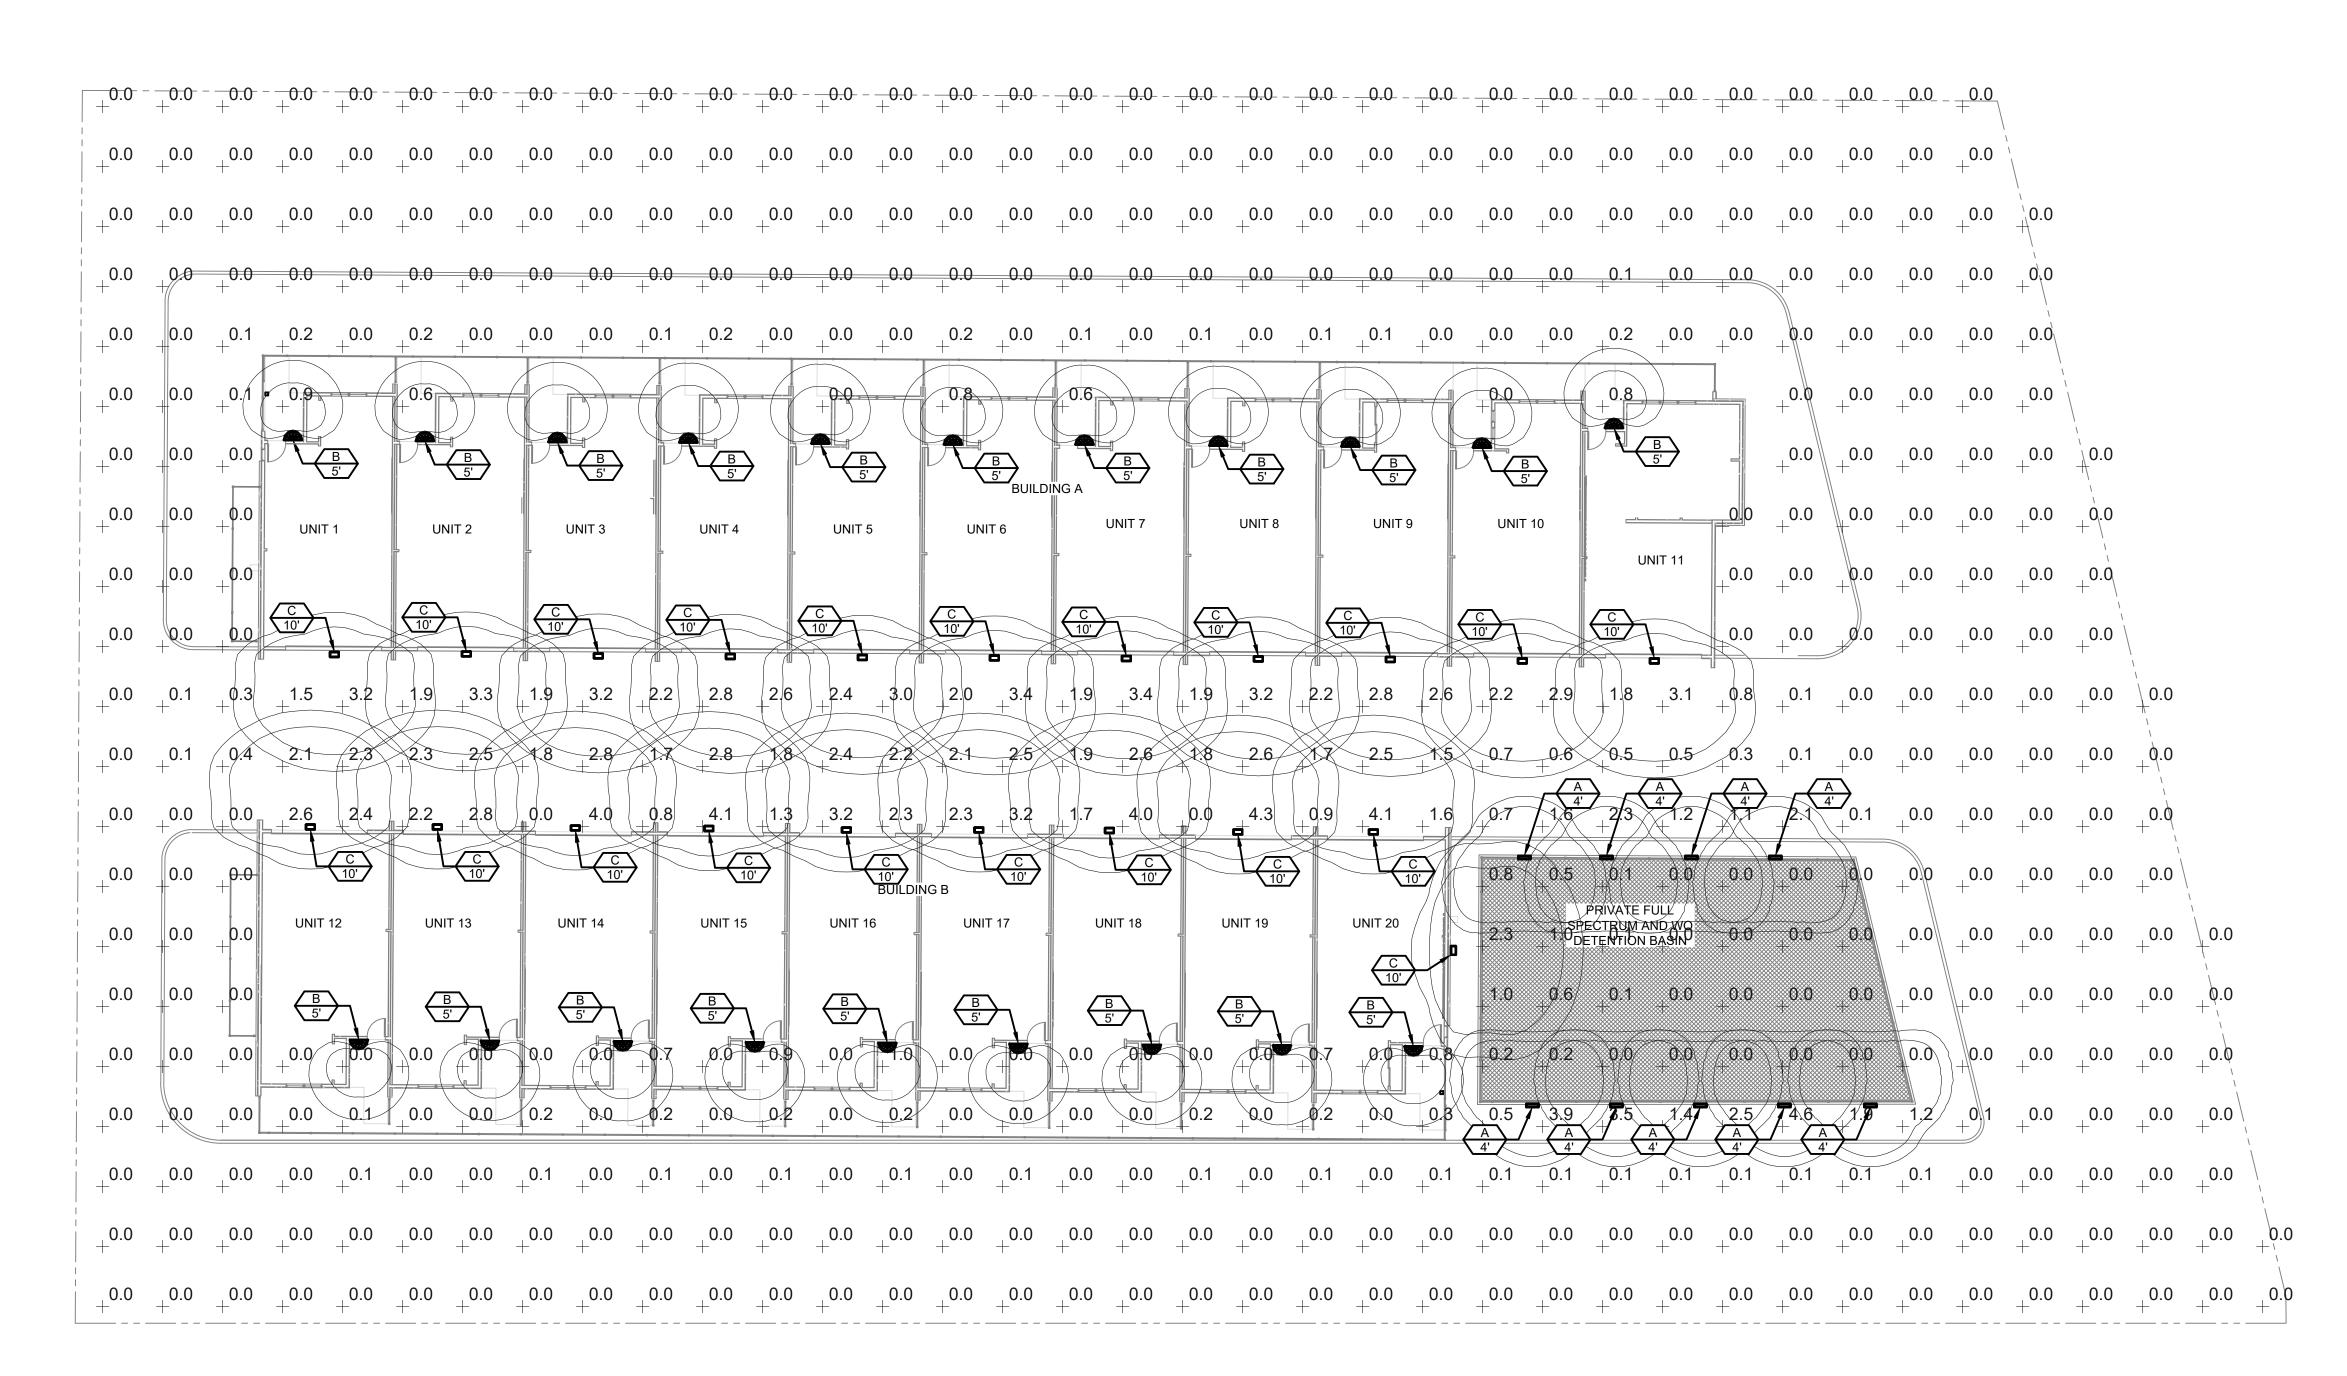

GENERAL NOTES:

PER CITY CODE SECTION 7.4.102.D, CALCULATIONS ARE PERFORMED AND ALL LIGHTING FIXTURES SHALL BE FULL CUT-OFF OR HAVE SHIELDING TO REDUCE OFF-SITE LIGHTING IMPACTS ONTO ADJACENT PROPERTIES AND ROADWAYS. ALL EXTERIOR LIGHTING SHALL BE ARRANGED TO MITIGATE LIGHT DIRECTED AWAY FROM ADJACENT PROPERTIES AND ANY PUBLIC RIGHT-OF-WAY. AN AMENDMENT TO THIS PLAN MAY BE REQUIRED IF THE LIGHTING TYPE OR FIXTURE IS CHANGED.



VAY FROM ADJACENT PROPERTIES AND ANY PUBLIC
AMENDMENT TO THIS PLAN MAY BE REQUIRED IF THE
FIXTURE IS CHANGED.

PHO

CUDD 22 0014

DATE OF CALCULATION: 8/15/2022

FILE NO. CUDP-22-0014

REVISIONS
DATE FOR



51EC INC.

31 NORTH TEJON ST, SUITE 304
COLORADO SPRINGS, CO 80903

FIFTYONEEC.COM

Architecture s Street, Suite 113

201 East Las Animas Street, Suite Colorado Springs, CO 80903 719.623.5641 (Phone)

LING DEVELOPMENT ES ON CENTENNIAL

PHOTOMETRICS
4113 CENTENNIAL BLVD.
COLORADO SPRINGS, CO

PHOTOMETRICS PLAN


DATE: 08/16/2022

DRAWN BY: NSC/

CHECKED BY: AIS

PROJECT NO: 5136-22-04

SHEET NO:

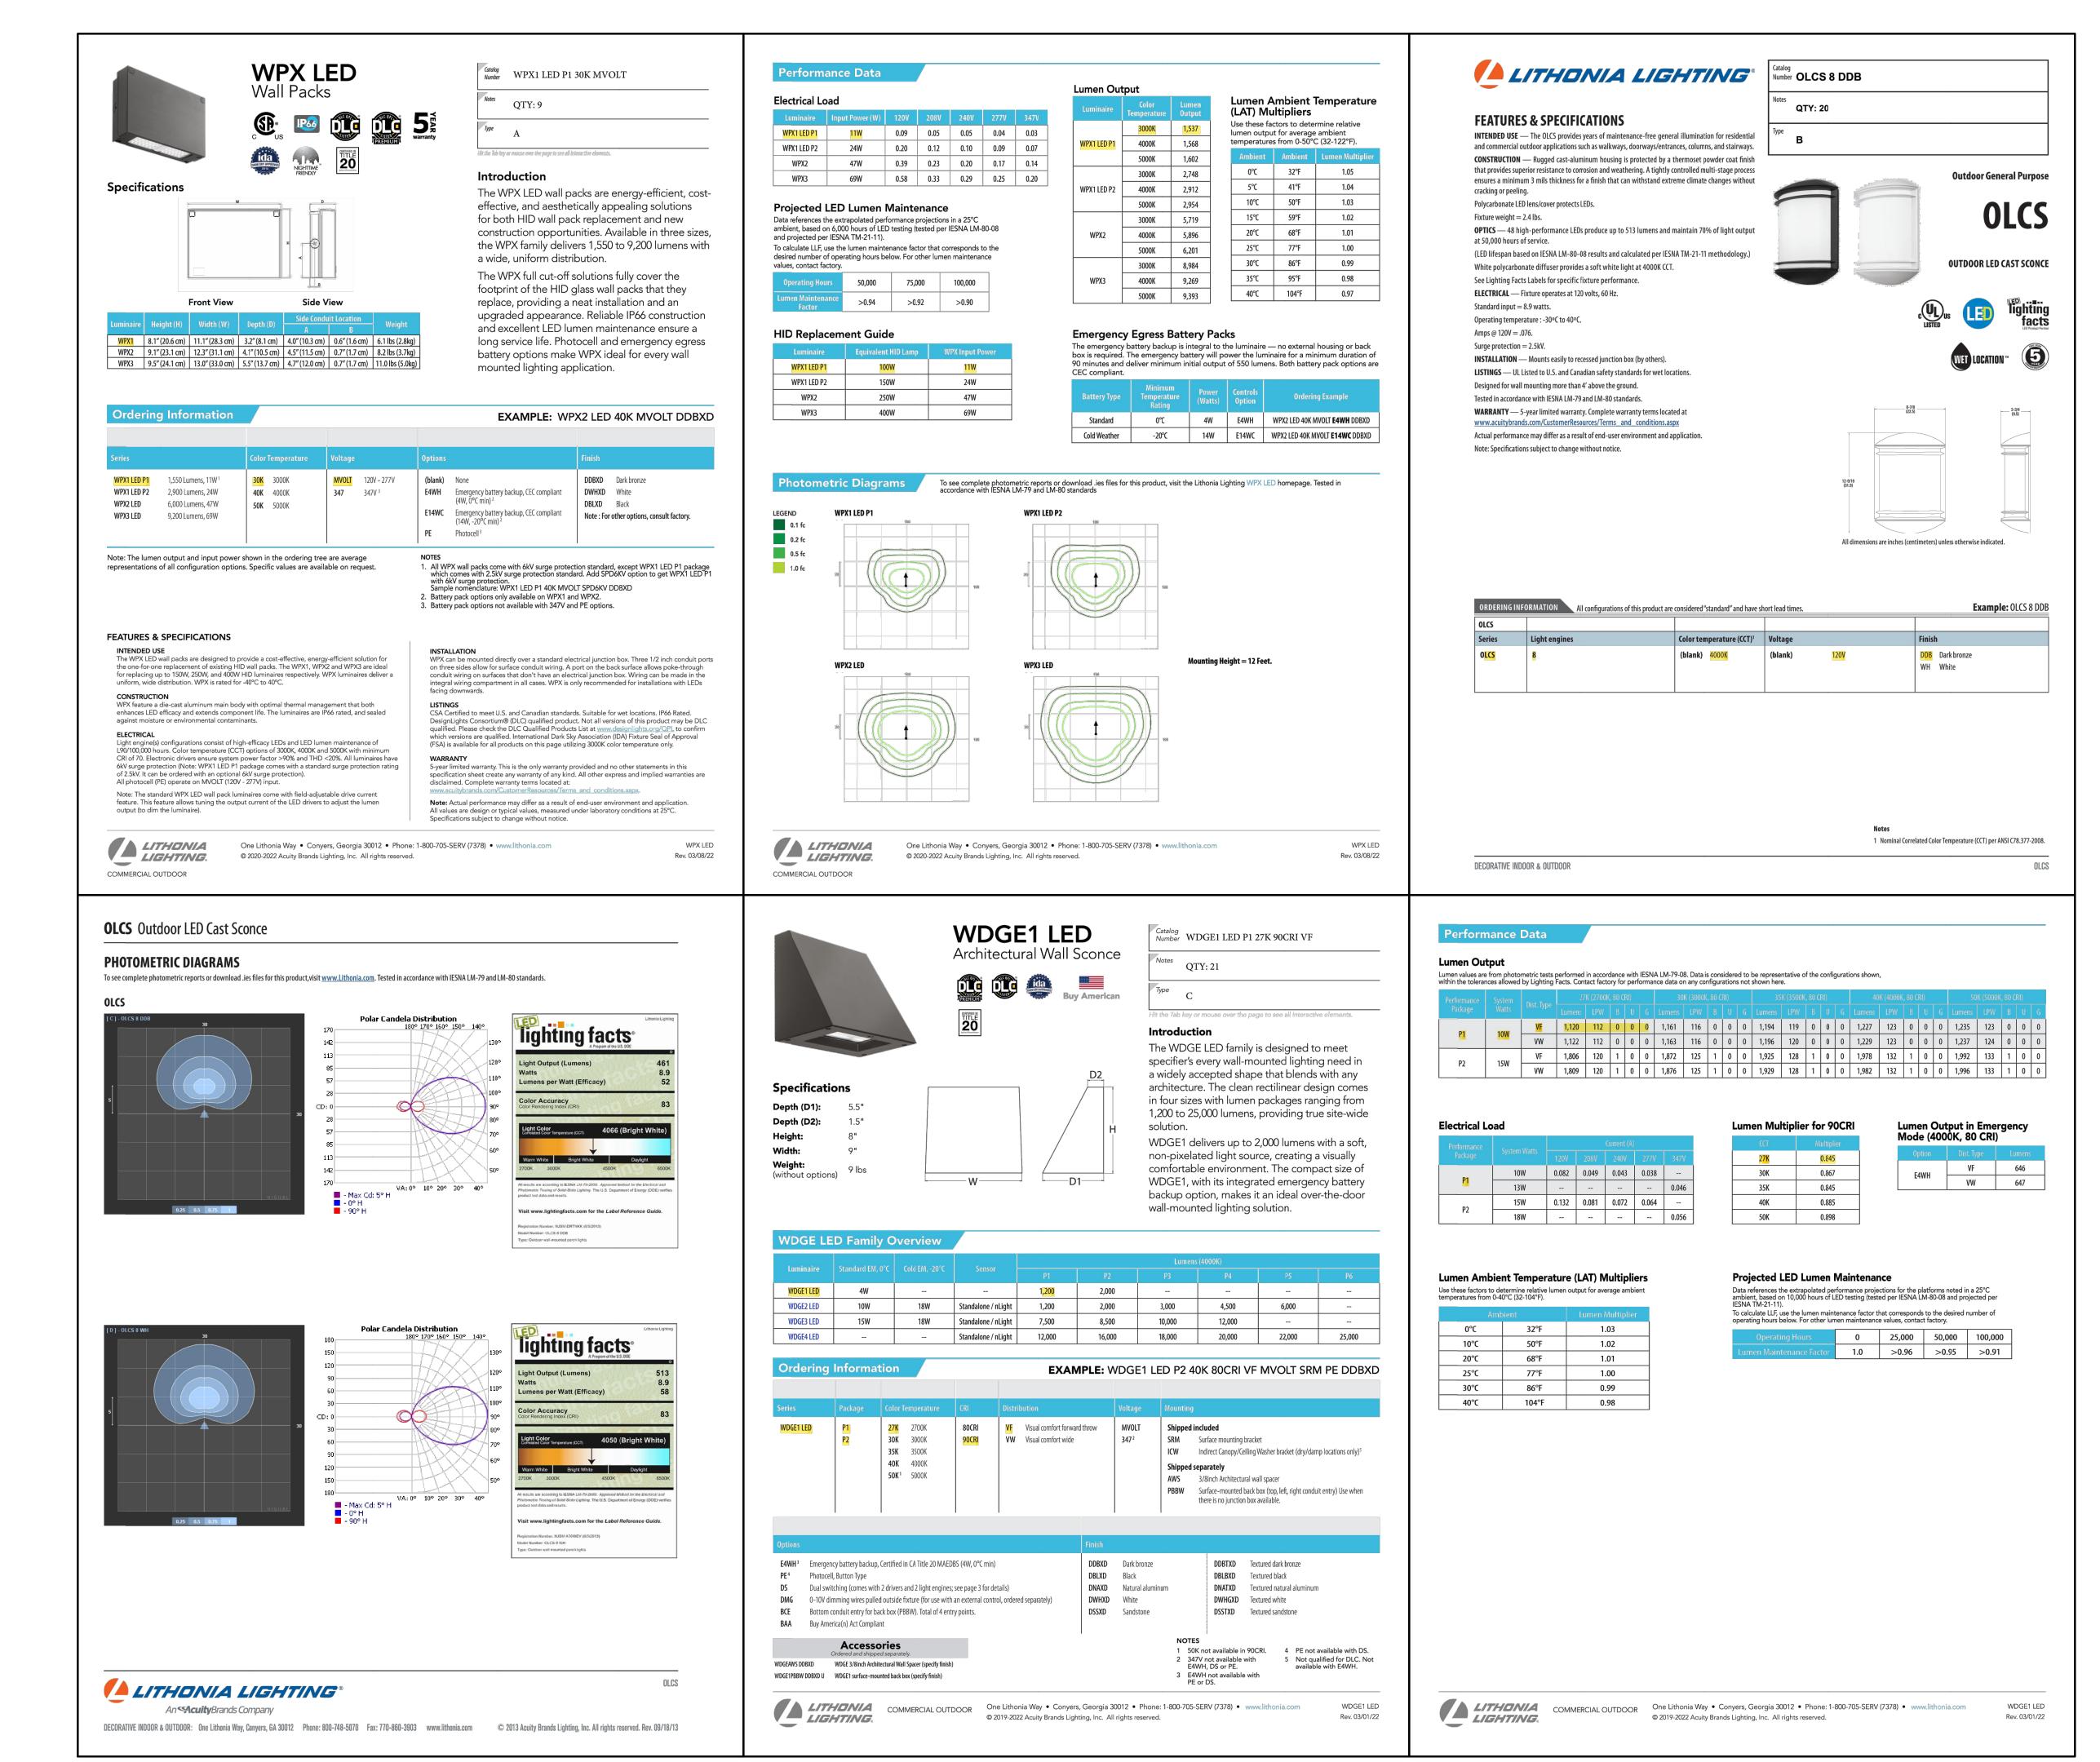

DATE OF CALCULATION: 8/15/2022 FILE NO. CUDP-22-0014

12 OF 14

LIGHT FIXTURE SPECIFICATION

DATE: 08/16/2022

DRAWN BY: NSC/JLV

PROJECT NO: 5136-22-04

SHEET NO:

CHECKED BY: AIS

REVISIONS

51EC INC.

31 NORTH TEJON ST, SUITE 304


COLORADO SPRINGS, CO 80903

FIFTYONEEC.COM

T 719.368.7394

DATE FOR



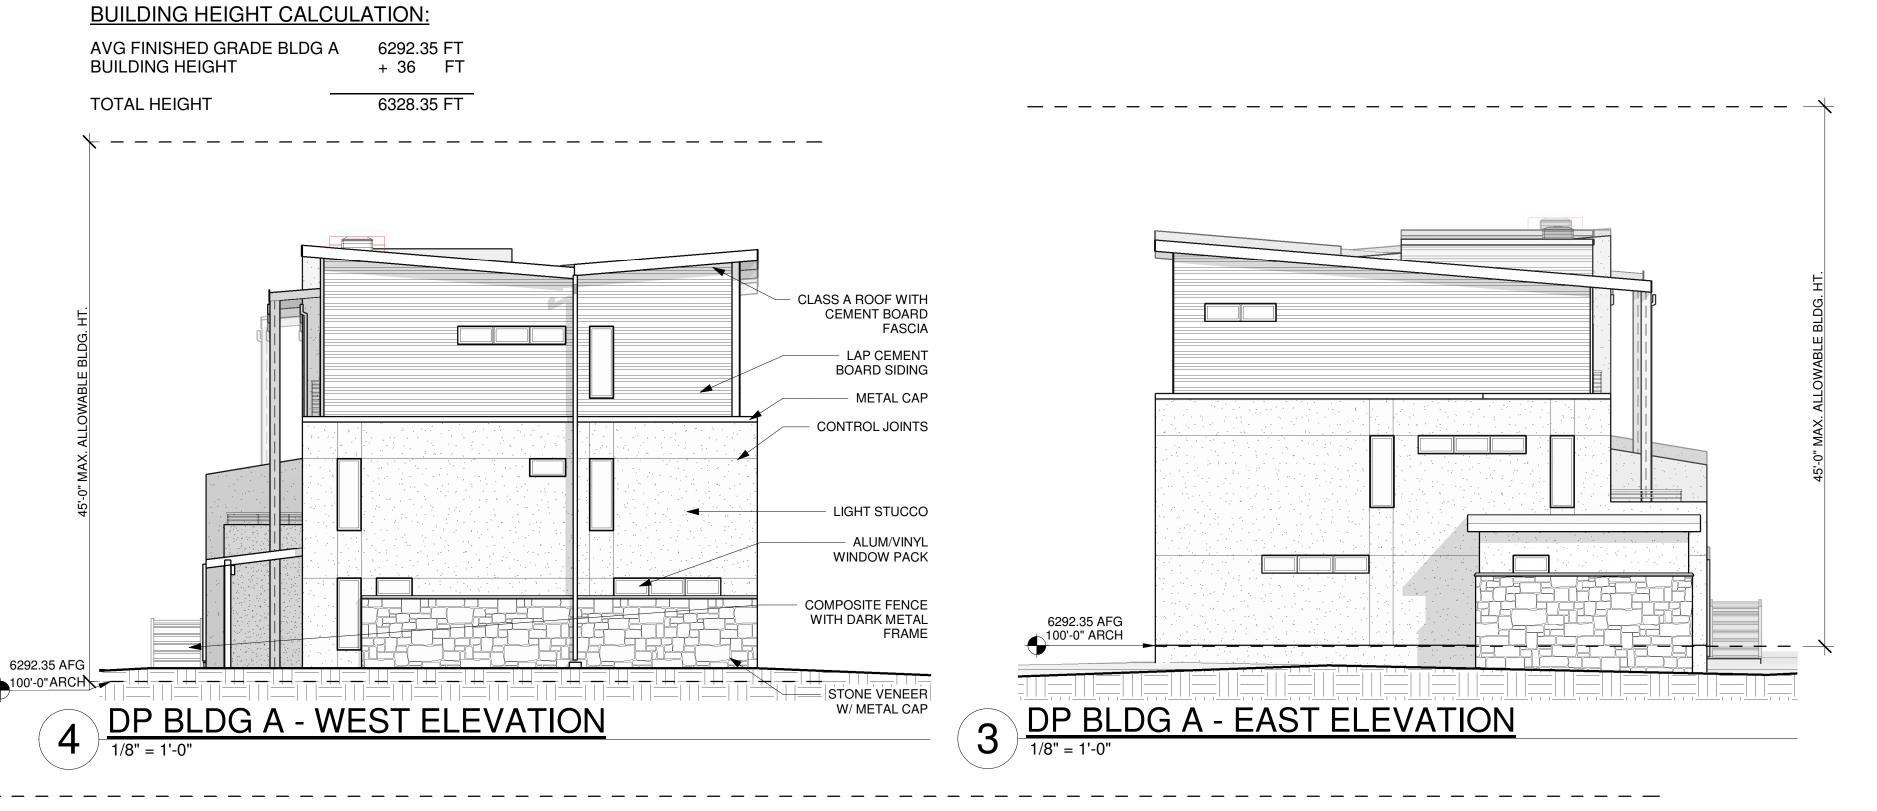





1 DP BLDG A - REAR ELEVATION

1/8" = 1'-0"

SCHEMATIC EXTERIOR ELEVATIONS

TOWNHOMES ON CENTENNIAL

07/20/23

4113 CENTENNIAL BLVD.
COLORADO SPRINGS CO 80919

TDG Architecture

201 E. Las Animas Street, Ste. II3

COS 80903 (719)623-5641

