

SITE PLAN LEGEND

NEW BUILDING EXISTING BUILDING (NOT A PART) NEW CONCRETE SOFTSCAPE

(3/8"- CRUSHED ROCK)

NEW PAVERS IN HOLLAND PATTERN PER CITY STANDARD

"-2" DECORATIVE ROCK

MULCH

PROPERTY LINE

48"h FULL CUT-OFF PEDESTRIAN LOW VOLTAGE LED LIGHT BOLLARD (TYP OF 6)

● -- ● 150' FIRE HOSE REACH

SITE PLAN NOTES

- 1. REFER TO SHEETS 5&6 of 10 FOR CIVIL INFORMATION INCLUDING GRADING AND
- UTILITIES. 2. REFER TO SHEET 7&8 of 10 FOR ALL LANDSCAPING INFORMATION.
- 3. INFORMATIONAL ONLY: SIGNAGE IS NOT APPROVED WITH THIS CONCEPT/DEVELOPMENT
- 4. FLOOD LIGHTING IS PROHIBITED. 5. ALL LIGHTING SHALL BE ARRANGED TO REFLECT AWAY FROM ADJOINING PROPERTIES AND PUBLIC RIGHT-OF-WAYS AND SHALL BE SHIELDED TO CONTAIN ALL DIRECT RAYS ON SITE. ALL LIGHTING FIXTURES SHALL BE FULL SHIELD CUT-OFF.
- 6. ALL EXISTING CURB, GUTTER, AND SIDEWALK POSING A SAFETY HAZARD, DAMAGED, EXHIBITING EXCESSIVE DETERIORATION OR NOT MEETING CURRENT CITY ENGINEERING STANDARDS ALONG SOUTH NEVADA AVENUE ADJACENT TO THE SITE WILL NEED TO BE REMOVED AND REPLACED PRIOR TO ISSUING THE CERTIFICATE OF OCCUPANCY (C.O.). AN ON-SITE MEETING CAN BE SET UP WITH THE ENGINEERING DEVELOPMENT REVIEW INSPECTOR TO DETERMINE WHAT, IF ANY, IMPROVEMENTS ARE REQUIRED. THE INSPECTOR CAN BE REACHED AT 719-385-5977 7. ALL BUILDINGS ASSOCIATED WITH THIS
- DEVELOPMENT PLAN ARE LOCATED OUTSIDE OF THE FLOODWAY.

FLOODPLAIN NOTE

1. NO PORTION OF THE SUBJECT PROPERTY IS LOCATED WITHIN THE 100 YEAR FLOOD PLAIN, ACCORDING TO FIRM #08041C0729 F EFFECTIVE 03/17/17.

SITE PLAN KEYNOTES

- <1> PORTION OF (E) CURB CUT TO REMAIN (IN USE BY NEIGHBORING PROPERTY)
- EXISTING STREET TREE IN 4'x4' CAST IRON TREE GRATE W/ RAISED 6" CURB AROUND PERIMETER
- (3) NEW CONCRETE SIDEWALK
- NEW 5' WIDE INTERLOCKING PAVER AMENITY ZONE 🗸 LAID IN HOLLAND PATTERN PER CITY STANDARD
- (E) TYPE 1 CURB AND GUTTER TO REMAIN (TYP <5> ù.Ń.O.)
- $\langle 6 \rangle$ 1/4" CRUSHED ROCK (BREEZE)
- (7) NEW ASPHALT PARKING W/ 4" WIDE WHITE STRIPING
- TRASH ENCLOSURE / GEAR STORAGE IN 8'x9'x40' SHIPPING CONTAINER
- (9) NEW BUS SHELTER
- (10) INVERTED 'U' BIKE RACK
- LINE OF UPPER FLOOR/CANOPY OVERHANG ABOVE
- (12) PEDESTRIAN ENTRY
- (13) STRIPED FOR "NO PARKING" OR "LOADING ZONE"
- NEW LANDSCAPING AND GROUNDCOVER PER ∵ LANDSCAPE PLAN
- (15) EXISTING UTILITY POLE TO REMAIN
- FULL CUT-OFF POLE MOUNTED SITE LIGHT PER ELECTRICAL DRAWINGS
- 17 NEW TYPE 1 CURB AND GUTTER
- (18) PROPOSED PARKING METER
- NEW STREET TREE IN 4'x4' CAST IRON TREE GRATE W/ RAISED 6" CURB AROUND PERIMETER
- EXISTING PARKING STALL (ON ADJACENT PROPERTY TO BE REMOVED)
- 27"h PEDESTRIAN LIGHT BOLLARD PER ELECTRICAL DRAWINGS

PARKING SUMMARY

REQUIRED: (PER COS FBZ SECTION 2.6) LODGING: ONE STALL PER UNIT X 40 UNITS = 40 STALLS

PROVIDED:
36 STANDARD PARKING STALLS 9 COMPACT PARKING STALLS 3 PARALLEL "LOADING ZONE" STALLS ACCESSIBLE PARKING STALLS TOTAL: 50 STALLS PROVIDED

ZONING DATA

ZONE: FBZ-COR <u>SITE AREAS:</u> 37,240 S.F. TOTAL SITE AREA: <u>AREA OF WORK:</u> 37,240 S.F. **BUILDING AREA (GROSS):** 23,986 S.F. BUILDING TYPE: MIXED-USE ALLOWABLE BUILDING HEIGHT: 10 STORIES (CH 2.3.4) ACTUAL BUILDING HEIGHT: 4 STORIES (52') SETBACKS REQUIRED: (CH 2.3.3) FRONT: O' MAX SIDE: 10' MAX

SETBACKS PROPOSED:

S NEVADA AVE: FRONT: SIDE (NORTH): 68'-5" SIDE (SOUTH): 4'-0" 91'-9 1/2" REAR:

WARRANT NOTE: A WARRANT HAS BEEN REQUESTED FOR THE INCREASED SIDE SETBACK AT THE NORTH PROPERTY LINE.

REAR: O'MIN

ENCROACHMENTS PROPOSED: FOUR ENCROACHMENTS ARE PROPOSED AT THE WEST PROPERTY LINE: CANOPY: 5'-8"

PATIO: 5'-8" 3'-8" BUILDING OVERHANG: 1'-8" BALCONY OVERHANG: REVOCABLE PERMIT NOTE: A REVOCABLE PERMIT HAS BEEN REQUESTED FOR THE FOUR

ENCROACHMENTS AT THE WEST PROPERTY LINE. FRONTAGE TYPE (CH 2.4): SHOPFRONT

THE PERCENTAGE OF FIRST FLOOR GLAZING EQUALS THE PERCENTAGE OF TRANSPARENT GLASS ALONG THAT PORTION OF THE FACADE BETWEEN 18" AND 10' IN HEIGHT RUNNING PARALLEL TO THE FRONT PROPERTY

> LINEAR FOOTAGE OF GLAZING: 75' LINEAR FOOTAGE OF BUILDING RUNNING PARALLEL TO THE FRONT PROPERTY LINE:

PERCENTAGE GLAZING: 75/124 = 60%PERCENTAGE GLAZING REQ'D FOR

SHOPFRONT FRONTAGE TYPE: 60%

ACCESSIBILITY: ALL NEW ACCESS POINTS WILL MEET ADA STANDARDS. THE DESIGN PROFESSIONAL RESPONSIBLE FOR THIS PLAN HAS FAMILIARIZED THEMSELVES WITH ALL CURRENT ADA CRITERIA AND SPECIFICATIONS AND THE PROPOSED

ELEMENTS.

PHASING NOTES 1. PHASE 1: NEW 4-STORY BUILDING AS SHOWN. PARKING LOT AND STREETSCAPE IMPROVEMENTS.

SCHEDULE: START CONSTRUCTION EARLY 2019, COMPLETE SPRING 2020 2. PHASE 2: NEW BUILDING TBD ON NORTH PORTION

SCHEDULE: START CONSTRUCTION BY FOURTH QUARTER 2021.

PLAN REFLECTS REQUIRED SITE

PROJECT DATA

PROJECT TYPE: COMMERCIAL PROJECT SUMMARY: NEW (4) STORY HOTEL BUILDING FIRST FLOOR: LOBBY AND CAFE FLOORS 2-4: HOTEL UNITS

ROOM COUNTS: DORM ROOMS: 6 (48 BEDS) PRIVATE ROOMS: 27 PRIVATE SUITES: 7

PROJECT ADDRESS: 415 SOUTH NEVADA AVE COLORADO SPRINGS, CO 80903

<u>TSN:</u> 6418411009

LEGAL DESCRIPTION: LOTS 4, 5, 6 AND THE SOUTH 21' OF LOT 3 AND THE NORTH 25' OF LOT 7, ALL IN BLOCK 133, IN THE CITY OF COLORADO

SPRINGS, COUNTY OF EL PASO, STATE OF COLORADO, ACCORDING TO THE PLAT THEREOF RECORDED IN PLAT BOOK A AT PAGE 1 OF THE RECORDS OF SAID COUNTY,

40 ROOMS

AND CONTAINING 0.86 ACRES.

54 PLAT #: LUR FILE #: AR DP 18-00302

SHEET INDEX

1 of 10 GENERAL INFORMATION / ARCHITECTURAL SITE PLAN 2 of 10 EXTERIOR ELEVATIONS

3 of 10 EXTERIOR ELEVATIONS 4 of 10 EXTERIOR RENDERINGS

5 of 10 PRELIMINARY UTILITY PLAN 6 of 10 PRELIMINARY GRADING PLAN

LANDSCAPE AND SITE FURNISHING PLAN 8 of 10 SITE DETAILS

9 of 10 SITE LIGHTING PLAN

10 of 10 ELECTRICAL DETAILS

CONTACTS

MEP:

KINSHIP LANDING LTD OWNER: 415 SOUTH NEVADA AVE COLORADO SPRINGS, CO 80903 CONTACT: BOBBY & BROOKE MIKULAS 719.650.4887 bobby@kinshiplanding.com

ARCHITECT: ECHO ARCHITECTURE 4 SOUTH WAHSATCH AVENUE #120

COLORADO SPRINGS, CO 80903 CONTACT: RYAN LLOYD 719.387.7836

brooke@kinshiplanding.com

ryan@echo-arch.com

TERRA NOVA ENGINEERING, INC. 721 S. 23RD STREET

COLORADO SPRINGS, CO 80904 CONTACT: LUANNE DUCETT 719.635.6422


FARNSWORTH GROUP 4755 FORGE ROAD, SUITE 150

COLORADO SPRINGS, CO 80907 CONTACT: AMANDA OCCHI

719.301.1818

STRUCTURAL: HCDA ENGINEERING 545 EAST PIKES PEAK AVE. #100 COLORADO SPRINGS, CO 80903

> CONTACT: STEVE HORNER 719.633.7784 shorner@hcdaengineering.com

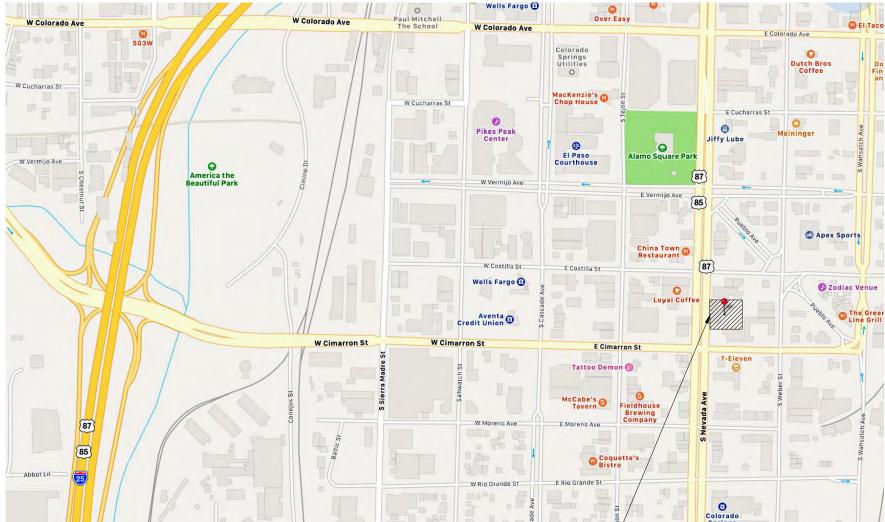

PROJECT LOCATION —

VICINITY MAP

SITE PLAN/GENERAL INFO LUR FILE #: AR DP 18-00302

80903

00

RING

S

 \triangleleft

 \triangleleft

Z

AR ITECTURE

415 S NEVADA AVE date: COLORADO SPRINGS

ECHO ARCHITECTURE 4 south wahsatch ave #120 colorado springs, co 80903

RCL sheet #: www.echo-arch.com 1 of 10 t 719.387.7836

09.28.2018

DEV. PLAN

drawn by:

 EXTENT, SIZE, AND LOCATION OF SIGNAGE IS TO BE DETERMINED. 2. SIGN SUBMITTAL, REVIEW, AND APPROVAL WILL OCCUR AT A LATER DATE.

CO 80903 RINGS VADA SP COLORADO

EXTERIOR ELEVATIONS LUR FILE #: AR DP 18-00302



415 S NEVADA AVE date:

DEV. PLAN

drawn by: RCL www.echo-arch.com t 719.387.7836

COLORADO SPRINGS ECHO ARCHITECTURE 4 south wahsatch ave #120 colorado springs, co 80903

· CANTILE VERED BALCONY


(ENCROACHES

— FULL CUT—OFF WALL LIGHT PER ELECTRICAL

(TYPICAL OF (3)

THIS FACADE)

3'-0" GLAZING PAINTED STEEL PLANTERS (PATINA GREEN) -— DARK BRONZE ALUMINUM STOREFRONT ENTRY PERFORATED METAL GUARDRAIL AT PATIO ENCLOSURE (PATINA GREEN) —

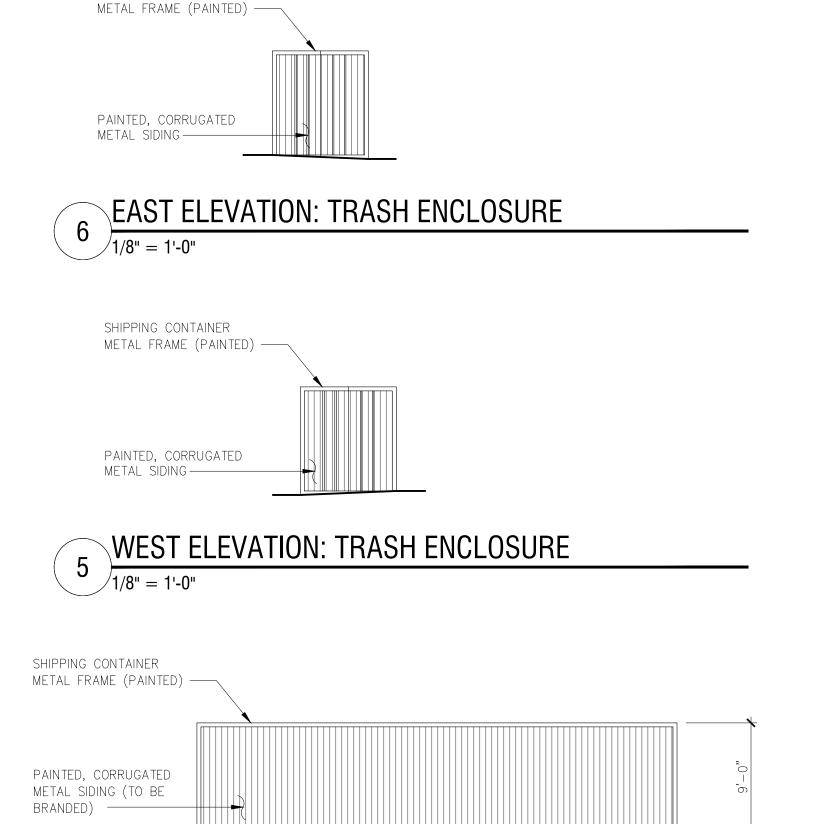

NORTH ELEVATION: TRASH ENCLOSURE

SOUTH ELEVATION: TRASH ENCLOSURE

WOOD SIDING

WHITE STUCCO

WINDOW (TYP) -

JULIET BALCONY (TYPICAL

DARK BRONZE ALUMINUM

DARK BRONZE ALUMINUM GLAZED OVERHEAD DOOR

(TYP AT BALCONIES) -

CANTILEVERED BALCONY

(ENCROACHES 20") —

PERFORATED METAL GUARDRAIL AT BALCONY (PATINA GREEN) TYPICAL—

PREFINISHED ALUMINUM

CANOPY AND WRAP

STOREFRONT ENTRY -

GREY FACE BRICK ---

(PATINA GREEN) —

DARK BRONZE ALUMINUM

WEST ELEVATION

UNLESS NOTED OTHERWISE) PREFINISHED METAL COPING (DARK BRONZE ALUMINUM) -

SHIPPING CONTAINER

1/8" = 1'-0"

FULL CUT-OFF WALL LIGHT PER ELECTRICAL ---CUSTOM STEEL DOOR W/ PAINTED EXPANDED STÉEL TO

MATCH BUILDING-

METAL SIDING

SHIPPING CONTAINER

PAINTED, CORRUGATED

METAL FRAME (PAINTED) ──►

1/8" = 1'-0"





EXTENT, SIZE, AND LOCATION OF SIGNAGE IS TO BE DETERMINED.
 SIGN SUBMITTAL, REVIEW, AND APPROVAL WILL OCCUR AT A LATER DATE.

NEVADA SPRINGS 421 SOUTH COLORADO

CO 80903

RINGS,

EXTERIOR RENDERINGS LUR FILE #: AR DP 18-00302



415 S NEVADA AVE date: 09.28.2018

drawn by: RCL ECHO ARCHITECTURE
4 south wahsatch ave #120
colorado springs, co 80903
www.echo-arch.com
t 719.387.7836

RCL
sheet #:
4 of 10

COLORADO SPRINGS Phase: DEV. PLAN



2 RENDERING LOOKING SOUTHEAST FROM NEVADA
NOT TO SCALE



RENDERING LOOKING NORTHWEST FROM PARKING LOT

NOT TO SCALE

KINSHIP LANDING


COLORADO SPRINGS, CO


PRELIMINARY UTILITY & PUBLIC FACILITIES PLAN

SEPTEMBER 2018


PROPERTY OWNERS ACKNOWLEDGE AND AGREE TO THE FOLLOWING UPON APPROVAL OF PRELIMINARY UTILITY PLAN:

- 1. COLORADO SPRINGS UTILITIES (SPRINGS UTILITIES) SHALL MAKE THE FINAL DETERMINATION OF THE LOCATION OF ALL WATER, WASTEWATER, ELECTRIC AND GAS FACILITIES, WHICH MAY NOT BE THE SAME LOCATION AS SHOWN ON THIS PRELIMINARY
- 2. PROPERTY OWNER(S) ("OWNER") ACKNOWLEDGES THAT THE CONNECTION AND/OR EXTENSION OF UTILITY SERVICES TO THE PROPERTY IDENTIFIED IN THIS PRELIMINARY UTILITY PLAN ("PROPERTY") SHALL BE IN ACCORD WITH ALL APPLICABLE CODES AND REGULATIONS, SPRINGS UTILITIES LINE EXTENSION AND SERVICE STANDARDS ("STANDARDS"), TARIFFS, COLORADO SPRINGS CITY CODE, RESOLUTIONS, AND POLICIES, AND PIKES PEAK REGIONAL BUILDING DEPARTMENT CODES. IN EFFECT AT THE TIME OF UTILITY SERVICE CONNECTION AND/OR EXTENSION.
- 3. OWNER ACKNOWLEDGES RESPONSIBILITY FOR THE COSTS OF EXTENSIONS OR UTILITY SYSTEM IMPROVEMENTS THAT SPRINGS UTILITIES DETERMINES NECESSARY TO PROVIDE UTILITY SERVICES TO THE PROPERTY OR TO ENSURE TIMELY DEVELOPMENT OF INTEGRATED UTILITY SYSTEMS SERVING THE PROPERTY AND AREAS OUTSIDE THE PROPERTY (INCLUDING THE COSTS TO DESIGN AND INSTALL WATER SYSTEMS, WASTEWATER COLLECTION SYSTEMS, AND ANY GAS OR ELECTRIC LINES TO AND WITHIN THE PROPERTY). OWNER MAY BE ELIGIBLE FOR A COST RECOVERY AGREEMENT AS PROVIDED IN UTILITIES RULES AND REGULATIONS.
- 4. SPRINGS UTILITIES UTILITY SERVICES ARE AVAILABLE ON A "FIRST-COME FIRST-SERVED" BASIS, AND THEREFORE NO SPECIFIC ALLOCATIONS OR AMOUNTS OF UTILITY SERVICES, FACILITIES, CAPACITIES OR SUPPLIES ARE RESERVED FOR THE OWNER, AND SPRINGS UTILITIES MAKES NO COMMITMENT AS TO THE AVAILABILITY OF ANY UTILITY SERVICE UNTIL SUCH TIME AS AN APPLICATION FOR PERMANENT SERVICE IS APPROVED BY SPRINGS UTILITIES.
- 5. THE RELOCATION OR ALTERATION OF ANY EXISTING UTILITY FACILITIES WITHIN THE PROPERTY WILL BE AT THE OWNER'S SOLE COST AND EXPENSE. IF SPRINGS UTILITIES DETERMINES THAT OWNER'S RELOCATION OR ALTERATION REQUIRES NEW OR UPDATED EASEMENTS, OWNER SHALL CONVEY THOSE EASEMENTS PRIOR TO RELOCATION OR ALTERING THE EXISTING UTILITY FACILITIES.
- 6. OWNER SHALL DEDICATE BY PLAT AND/OR CONVEY BY RECORDED DOCUMENT, ALL PROPERTY AND EASEMENTS THAT SPRINGS UTILITIES DETERMINES ARE REQUIRED FOR ALL UTILITY SYSTEM FACILITIES NECESSARY TO SERVE THE PROPERTY OR TO ENSURE DEVELOPMENT OF AN INTEGRATED UTILITY SYSTEM. ALL EASEMENTS GRANTED BY SEPARATE INSTRUMENT SHALL UTILIZE SPRINGS UTILITIES' THEN-CURRENT PERMANENT EASEMENT AGREEMENT FORM.
- 7. THE WATER SYSTEM FACILITIES MUST MEET SPRINGS UTILITIES CRITERIA FOR WATER QUALITY, RELIABILITY AND PRESSURE, INCLUDING LOOPING REQUIREMENTS (SEE SPRINGS UTILITIES LINE EXTENSION AND SERVICE STANDARDS).
- 8. OWNER RECOGNIZES THAT THE EXTENSION OF WATER SYSTEM FACILITIES MAY AFFECT THE QUALITY OF WATER IN THE SPRINGS UTILITIES WATER SYSTEM. WHEN WATER QUALITY IS AFFECTED, OWNER ACKNOWLEDGES RESPONSIBILITY FOR ANY COSTS THAT SPRINGS UTILITIES DETERMINES NECESSARY IN ORDER TO MAINTAIN WATER QUALITY IN ITS SYSTEM AS A RESULT OF OWNER'S WATER SYSTEM EXTENSIONS. OWNER MAY BE REQUIRED TO SUBMIT A WATER QUALITY PLAN FOR THE PROJECT.
- 9. OWNER MUST CONTACT SPRINGS UTILITIES FIELD ENGINEERING TO DETERMINE THE LOCATION OF ALL NATURAL GAS AND ELECTRIC METERS AND TRANSFORMERS AND SECURE APPROVAL OF GAS-SERVICE-LINE PRESSURES IN EXCESS OF SPRINGS UTILITIES STANDARD GAS SYSTEM PRESSURE. (CONTACT FIELD ENGINEERING NORTH 668-4985 OR SOUTH 668-5564).
- 10. IT SHALL NOT BE PERMISSIBLE FOR ANY PERSON TO MODIFY THE GRADE OF THE EARTH WITHIN ANY SPRINGS UTILITIES EASEMENT OR RIGHTS OF WAY WITHOUT THE WRITTEN APPROVAL OF SPRINGS UTILITIES. IMPROVEMENTS, STRUCTURES AND TREES SHALL NOT BE LOCATED WITHIN UTILITY EASEMENT. SHALL NOT VIOLATE NATIONAL ELECTRIC SAFETY CODE (NESC) PROVISIONS AND CLEARANCES, AND SHALL NOT IMPAIR ACCESS OR THE ABILITY TO MAINTAIN UTILITY FACILITIES.
- 11. SPRINGS UTILITIES APPROVAL OF THIS PRELIMINARY UTILITY PLAN SHALL NOT BE CONSTRUED AS A LIMITATION UPON THE AUTHORITY OF SPRINGS UTILITIES TO APPLY ITS STANDARDS; AND IF THERE ARE ANY CONFLICTS BETWEEN ANY APPROVED DRAWINGS AND ANY PROVISION OF STANDARDS OR CITY CODE, THEN THE STANDARDS OR CITY CODE SHALL APPLY. SPRINGS UTILITIES' APPROVAL OF THIS PRELIMINARY UTILITY PLAN SHALL NOT BE CONSTRUED AS A LIMITATION UPON THE AUTHORITY OF THE CITY OF COLORADO SPRINGS OR SPRINGS UTILITIES TO ADOPT DIFFERENT ORDINANCES, RULES, REGULATIONS, RESOLUTIONS, POLICIES OR CODES WHICH CHANGE ANY OF THE PROVISIONS OF THE STANDARDS SO LONG AS THESE APPLY TO THE CITY GENERALLY AND ARE IN ACCORD WITH THE THEN-CURRENT TARIFFS, RATES AND POLICIES OF SPRINGS UTILITIES.

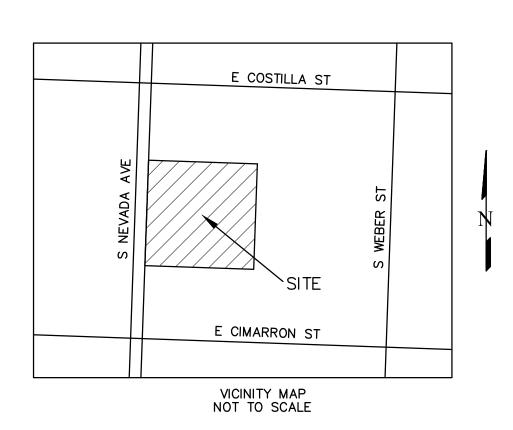


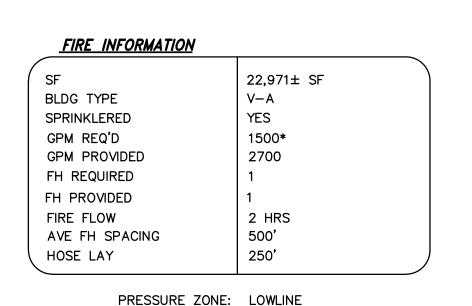



*SPRINKLER REDUCTION

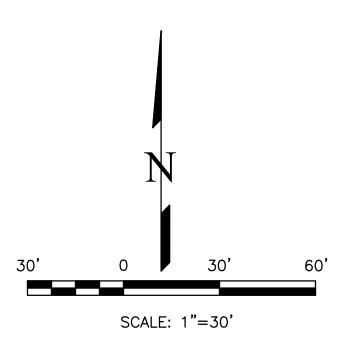

UTILITY PLAN LEGEND:

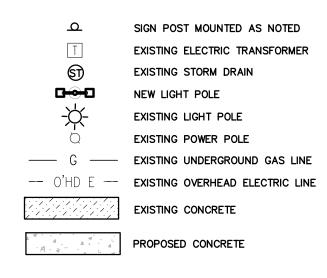

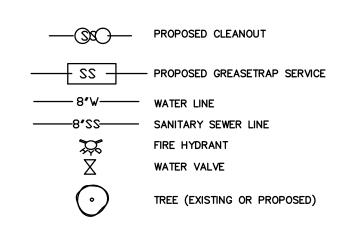

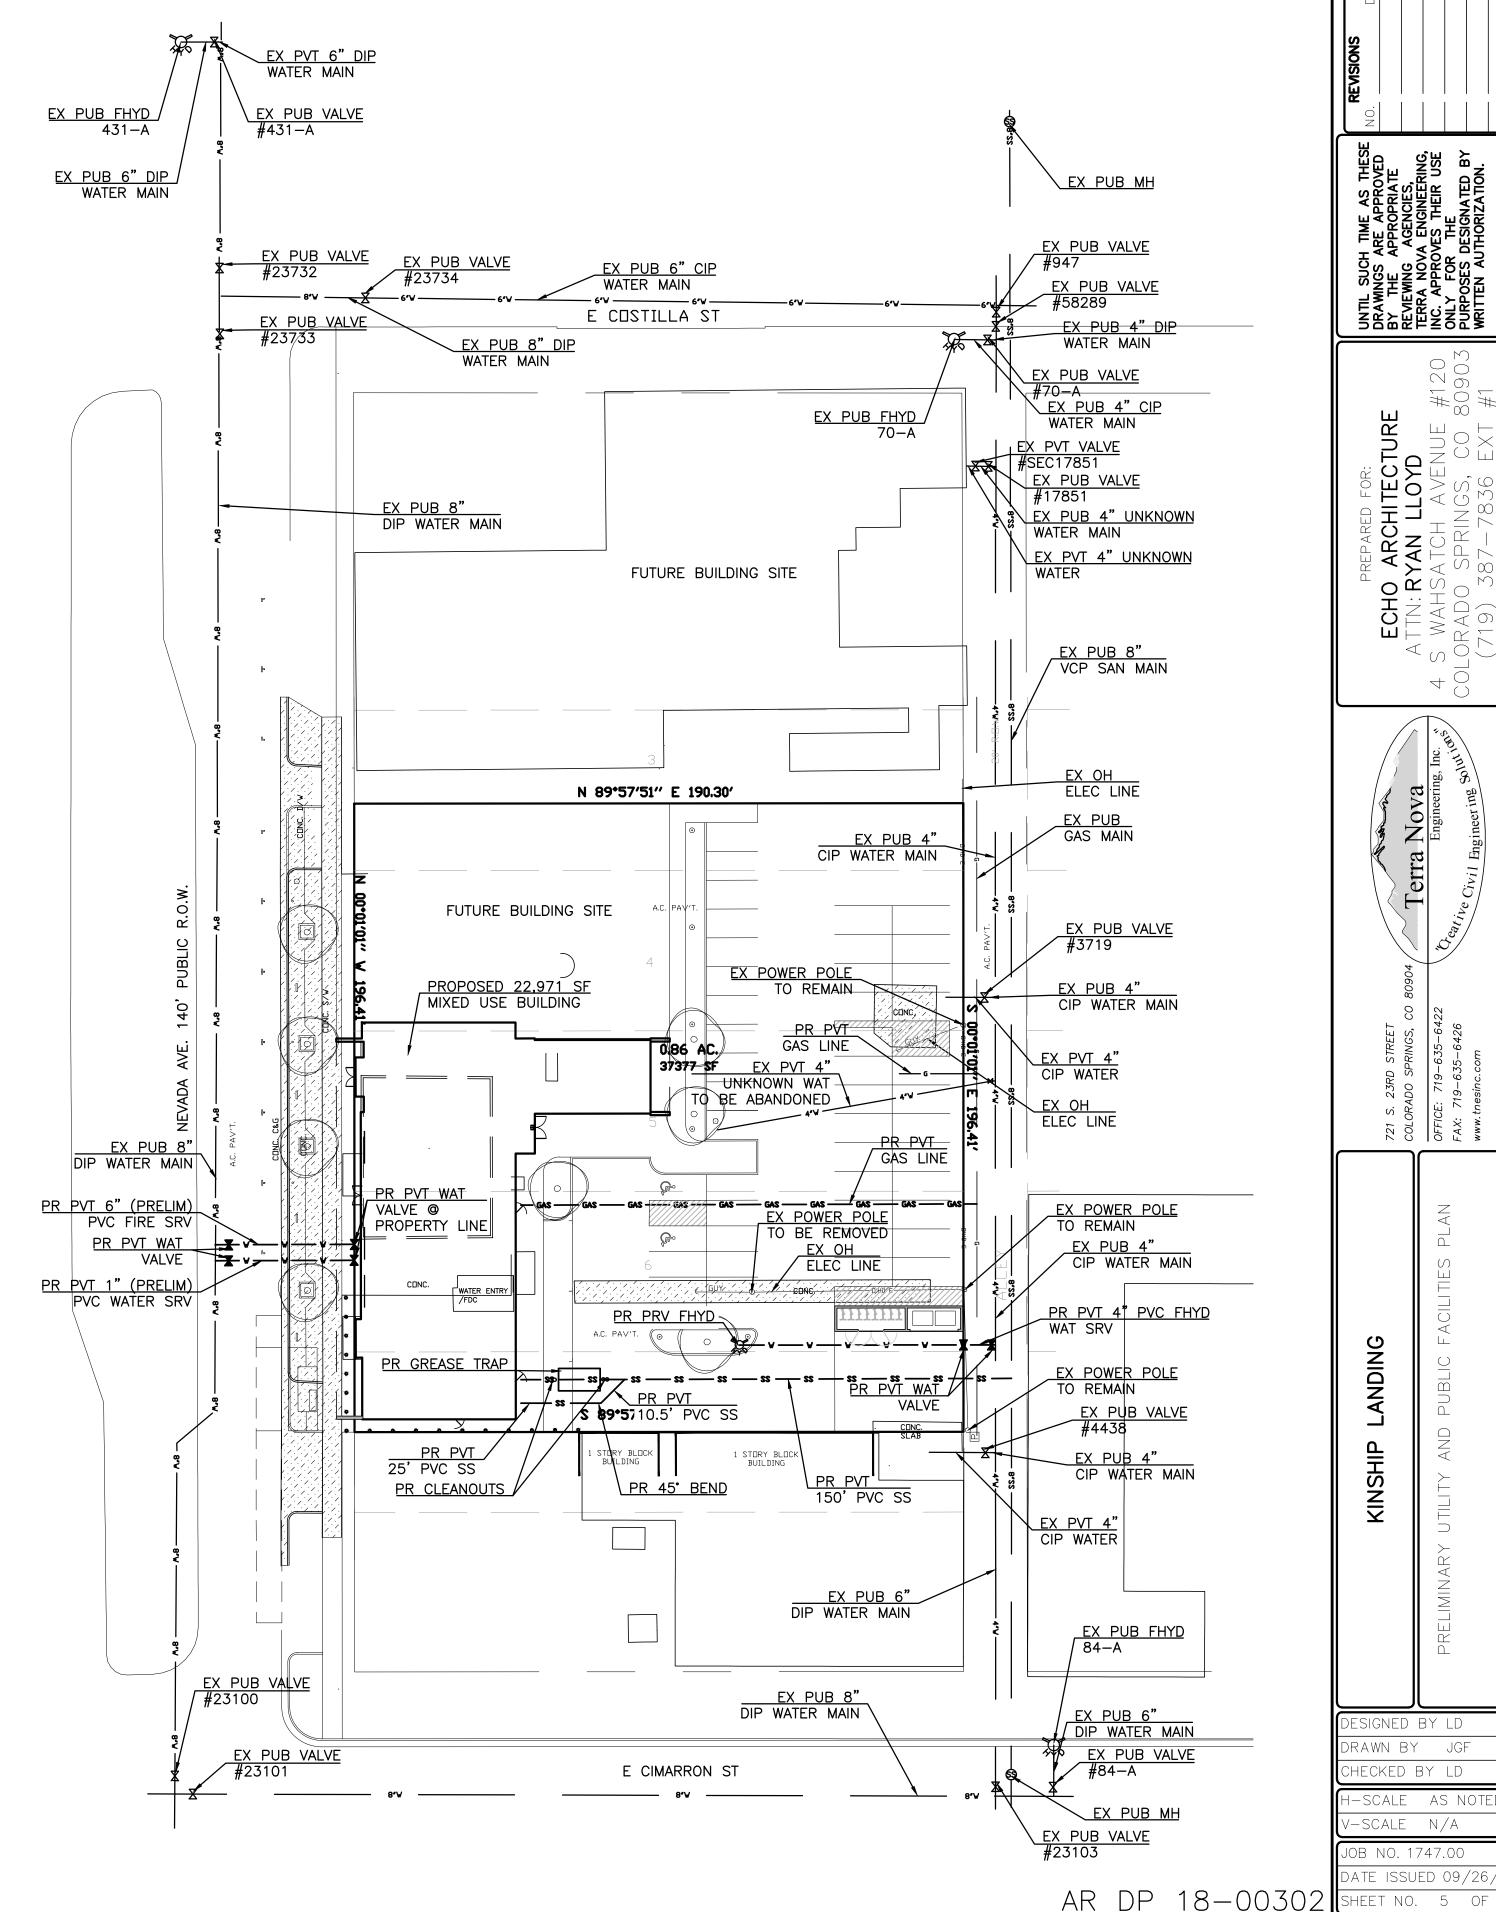

ESIGNED BY LD

RAWN BY JGF

HECKED BY LD

-SCALE N/A

OB NO. 1747.00

ATE ISSUED 09/26/

-SCALE AS NOTE


N:\jobs\1747.00\Drawings\174700 DP.dwg, PRELIM-GRAD, 9/26/2018 2:46:34 PN

KINSHIP LANDING

COLORADO SPRINGS, CO


PRELIMINARY GRADING PLAN


SEPTEMBER 2018

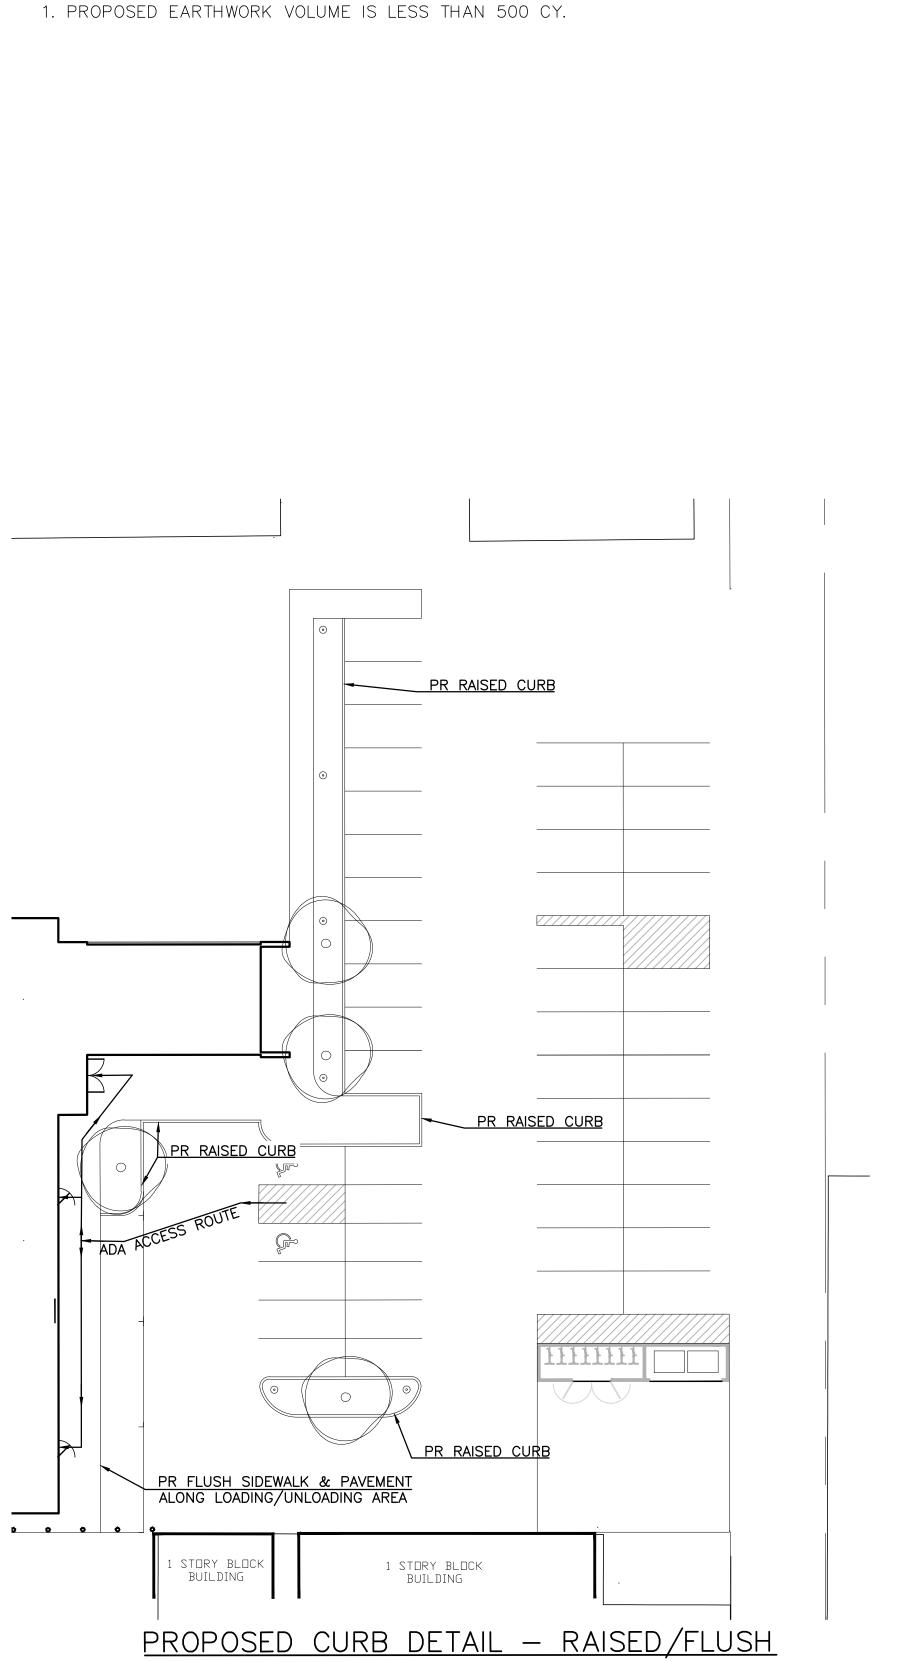

GRADING LEGEND

EXISTING CONTOURS — MINOR — —	<u>6132</u>
EXISTING CONTOURS — MAJOR — -	<u>6</u> 13 <u>0</u>
CONCRETE EDGE	CE
UNDERGROUND LOCATES (YELLOW FLAGS)	ULL(Y)
UNDERGROUND LINE LOCATES (RED FLAGS)	ULL(R)
UNDERGROUND LINE LOCATES (BLUE FLAGS)	ULL(B)
UNDERGROUND LINE LOCATES (ORANGE FLAGS)	ULL(O)
PROPOSED FINISHED GROUND	FG
PROPOSED FINISHED SURFACE	FS
PROPOSED FLOWLINE	FL
SPOT ELEVATION	SE
ASPHALT EDGE	AE
LOW POINT	LP
HIGH POINT	HP
EXISTING ELEVATION	12.00
GRADE & DIRECTION	2.2%
TERRAIN STRING	TS
BOUNDARY MONUMENT	ВМ
BUILDING CORNER	BC
PROPOSED CONTOUR	162
EXISTING SPOT GRADE	× EX 7314.00
PROPOSED SPOT GRADE	× 7314.00
PROPOSED TOP OF WALK	TW
PROPOSED HIGH POINT	HP
EXISTING CONCRETE	
PROPOSED CONCRETE	.4. 4

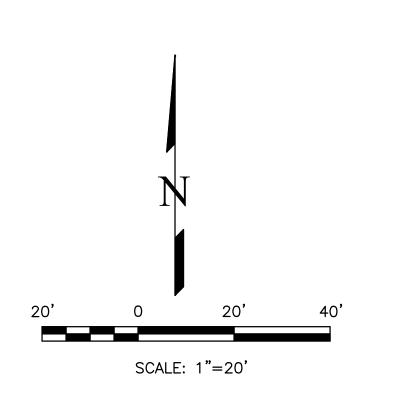


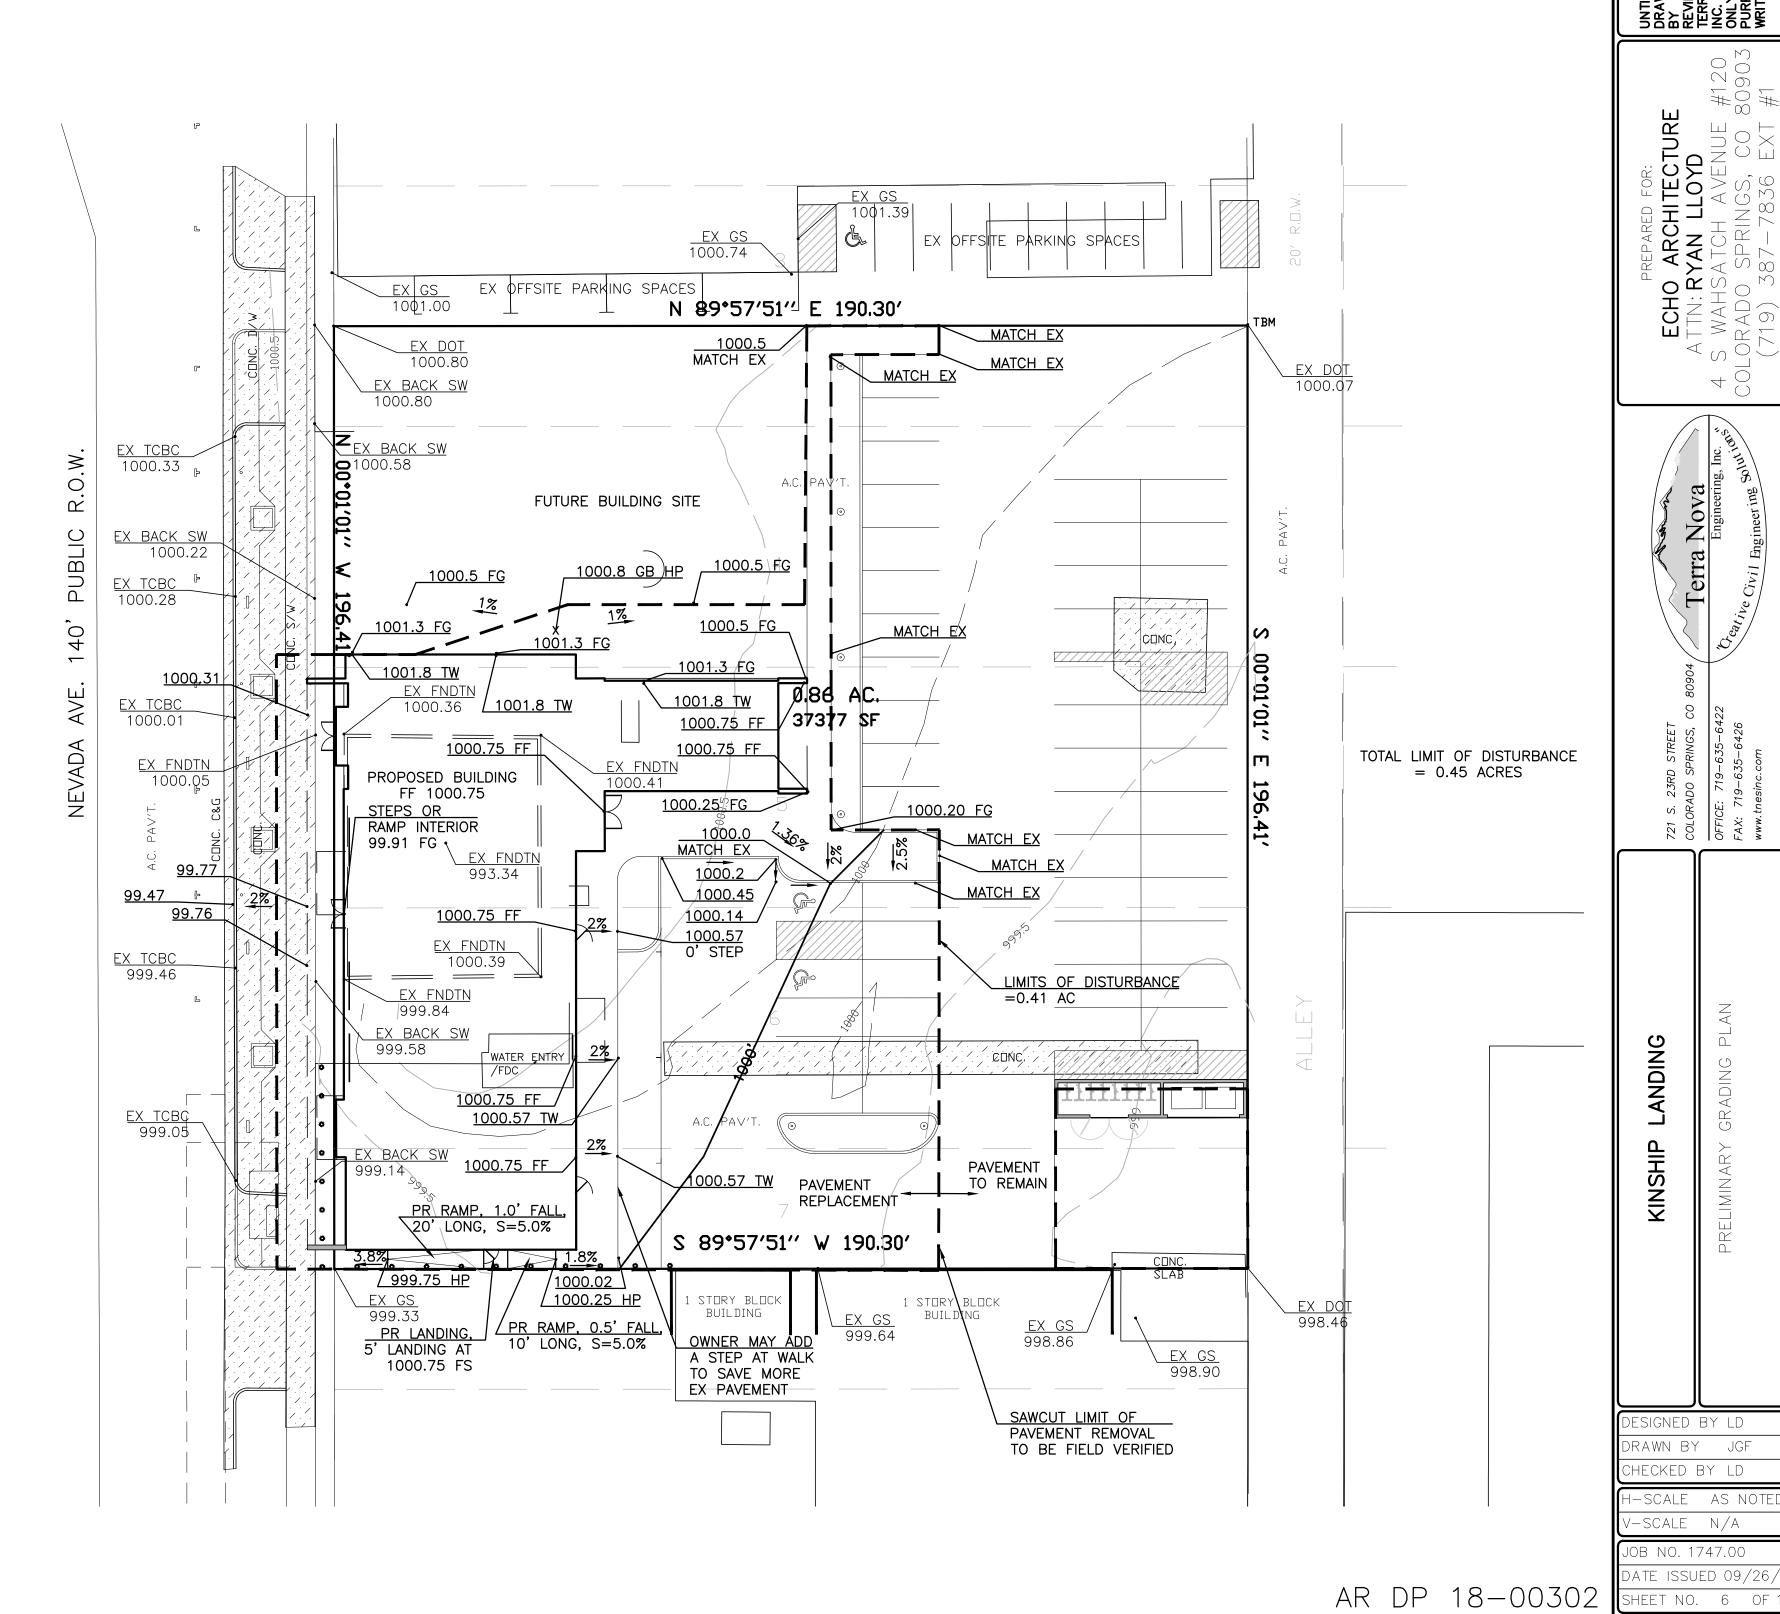


LANDSCAPE GENERAL NOTES

- 1. PROTECT ALL EXISTING STREET TREES SHOWN TO REMAIN FROM DAMAGE DURING CONSTRUCTION. ANY DAMAGE IS TO BE REPAIRED AND RESTORED BY THE CONTRACTOR TO
- ORIGINAL CONDITION. 2. LOCATE UTILITIES AND MAINTAIN THEIR LOCATION DURING ALL PHASES OF WORK. DO NOT
- DAMAGE UTILITY LINES/STRUCTURES. 3. ENSURE THAT ALL CONSTRUCTION INSTALLATION, MATERIALS, TESTING AND INSPECTION SHALL
- COMPLY WITH APPLICABLE CODES AND ORDINANCES. 4. TAKE ALL NECESSARY STEPS AS REQUIRED TO PROPERLY PROTECT AND MAINTAIN THIS WORK FOR THE DURATION OF THE CONTRACT.
- 5. ALL PLANTS WILL BE BALLED AND BURLAPPED OR CONTAINER GROWN. BARE ROOT OR SPADED PLANTS WILL NOT BE ACCEPTED.
- 6. PROPOSED SUBSTITUTIONS OF PLANT MATERIALS SHALL BE APPROVED BY THE ARCHITECT PRIOR TO ORDERING. 7. EXISTING STREET TREES TO REMAIN TO BE PRUNED.
- 8. ALL PLANTS SHALL MEET OR EXCEED STANDARDS SET BY THE "COLORADO NURSERY ASSOCIATION AND THE "AMERICAN STANDARD OF NURSERY STOCK". ALL PLANTS SHALL BE TYPICAL OF THEIR SPECIES, FULLY BRANCHED IN PROPORTION TO WIDTH AND HEIGHT AND HAVE A RELATIVELY STRAIGHT TRUNK WITH A CENTRAL LEADER.
- 9. CONTRACTOR SHALL AMEND PLANTING AREAS AS FOLLOWS: ADD MINIMUM OF 3 CUBIC YARDS OF WELL-COMPOSTED AGED MANURE OR PREMIUM COMPOST PER 1,000 S.F.
- 10. ALL AMENDED AREAS SHALL BE TILLED TO A DEPTH OF 6"PRIOR TO PLANTING.
- 11. ALL NEW TREES SHALL BE IRRIGATED BY AN AUTOMATIC DRIP IRRIGATION SYSTEM EQUIPPED WITH A RAIN SENSOR SHUTOFF DEVICE. ALL IRRIGATION PIPES TO BE SLEEVED.

SYMBOL	MARK	QNTY	GENUS	SPECIES	COMMON NAME	SIZE	SPACING	NOTES
	TREES							
	HNY	1	GLEDITSIA	TRIACANTHOS	HONEY LOCUST	6' MIN	AS SHOWN	(1) NEW (3) EXISTING
	MPL	2	ACER	TATARICUM	TATARIAN MAPLE	6' MIN	AS SHOWN	
	LND	2	TILIA	CORDATA	LITTLELEAF LINDEN	6' MIN	AS SHOWN	
	BRZ		CRUSHED ROCK	COTTONWOOD BREEZE	BREEZE	3/8"-	1 1/2" THICK	
	MLCH		MULCH	GOLD METRO MULCH	BARK MULCH		3" THICK MIN	
	ROK		DECORATIVE ROCK	2" BLACK MEXICAN BEACH PEBBLES	ROCK	1-2"		
	PVR		PAVER	_	_	_	PER DETAIL	PAVERS TO MATCH EXISTIN AMENITY ZONE PAVERS ON

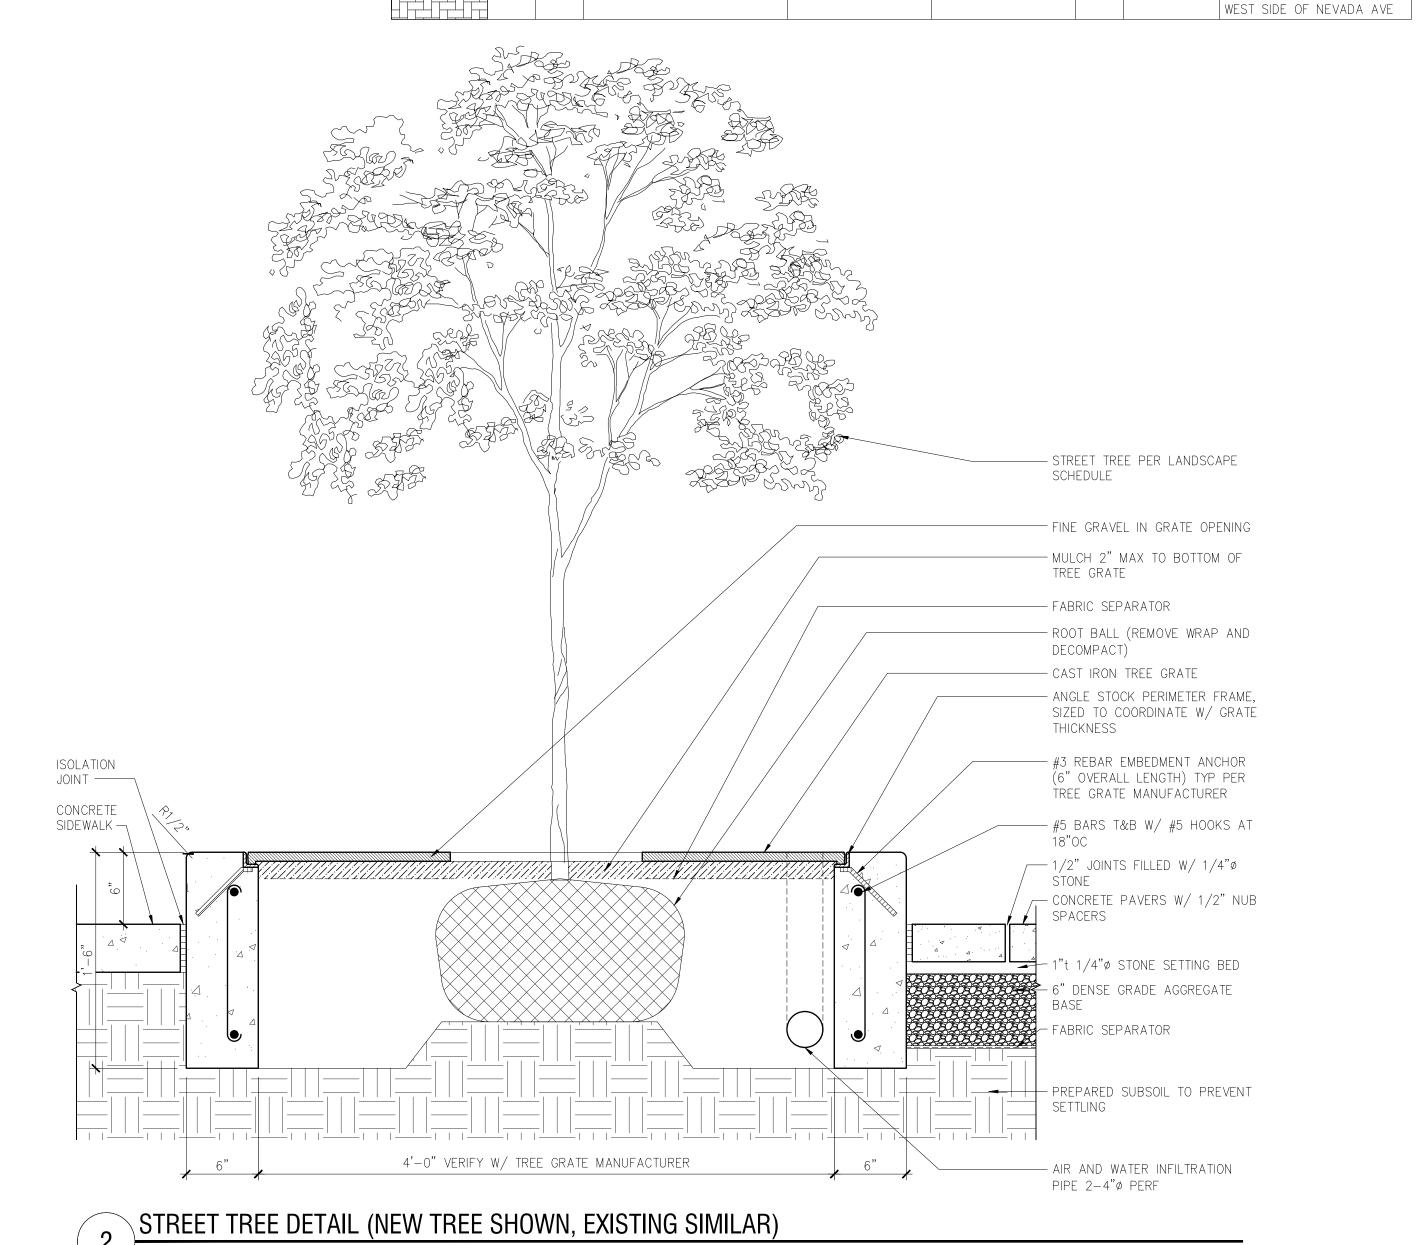

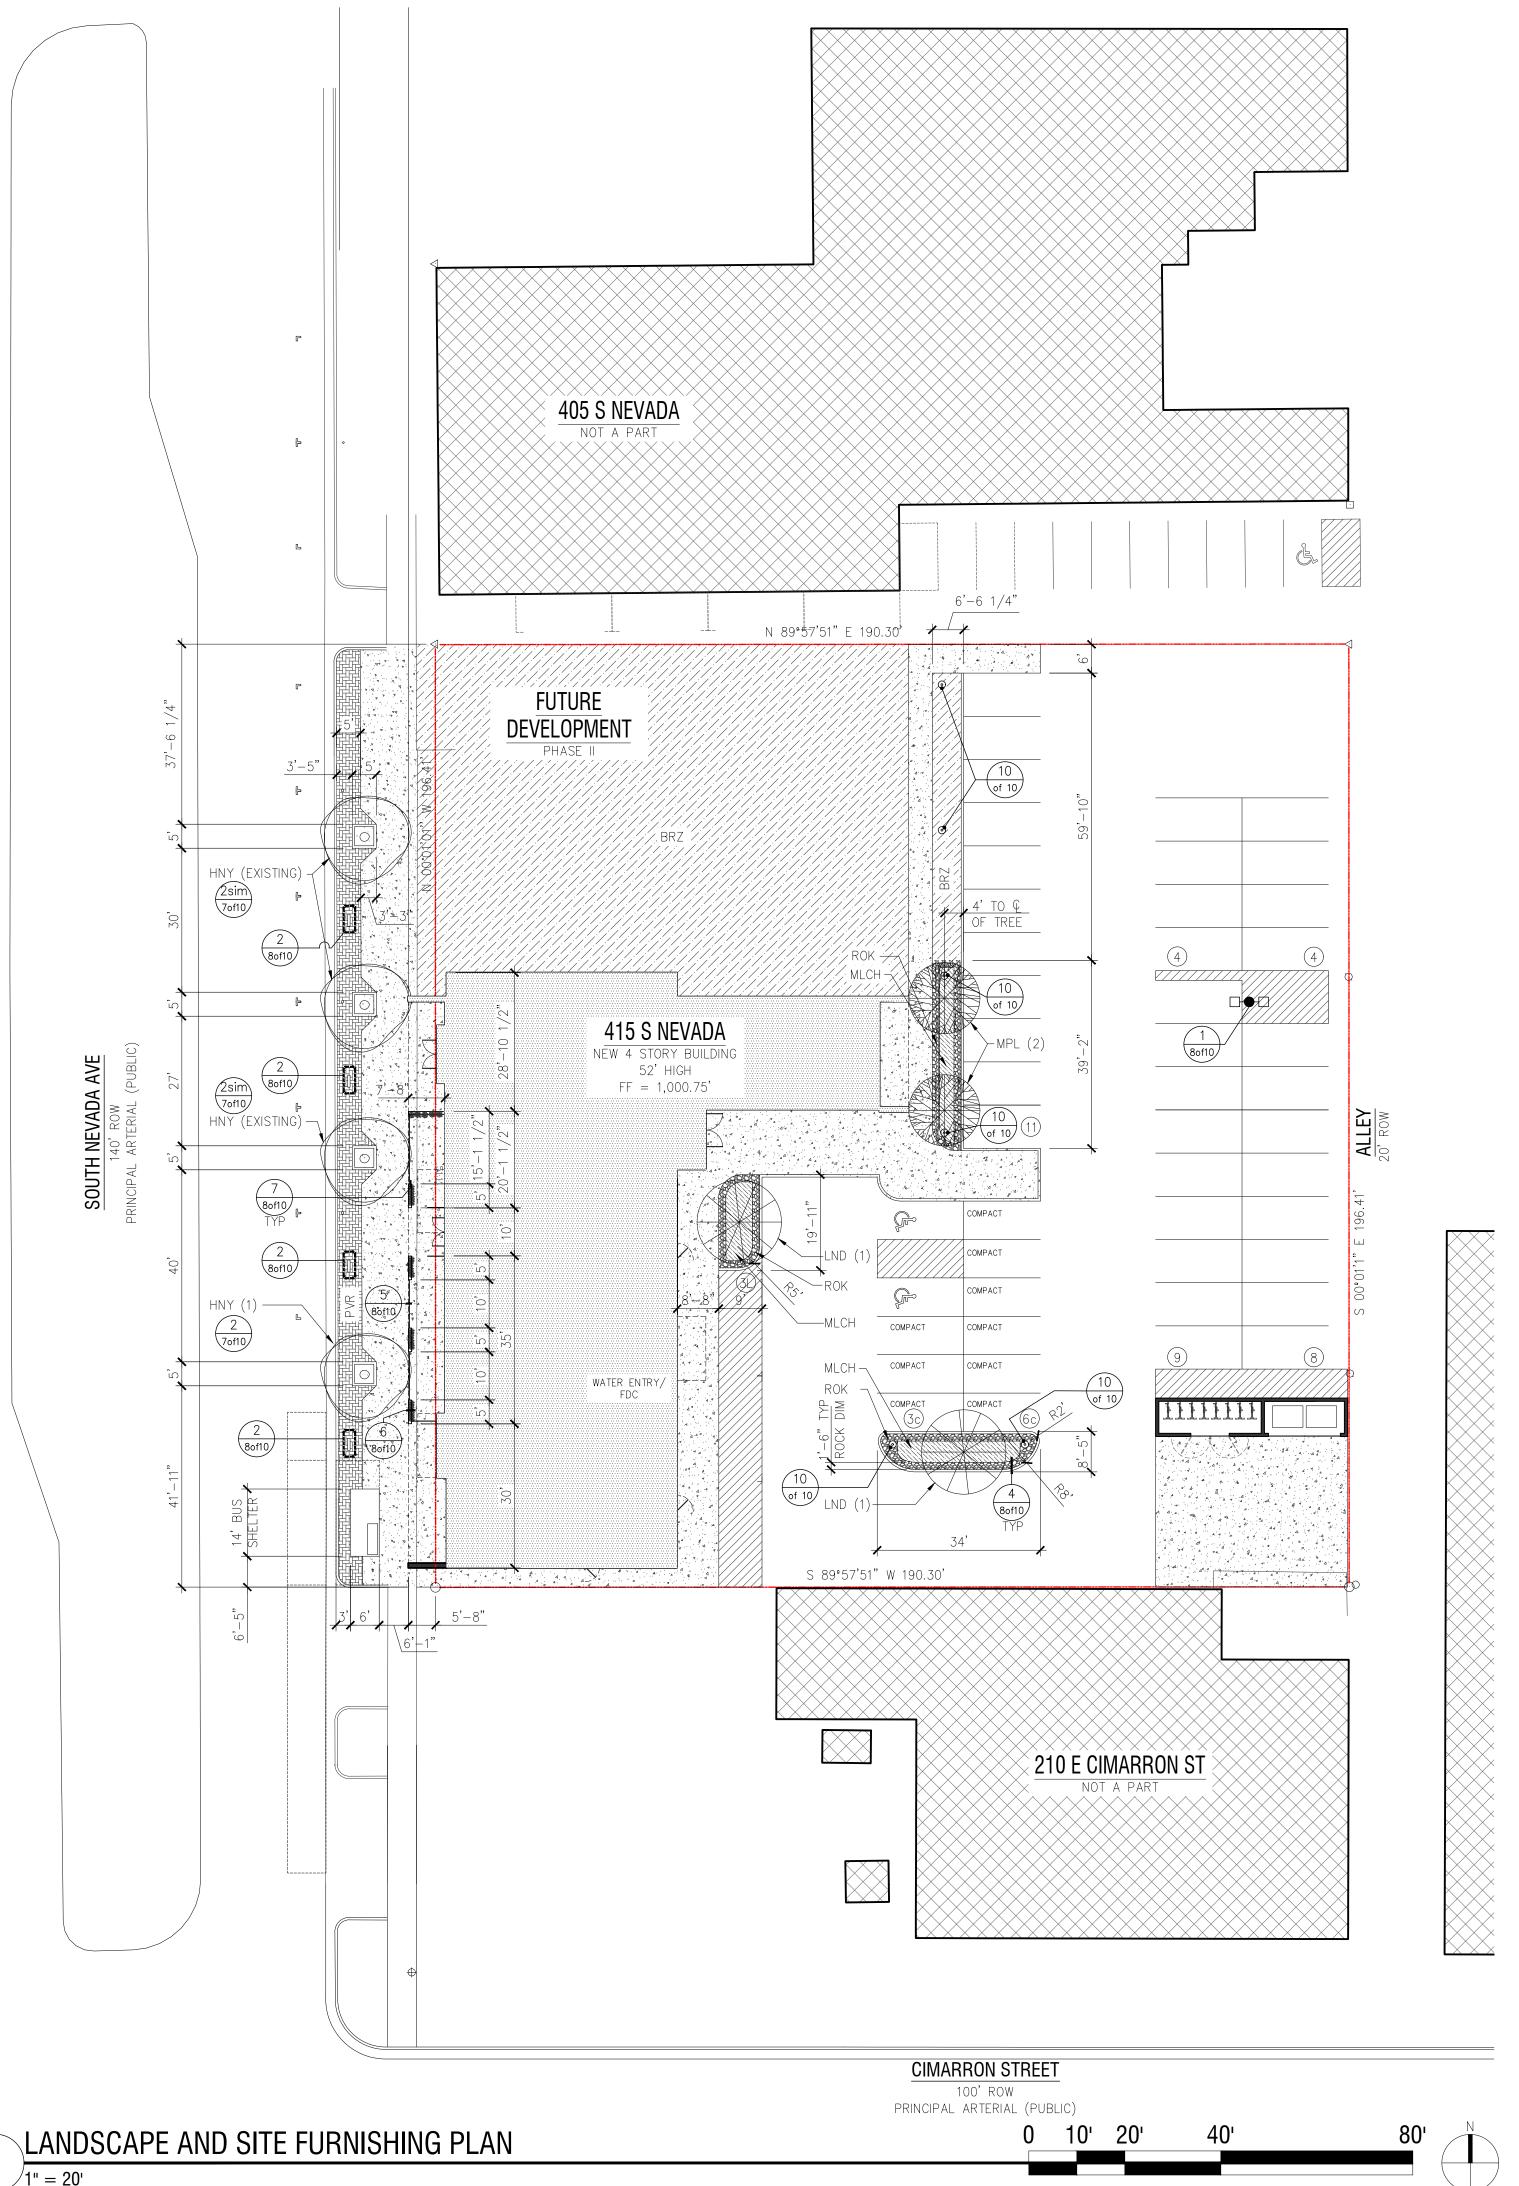

SITE PLAN LEGEND

NEW BUILDING

EXISTING BUILDING (NOT A PART)

NEW CONCRETE

SOFTSCAPE (3/8"- CRUSHED ROCK) NEW PAVERS IN HOLLAND PATTERN

PER CITY STANDARD

1"-2" DECORATIVE ROCK

PROPERTY LINE

27"h FULL CUT-OFF PEDESTRIAN LOW VOLTAGE LED LIGHT BOLLARD (TYP OF 6)

RING SP


SITE PLAN/GENERAL INFO LUR FILE #: AR DP 18-00302





415 S NEVADA AVE date: COLORADO SPRINGS

DEV. PLAN drawn by: ECHO ARCHITECTURE 4 south wahsatch ave #120 colorado springs, co 80903 www.echo-arch.com 7 of 10

t 719.387.7836

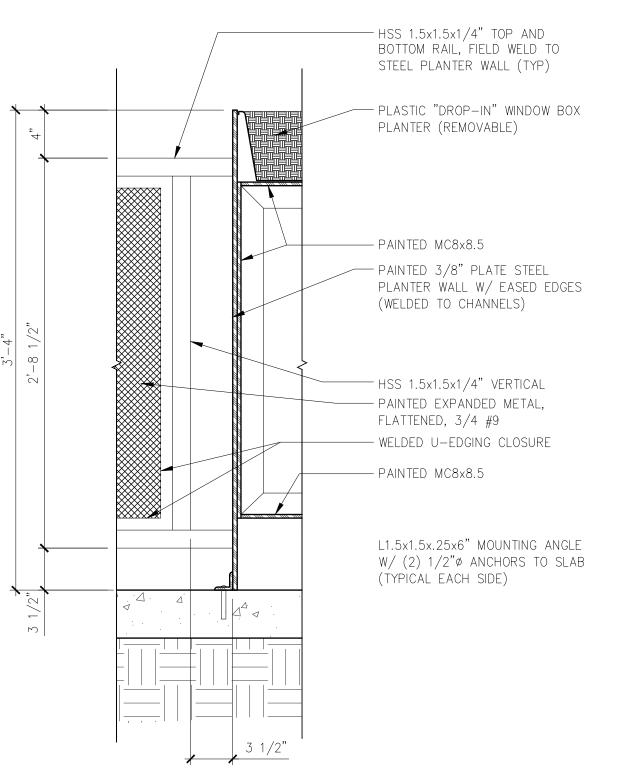

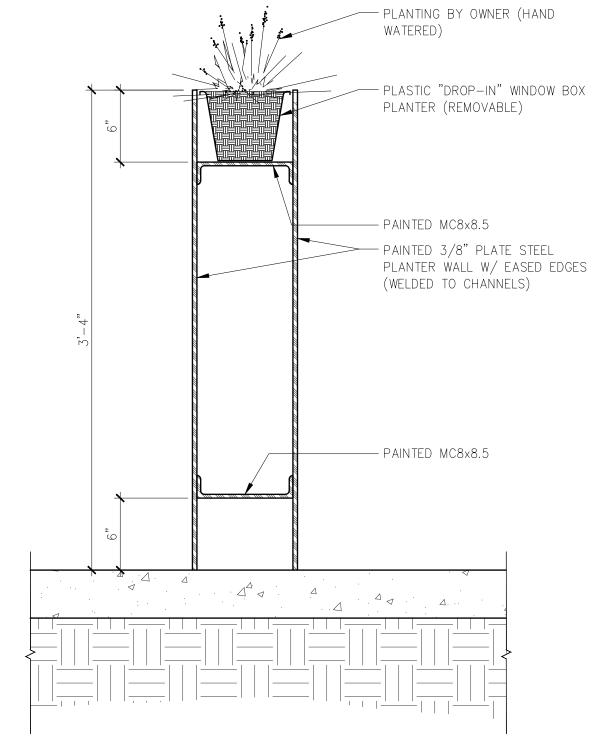

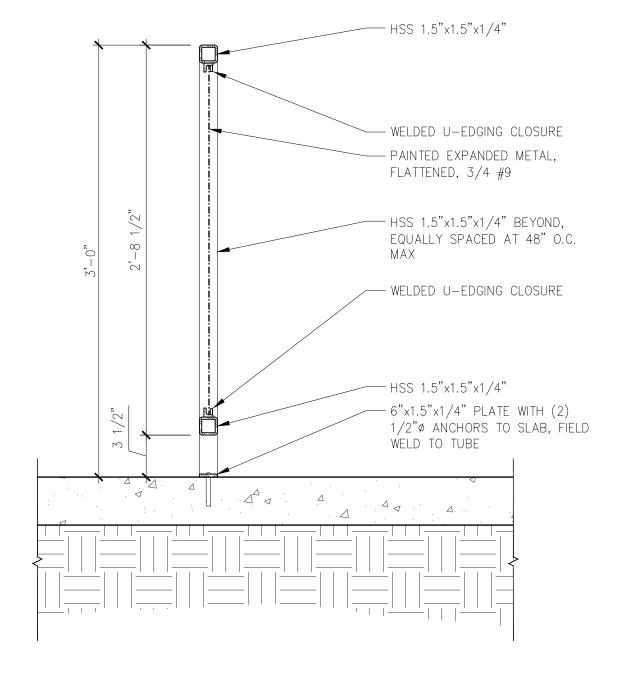

SITE PLANTER DETAIL (LONGITUDINAL SECTION)

1 1/2" = 1'-0"

6 SITE PLANTER DETAIL (CROSS SECTION)

1 1/2" = 1'-0"


2--0" Module Add to 3'-0"

/-1/2 C

C B-1

B-2

Module for 5' **Wide Paver Bands** 5 SITE RAIL DETAIL
1 1/2" = 1'-0"

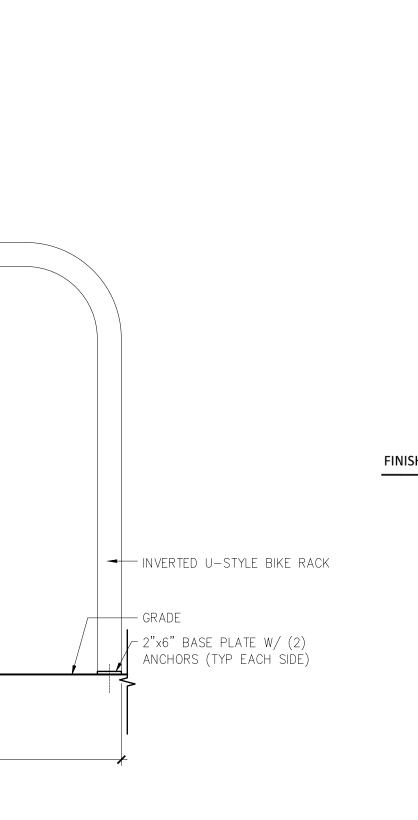

INVERTED U-STYLE BIKE RACK ELEVATION

ANCHOR BOLTS, BASE PLATE, AND ROUND BASE COVER PROVIDED W/ POLE. BOLT CIRCLE TEMPLATE PER MANUFACTURER'S INSTALLATION REQUIREMENTS. GROUT BASE COVER - COLOR TO MATCH ∕ 2" X 45 DEGREE POLES WITH EXPOSED BASES SHALL BE FORMED WITH SEAMLESS SONOTUBE FORMS. FINISHED GRADE 5'-0" CONDUIT IN AND OUT 30" BELOW GRADE (MINIMUM DEPTH) ─4#4 REBAR WITH #2 TIES - 12"O.C. **DETAIL - ELEVATED BASE**

SEE SCHEDULE

FULL CUT-OFF LED LUMINAIRE, SEE

SCHEDULE/PLAN FOR NUMBER OF

LUMINAIRES

STRAIGHT, SQUARE POLE

AR LITECTURE

SITE PLAN/GENERAL INFO

LUR FILE #: AR DP 18-00302

SP

COLORADO

415 S NEVADA AVE date: 09.28.2018 COLORADO SPRINGS

DEV. PLAN drawn by: RCL ECHO ARCHITECTURE 4 south wahsatch ave #120 colorado springs, co 80903 www.echo-arch.com 8 of 10 t 719.387.7836

EDGE CONDITION - ROCK ADJACENT TO MULCH 1 1/2" = 1'-0"

- MULCH

- DECORATIVE ROCK

- STEEL EDGER (FLUSH W/ MULCH)

- CONCRETE CURB PER CIVIL DRAWINGS

- COMPACTED SUBGRADE


- IMPORTED TOPSOIL

AMENITY ZONE PAVER LAYOUT

A - 8" x 8" Double Holland 98 Shady Red B-1 - 4" x 8" Holland Stone 98 Porcelain Gray B-2 - 4" x 8" Holland Stone 98 Tawny Pink

C - 4' x 8" Holland Stone II 98 French Gray

/ 1 1/2" = 1'-0"

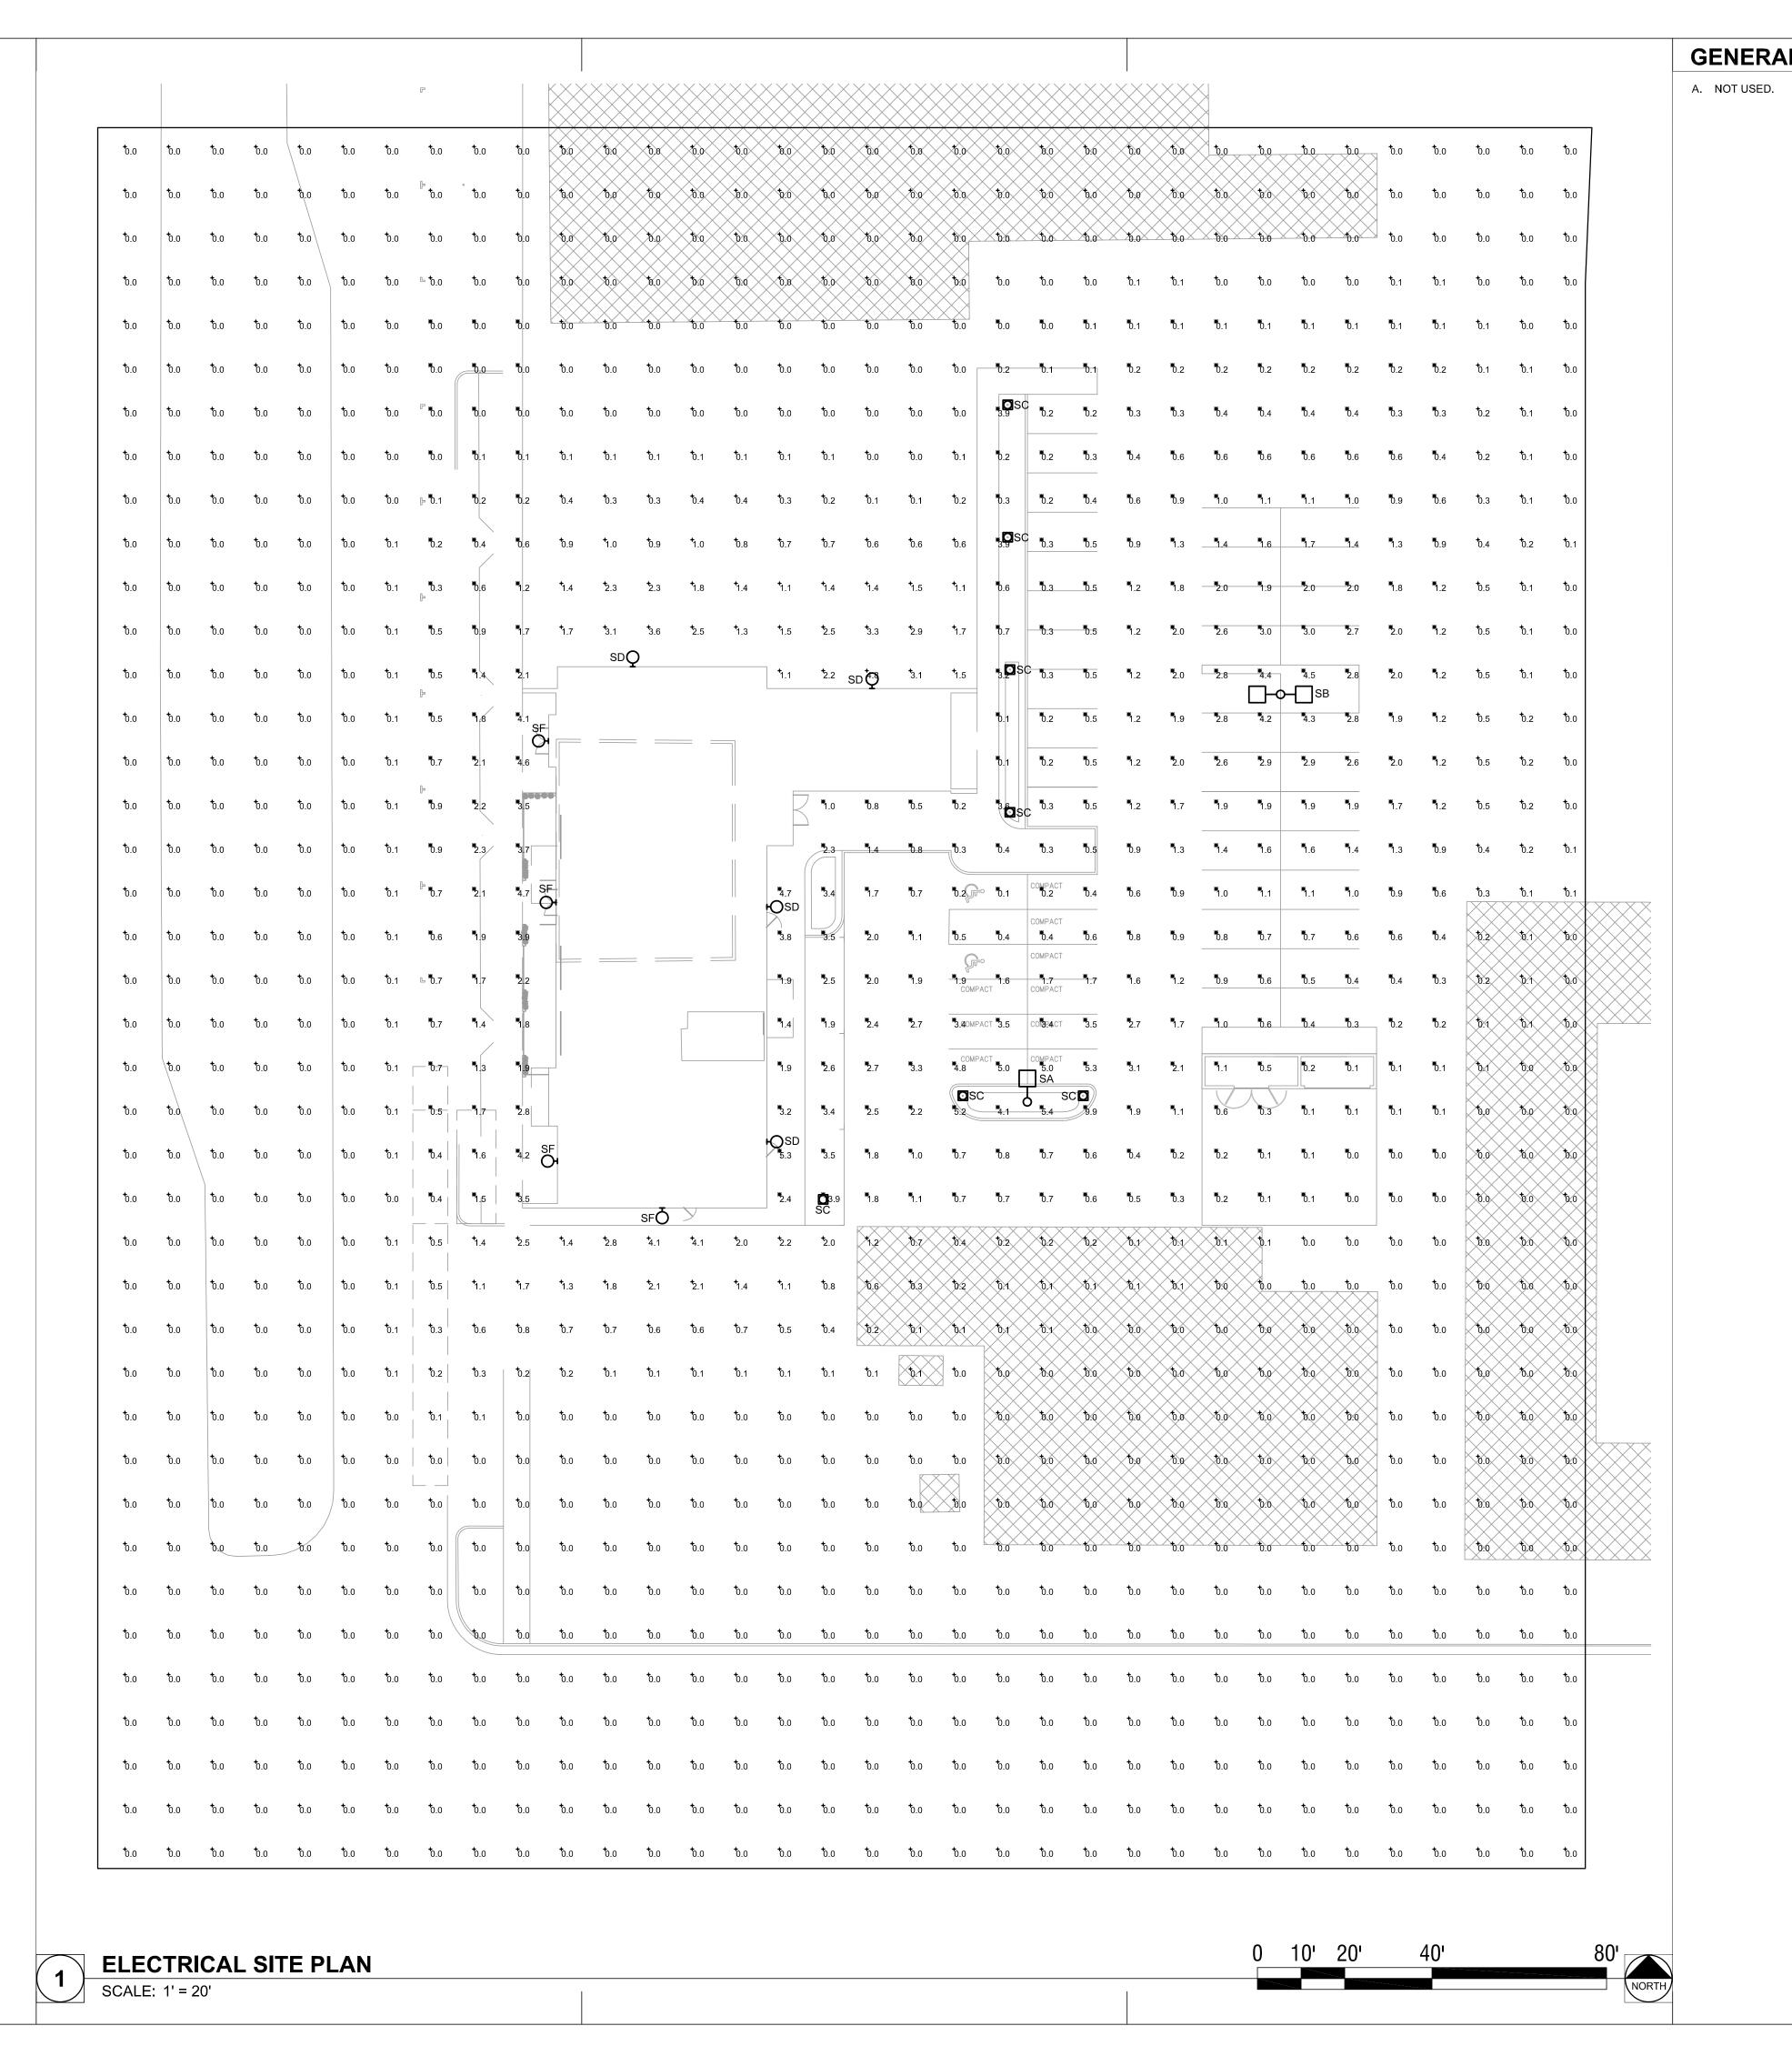

GENERAL NOTES



4755 FORGE ROAD, SUITE 150 COLORADO SPRINGS, COLORADO 80907 (719) 590-9194 / info@f-w.com

www.f-w.com Engineers | Architects | Surveyors | Scientists

80903

SITE PHOTOMETRIC PLAN LUR FILE #: AR DP 18-00302




415 S NEVADA AVE date: COLORADO SPRINGS

DEV PLAN sheet #

09.13.2018

ECHO ARCHITECTURE 4 south wahsatch ave #120 colorado springs, co 80903 www.echo-arch.com 9 of 10



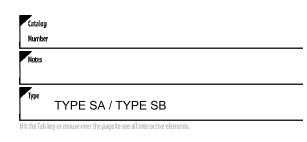

S4 Capable Luminaire

This item is an A+ capable luminaire, which has been designed and tested to provide consistent color appearance and system-level interoperability.

- All configurations of this luminaire meet the Acuity Brands' specification for chromatic consistency This luminaire is A+ Certified when ordered with DTL® controls marked by a shaded background.
- specification for luminaire to photocontrol interoperability1 • This luminaire is part of an A+ Certified solution for ROAM® or XPoint™ Wireless control networks, providing out-of-the-box control compatibility

with simple commissioning, when ordered with

drivers and control options marked by a shaded

DTL DLL equipped luminaires meet the A+

background¹ To learn more about A+,

visit www.acuitybrands.com/aplus.

1 See ordering tree for details

i. See ordering tree for details.
2. A+ Certified Solutions for ROAM require the order
of one ROAM node per luminaire. Sold
Separately: Link to Roam; Link to DTL DLL

	able options incoording to the contract of the	ıd.	tion									m; Link to DTL DLL 3M MVOLT SPA DDBX[
DSX1LED Series	LEDs	IIIIa	cion	Color ten	iperature	Distrib	eution	-	AAIVIFE: !	Voltage	Mounting	SIVI IVIVOLI SPA DDBAL
DSX1 LED	P2 I P3 I Rotated (P10 ¹ I	P4 P5 P6	P7 P8 P9	30K 40K 50K AMBPC	3000 K 4000 K 5000 K Amber phosphor converted ²	T15 T25 T2M T35 T3M T4M TFTM	Type I short Type II short Type II medium Type III shor: Type III medium Type IV medium Forward throw medium Type V very short	TSS TSM TSW BLC LCCO	Type V short Type V medlum Type V wide Backlight control ^{2,3} Left corner cutoff ^{2,3} Right corner	MYOLT 4.5 120 ⁶ 208 ^{5.6} 240 ^{5.6} 277 ⁶ 347 ^{5.6.7} 480 ^{5.6.7}	Shipped inclu SPA RPA WBA SPUMBA RPUMBA Shipped sepa KMAB DDBXD U	Square pole mounting Round pole mounting Wall bracket Square pole universal mounting adaptor ⁸ Round pole universal mounting adaptor ⁸

Control options			Other	options	Finish (req	uired)
Shipped installed NLTAIR2 n Light AIR generation 2 enabled ™ PER NEMA twist-lock receptacle only (controls ordered separate) ™ PER5 Five-wire receptacle only (controls ordered separate) ™ PER7 Seven-wire receptacle only (controls ordered separate) ™ DMG 0-10V dimming extend out back of horsing for external control (leads exit fixture) DS Dual switching ™ PIR Bi-level, motion/ambient sensor, 8-15' mounting height, ambient sensor enabled at 5fc ^{5,15,16} PIRH Bi-level, motion/ambient sensor, 15-30' mounting height, ambient sensor enabled at 5fc ^{5,15,16} PIRHO Network, Bi-Level motion/ambient sensor, 8-15' mounting height, ambient sensor enabled at 1fc ^{5,15,16} PIRFC3V Bi-level, motion/ambient sensor, 8-15' mounting height, ambient sensor enabled at 1fc ^{5,15,16}	BL30 BL50 PNMTDD3 PNMT5D3 PNMT6D3 PNMT7D3 FAO	BI-level, motion/amblent sensor, 15-30' mounting height, ambient sensor enabled at 1fc. 51.51's BI-level switched dimming, 30% 5.14.18 BI-level switched dimming, 50% 5.14.18 Part night, dim till dawn 5.19 Part night, dim 5 hrs 5.76 Part night, dim 6 hrs 5.75 Part night, dim 7 hrs 5.76 Field adjustable output ⁸⁰	HS SF DF L90 R90	ped installed House-side shield ²¹ Single fuse (120, 277, 3477) ⁶ Double fuse (208, 240, 480V) ⁶ Left rotated optics ¹ Right rotated optics ¹ ped separately Bird spikes ²² External glare shield ²²	DDBXD DBLXD DNAXD DWHXD DDBTXD DBLBXD DNATXD DWHGXD	Dark bronze Black Natural aluminum White Textured dark bron Textured black Textured natural aluminum Textured white



One Lithonia Way • Conyers, Georgia 30012 • Phone: 800.279.8041 • www.lithonia.com © 2011-2018 Acuity Brands Lighting, Inc. All rights reserved.

D\$X1-LED Rev. 07/25/18

Page 1 of 7




Specifications

6-3/8" (16.2 cm)

Luminaire


D-Series Size 1 LED Wall Luminaire



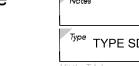

Back Box (BBW, ELCW) (34.9 cm) Weight:



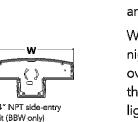

Type TYPE SD / TYPE SF

Introduction

The D-Series Wall luminaire is a stylish, fully integrated LED solution for building-mount applications. It features a sleek, modern design and is carefully engineered to provide long-lasting,

energy-efficient lighting with a variety of optical and control options for customized performance. With an expected service life of over 20 years of nighttime use and up to 74% in energy savings over comparable 250W metal halide luminaires, the D-Series Wall is a reliable, low-maintenance

For 3/4" NPT side-entry lighting solution that produces sites that are exceptionally illuminated. Ordering Information **EXAMPLE:** DSXW1 LED 20C 1000 40K T3M MVOLT DDBTXD

DSXW1 LED									
Series	LEDs	Drive Current	Color temp			Voltage	Mounting	Control Optio	
DSXW1 LED	10C 10 LEDs (one engine) 20C 20 LEDs (two engines)	350 350 mA 530 530 mA 700 700 mA 1000 1000 mA	40K 4 50K 5 (1 A) 1 AMBPC 4	0000 K 1000 K 5000 K Amber ohosphor converted	T2S Type II Short T2M Type II Medium T3S Type II Short T3M Type II Medium T4M Type IV Medium TFTM Forward Throw Medium ASYDF Asymmetric diffuse	MVOLT ² 120 ³ 208 ³ 240 ³ 277 ³ 347 ^{3,4} 480 ^{3,4}	Shipped included (blank) Surface mounting bracket BBW Surface- mounted back box (for conduit entry) 5	PIR 1 PIRH 1 PIRTFC3V # PIRH1FC3V # ELCW E	alled Photoelectric cell, button type ⁵ Photoelectric cell, but
Other Options				Finish ((required)				
Shipped Installed Shipped separately 10 SF Single fuse (120, 277 or 347V) 3.9 BSW Bird-deterrent spikes DF Double fuse (208, 240 or 480V) 3.3 WG Wire guard			DDBXD DBLXD DNAXD	Black	DSSXD DDBTXD DBLBXD	Sandstone Textured dark bronze Textured black	DWH DSST		

pped installed	Shipp	ed separately ¹⁰	DDBXD	Dark bronze	DSSXD	Sandstone	DWHGXD	Textured w
Single fuse (120, 277 or 347V) ^{3,9}	BSW	Bird-deterrent spikes	DBLXD	Black	DDBTXD	Textured dark bronze	DSSTXD	Textured sa
Double fuse (208, 240 or 480V) 35	WG	Wire guard	DNAXD	Natural aluminum	DBLBXD	Textured black		
House-side shield 10	VG	Vandal quard	DWHXD	White	DNATXD	Textured natural aluminum		

Accessories

DSXW1WG U Wire guard accessory

D5XW1YG U Vandal guard accessory

SPD Separate surge protection

1 20C 1000 is not available with PIR, PIRH, PIR1FC3V or PIRH1FC3V.

DDL Diffused drop lens

- MVOLT driver operates on any line voltage from 120-277V (50/60 Hz).


 Single fuse (SF) requires 120, 277 or 347 voltage option. Double fuse (DF) requires 208, 240 or 480 voltage option. Only available with 20C, 700mA or 1000mA. Not available with PIR or PIRH. DSXWBSW U Bird-deterrent spikes
 - 5 Back box ships installed on fixture. Cannot be field installed. Cannot be ordered as an accessory.
 6 Photocontrol (PE) requires 120, 208, 240, 277 or 347 voltage option. Not available with motion/ambient light sensors (PIR or PIRH).
 - Reference Motion Sensor table on page 3. Cold: weather (-20°C) rated. Not compatible with conduit entry applications. Not available with BBW mounting option. Not available with fusing. Not available with 347 or 480 voltage options. Emergency components located in back box housing. Emergency mode IES files located on product page at www.lithonia.com
 - 9 Not available with ELCW. 10 Also available as a separate accessory; see Accessories information.

LITHONIA LIGHTING.

One Lithonia Way • Conyers, Georgia 30012 • Phone: 800.279.8041 • www.lithonia.com © 2013-2018 Aculty Brands Lighting, Inc. All rights reserved.

PARK 12V/120V/277V LED BOLLARD

6641/6642/6643

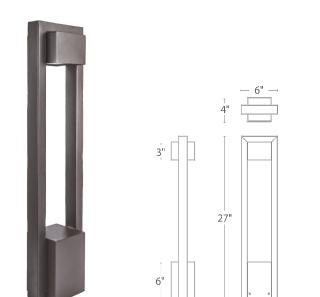

WAC LANDSCAPE LIGHTING

Fixture Type: Catalog Number:

9-15VAC (Transformer is required)

Location:

SPECIFICATIONS

Power: 5.5W / 6.0VA Brightness: Up to 150 lm CRI: 90 Rated Life: 60,000 hours **Dimming:** MLV dimming only

Input: 120V Power: 12.5W Brightness: Up to 390 lm

Rated Life: 60,000 hours **Dimming:** TRIAC or ELV dimming

 Input:
 277V

 Power:
 10.5W

 Brightness:
 Up to 430 lm

CRI: 90 Rated Life: 60,000 hours **Dimming:** ELV dimming only

Mounting accessory included M6000-STAKE

6643

RODUCT DESCRIPTION	
leek linear design blends seamlessly into pathways while providing soft, ven illumination	

- IP66 rated, Protected against powerful water jets Factory sealed water tight fixtures
- Mounting accessories included
- UL & cUL 1838 Listed (12V); 1598 Listed (120V/277V)

Model		Colo	ог Тетр	Finis	hes
6641	12V	27 30	2700K Warm White 3000K Pure White	BZ BK	Bronze on Aluminum Black on Aluminum
6642	120V	27 30	2700K Warm White 3000K Pure White	BZ BK	Bronze on Aluminum Black on Aluminum
6643	277V	27 30	2700K Warm White 3000K Pure White	BZ BK	Bronze on Aluminum Black on Aluminum

6643-___BZ Example: 6643-30BZ

waclighting.com Headquarters/Eastern Distribution Center Phone (800) 526,2588 44 Harbor Park Drive Port Washington, NY 11050 Fax (800) 526.2585

Central Distribution Center 1600 Distribution Ct Lithia Springs, GA 30122

Western Distribution Center 1750 Archibald Avenue

Ontario, CA 91760

M6640-CON-KIT

WAC Lighting retains the right to modify the design of our products at any time as part of the company's continuous improvement program.

LUMINAIRE SCHEDULE Mark Symbol Qty Distribution Type Lamp Lumens Watts Description LED LOW PROFILE DESIGN POLE MOUNTED LUMINAIRE, MOUNTED ON 15.0 FT \leftarrow LITHONIA - DSX1 LED P4 30K T3M MVOLT Type 3 Medium 13,064 Lumens SQUARE STRAIGHT STEEL POLE, BLACK COLOR LED LOW PROFILE DESIGN POLE MOUNTED LUMINAIRE, MOUNTED ON 20.0 FT \leftarrow Type 3 Medium LITHONIA - DSX1 LED P3 30K T3M MVOLT 11,338 Lumens SQUARE STRAIGHT STEEL POLE, BLACK COLOR LANDSCAPE BOLLARD LUMINAIRE, BRONZE ON ALUMINUM WAC - 6642-30BZ 477 Lumens EXTERIOR WALL MOUNTED LUMINAIRE, MOUNTED AT 10.0 FT AFF, BLACK COLOR Ю LITHONIA - DSXW1 LED 20C 700 30K TFTM MVOLT 5,172 Lumens Medium EXTERIOR WALL MOUNTED LUMINAIRE, MOUNTED AT 10.0 FT AFF, BLACK COLOR Ю 5,078 Lumens LITHONIA - DSXW1 LED 20C 700 30K T3M MVOLT Type 3 Medium

Rev. 3/13/18



4755 FORGE ROAD, SUITE 150 COLORADO SPRINGS, COLORADO 80907 (719) 590-9194 / info@f-w.com

www.f-w.com Engineers | Architects | Surveyors | Scientists

80903 RING AD

ELECTRICAL SCHEDULES LUR FILE #: AR DP 18-00302



415 S NEVADA AVE date: COLORADO SPRINGS

ECHO ARCHITECTURE 4 south wahsatch ave #120 colorado springs, co 80903 www.echo-arch.com

sheet # 10 of 10 t 719.387.7836

DEV. PLAN