A REPLAT OF LOTS 13 THROUGH 16, BLOCK 264, ADD. NO. 1 TO THE TOWN OF COLORADO SPRINGS

CITY OF COLORADO SPRINGS, COUNTY OF EL PASO, STATE OF COLORADO

FBZ-CEN DEVELOPMENT PLAN

OCTOBER 2024

LEGAL DESCRIPTION:


LOTS 13 TO 16, BLOCK 264 ADDITION NO. 1 CITY OF COLORADO SPRINGS, COUNTY OF EL PASO, STATE OF COLORADO RECORDED IN PLAT BOOK A AT PAGE 7. TO BE REPLATTED AS LOTS 1 & 2, 524 S. CASCADE

ADA STATEMENT:

THE PARTIES RESPONSIBLE FOR THIS PLAN HAVE FAMILIARIZED THEMSELVES WITH ALL CURRENT ACCESSIBILITY CRITERIA AND SPECIFICATIONS AND THE PROPOSED PLAN REFLECTS ALL SITE ELEMENTS REQUIRED BY THE APPLICABLE ADA DESIGN STANDARDS AND GUIDELINES AS PUBLISHED BY THE UNITED STATES DEPARTMENT OF JUSTICE. APPROVAL OF THIS PLAN BY THE CITY OF COLORADO SPRINGS DOES NOT ASSURE COMPLIANCE WITH THE ADA OR ANY OTHER FEDERAL OR STATE ACCESSIBILITY LAWS OR ANY REGULATIONS OR GUIDELINES ENACTED OR PROMULGATED UNDER OR WITH RESPECT TO SUCH LAWS. SOLE RESPONSIBILITY FOR COMPLIANCE WITH FEDERAL AND STATE ACCESSIBILITY LAWS LIES WITH THE PROPERTY

GENERAL NOTES:

- 1. ALL PROPOSED CURB & GUTTER, SIDEWALK AND PEDESTRIAN RAMPS WITHIN THE RIGHT-OF-WAY SHALL MEET CURRENT CITY STANDARDS. ALL CURB, GUTTER, PEDESTRIAN RAMPS AND SIDEWALK POSING A SAFETY HAZARD, DAMAGED, EXHIBITING EXCESSIVE DETERIORATION OR DOES NOT MEET CURRENT CITY STANDARDS ALONG CASCADE AVENUE AND MORENO AVENUE ADJACENT TO THE SITE WILL NEED TO BE REMOVED AND REPLACED. AN ON-SITE MEETING CAN BE SET UP WITH THE ENGINEERING DEVELOPMENT REVIEW INSPECTOR TO DETERMINE WHAT, IF ANY IMPROVEMENTS ARE REQUIRED. THE INSPECTOR CAN BE REACHED AT 719-385-5977.
- 2. ALL ON-SITE UTILITIES ARE PRIVATE UNLESS OTHERWISE NOTED.
- 3. A MINIMUM OF 3-FOOT CLEARANCE AROUND THE CIRCUMFERENCE OF ALL FIRE HYDRANTS WILL BE KEPT CLEAR OF ANY PHYSICAL OR VISUAL OBSTRUCTIONS TO THE HYDRANT.
- 4. PER CITY CODE SECTION 7.4.102.D ALL LIGHTING FIXTURES SHALL BE CUT-OFF OR HAVE SHIELDING TO REDUCE OFF-SITE LIGHTING IMPACTS ONTO ADJACENT PROPERTIES AND ROADWAYS. ALL EXTERIOR LIGHTING SHALL BE ARRANGED TO MITIGATE LIGHT DIRECTED AWAY FROM ADJACENT PROPERTIES AND ANY PUBLIC RIGHT-OF-WAY. AN AMENDMENT TO THIS PLAN MAY BE REQUIRED IF THE LIGHTING TYPE IS CHANGED.
- 9. FIRE APPARATUS ACCESS ROADS SHALL BE DESIGNED AND MAINTAINED TO SUPPORT THE IMPOSED LOADS OF FIRE APPARATUS AND SHALL BE SURFACED SO AS TO PROVIDE ALL WEATHER DRIVING CAPABILITIES (2018 CSFC 503.2.3)
- 10. ALL "STOP SIGNS" AND PAVEMENT MARKINGS WILL BE INSTALLED BY THE DEVELOPER AT THE LOCATIONS SHOWN ON THE DEVELOPMENT PLAN TO MEET MUTCD STANDARDS. CONTACT TRAFFIC ENGINEERING, SIGNS & MARKINGS AT 719-385-6720 FOR ASSISTANCE. ALL PUBLIC ROADWAY SIGNING AND STRIPING IMPROVEMENTS TO BE ADDRESSED DURING THE CONSTRUCTION DRAWING PLAN REVIEW.
- 11. THERE SHALL BE NO DIRECT VEHICLE ACCESS TO WEST MORENO AVENUE AND SOUTH CASCADE AVENUE EXCEPT AS SHOWN ON THIS DEVELOPMENT PLAN FOR THIS SITE.
- 12. ON-SITE LANDSCAPE IMPROVEMENTS AND MAINTENANCE SHALL BE THE RESPONSIBILITY OF OWNER, AND/OR THEIR
- 13. STREET TREES, STREETSCAPE IMPROVEMENTS, AND VEGETATION WITHIN THE CITY ROW SHALL BE MAINTAINED BY THE
- 14. SIGNAGE IS NOT APPROVED WITH THIS PLAN; A SEPARATE SIGN PERMIT IS REQUIRED PRIOR TO CONSTRUCTION.
- 15. ALL PUBLIC AND PRIVATE PEDESTRIAN RAMPS TO BE CONSTRUCTED PER CITY STD. DETAIL D-8.
- 16. ALL IMPROVEMENTS WITHIN THE CASCADE AVENUE RIGHT-OF-WAY TO BE CONSTRUCTED BY THE DEVELOPER IN CONJUNCTION WITH SITE DEVELOPMENT, AND COMPLETED PRIOR TO CERTIFICATE OF OCCUPANCY (CO). IMPROVEMENTS ALONG MORENO AVENUE ARE PART OF A LARGER MORENO AVENUE STREETSCAPE DESIGN EFFORT (BY OTHERS). PRIOR TO BUILDING PERMIT ISSUANCE ON LOT 1 AND LOT 2, FULL PUBLIC STREET IMPROVEMENT SURETIES FOR THE DIRECT FRONTAGE WILL BE POSTED REFLECTING THE ANTICIPATED DESIGN EFFORT FOR THE CORRIDOR AT THAT TIME (NEW CURB & GUTTER, SIDEWALK, LIGHTING, ETC.). ALL PUBLIC IMPROVEMENT WORK ALONG LOT 1 AND LOT 2 FRONTAGE TO BE
- 17. ALL IMPROVEMENTS DEPICTED WITHIN THIS PLAN ARE REQUIRED BY CITY CODE AND/OR ARE A CONDITION OF APPROVAL TO ENSURE COMPLIANCE WITH THE CITY'S REVIEW CRITERIA. ANY PRIVATE IMPROVEMENTS PROVIDED AS EXTRA. WILL BE LABELED AS SUCH AND WILL NOT BE INCLUDED IN THE CALCULATED AMOUNT REQUIRED FOR A FINANCIAL ASSURANCE.
- 18. PLANNED INFILTRATION AREAS ARE NOT REQUIRED FOR THIS REDEVELOPMENT AS LESS THAN 1 ACRE IS BEING
- 19. INSTALLATION OF ELECTRICAL DEVICES IN THE PUBLIC ROW SHALL BE PERFORMED IN ACCORDANCE WITH THE CITY SPECIFICATION SECTION 1001 AND COMPLETE THE COLORADO SPRINGS UTILITIES "ELECTRIC INSPECTION IN THE RIGHT-OF-WAY CERTIFICATE" IN ACCORDANCE WITH UTILITIES' REQUIREMENTS FOR ELECTRIFICATION. THE CERTIFICATE SHALL ALSO BE PROVIDED TO THE CITY INSPECTOR."
- 20. PROPOSED ROOF TOP SCREENING WILL ALSO BE PROVIDED FOR TELECOM EQUIPMENT AND/OR SATELLITE DISH SCREENING. 21. THIS EXISTING PLATTED LOT IS NOT WITHIN THE HILLSIDE OR STREAMSIDE OVERLAY ZONE, THEREFORE A LAND
- SUITABILITY ANALYSIS IS NOT REQUIRED.
- 22. THE DETAILS OF THE SIGNING AND STRIPING OF THE FUTURE PUBLIC ROADWAY IMPROVEMENTS WILL BE ADDRESSED DURING THE CONSTRUCTION PLAN REVIEW.
- 23. TREES SHOWN TO BE REMOVED FROM THE CITY ROW REQUIRE A PERMIT FROM THE FORESTRY DIVISION AND THE WORK MUST BE COMPLETED BY A TREE SERVICE LICENSED BY THE CITY OF COLORADO SPRINGS. PAYMENT FOR THE APPRAISED VALUE OF THE TREES TO BE REMOVED SHALL BE RECEIVED IN FULL BEFORE THE ISSUANCE OF THE PERMIT.

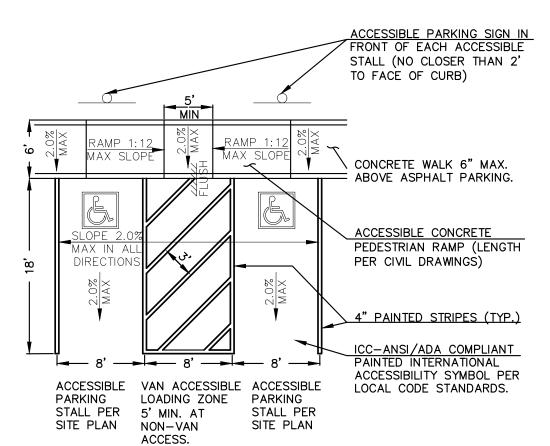


ADA PARKING DETAILS:

SCALE: 1'' = 10'


<u>HANDICAP PARKING SPACE DESIGN</u>

- 1. RAMPS SHALL NOT BE PLACED IN HANDICAPPED ACCESS AISLE, BUT SHALL BE PLACED WITHIN THE ADJOINING
- 2. ACCESS AISLES MAY NOT EXCEED A 2% SLOPE IN ANY
- 3. HANDICAPPED RAMPS MAY NOT EXCEED A SLOPE OF 8% 4. THE MINIMUM WIDTH FOR HANDICAPPED RAMPS IS 36
- 5. THE SIDES OF RAMPS MAY NOT EXCEED A SLOPE OF 10%
- UNLESS PROTECTED WITH A HANDRAIL 6. HANDICAPPED PARKING SHALL MEET ALL OTHER APPLICABLE CITY AN ADA CODE REQUIREMENTS
- 7. SIGNAGE IS REQUIRED FOR ACCESSIBLE SPACES AS SHOWN IN DETAIL, HOWEVER ONLY ONE SPACE NEEDS TO BE SIGNED AS VAN ACCESSIBLE.
- 8. ACCESSIBLE ROUTES, INCLUDING RAMPS AND SIDEWALKS WITHIN THE PUBLIC RIGHT-OF-WAY SHALL BE PER THE CITY'S STANDARD DRAWINGS AND SPECIFICATIONS. CITY'S ENGINEERING DEVELOPMENT REVIEW INSPECTOR WILL HAVE THE FINAL AUTHORITY ON ACCEPTING THE PUBLIC IMPROVEMENTS.

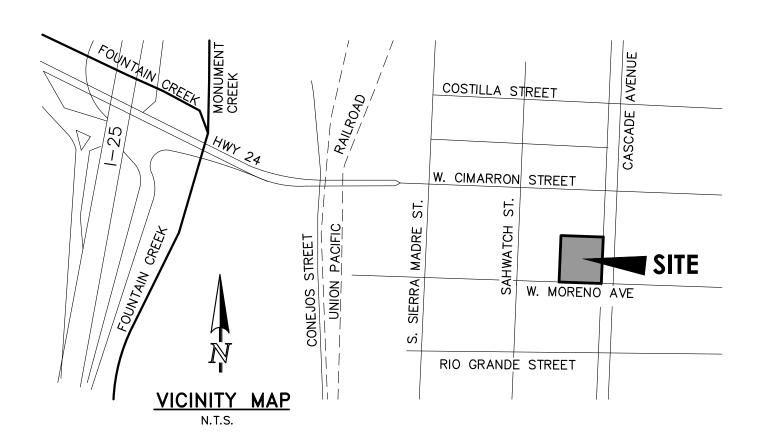

COVER SHEET SHEET 1 OF 18 EXISTING CONDITIONS/DEMOLITION PLAN SHEET 2 OF 18 SITE PLAN SHEET 3 OF 18 SHEET 4 OF 18 PRELIMINARY GRADING PLAN PRELIMINARY UTILITY & PUBLIC FACILITIES PLAN SHEET 5 OF 18 LANDSCAPE PRELIMINARY SITE PLAN SHEET 6 OF 18 LANDSCAPE PRELIMINARY AMENITY DECK SHEET 7 OF 18 PRELIMINARY LANDSCAPE PLAN SHEET 8 OF 18 PRELIMINARY HYDROZONE PLAN SHEET 9 OF 18 ARCHITECTURE OVERALL PLAN SHEET 10 OF 18 SHEETS 11-13 OF 18 **BUILDING ELEVATIONS** WALL DETAILS SHEET 14 OF 18 SITE PHOTOMETRIC PLAN SHEET 15 OF 18 SHEET 16 OF 18 SITE PHOTOMETRIC PLAN - PROPERTY LINE ROOF TOP PHOTOMETRIC PLAN SHEET 17 OF 18 SITE LUMINAIRE CUTSHEETS SHEET 18 OF 18

SHEET INDEX

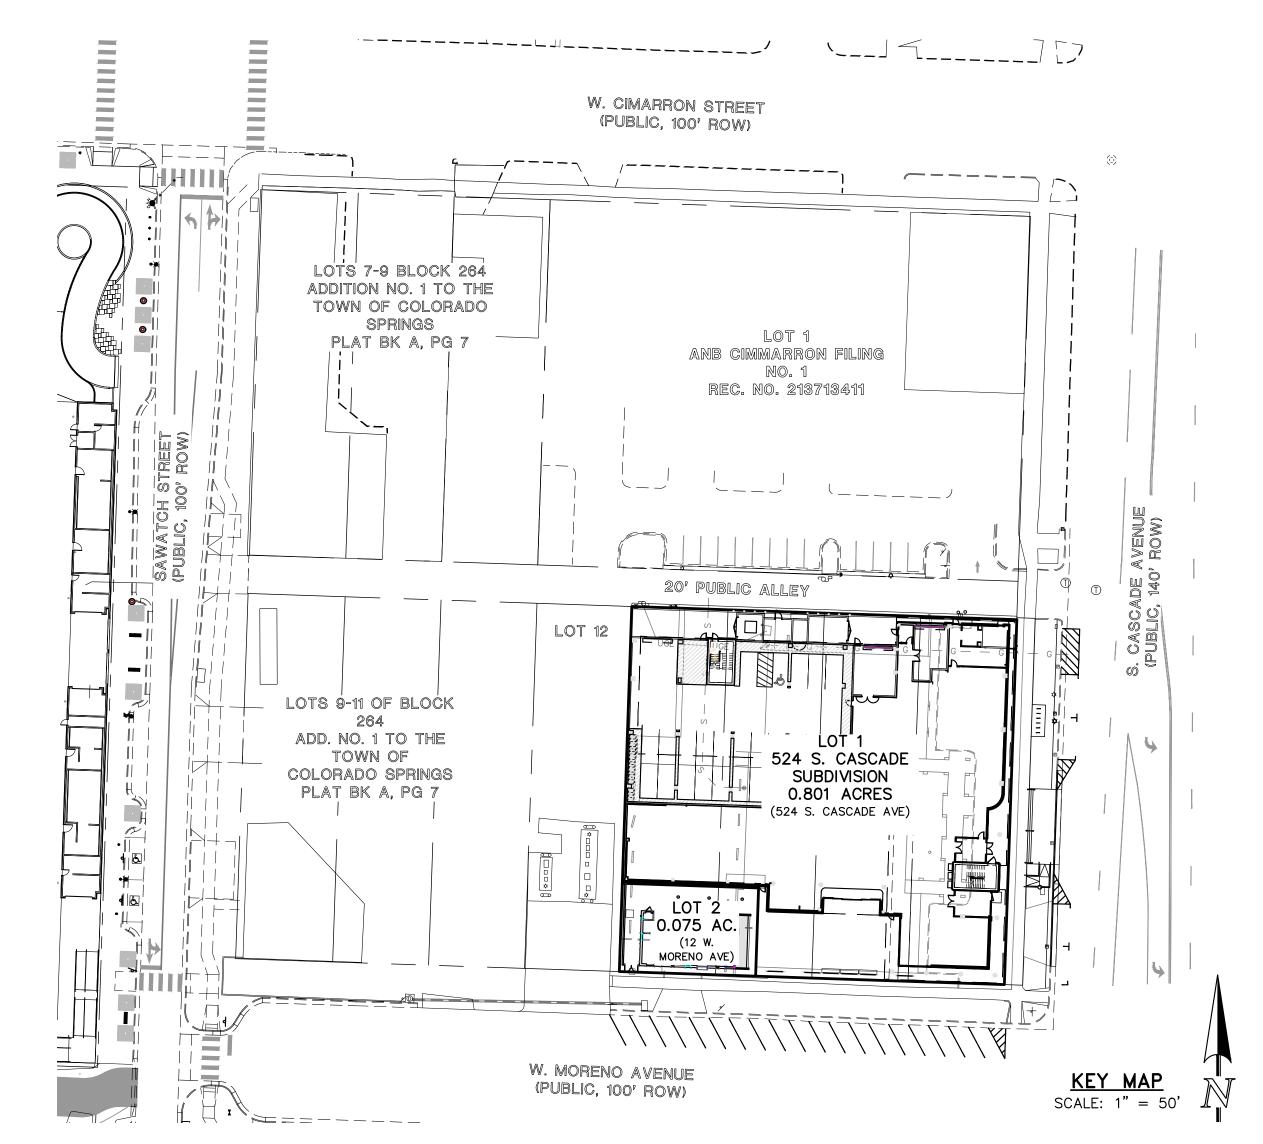

PROJECT TEAM:

OWNER / APPLICANT / DEVELOPER DAVID JENKINS C/O NORWOOD DEVELOPMENT GROUP 111 S TEJON ST SUITE 222

COLORADO SPRINGS, COLORADO 80903

MR. JEFF FINN (719) 593-2600

CIVIL ENGINEER CLASSIC CONSULTING ENGINEERS & SURVEYORS, LLC 619 N. CASCADE AVENUE, SUITE 200 COLORADO SPRINGS, COLORADO 80903 MR. KYLE CAMPBELL, P.E. (719) 785-0790

<u>ARCHITECT</u>

JNS ARCHITECTURE 1600 WYNKOOP STREET, SUITE 100 DENVER, COLORADO 80202 MS. HEATHER VASQUEZ JOHNSON (303) 892-7062

LANDSCAPE ARCHITECT

DIG STUDIOS 1521 15TH STREET DENVER, COLORADO 80202 MR. PAUL STEWART (720) 788-0656

SITE DATA:

TAX SCHEDULE NO .: 64183-20-019 SITE ADDRESS: LOT 1: 524 S. CASCADE AVENUE LOT 2: 12 W. MORENO AVENUE

LOT AREA: 0.876 ACRES (38,159 SF) MASTER PLAN: EXPERIENCE DOWNTOWN PLAN (2016) **EXISTING ZONING:** FBZ-CEN (ZONING ORDINANCE 09-83 & 12-13)

SECTOR: CENTRAL SECTOR FRONTAGE: SHOPFRONT

BUILDING TYPE: LOT 1: MIXED USE LOT 2: MIXED USE COMMERCIAL EXISTING LAND USE:

PROPOSED LAND USE: LOT 1: 180 GUEST ROOM HOTEL LOT 2: GUEST HOUSE FOR HOTEL

DEVELOPMENT SCHEDULE: COMMENCE FALL 2025 MAX. BUILDING HEIGHT ALLOWED: LOT 1: 7 STORIES PROPOSED BUILDING HEIGHT: LOT 2: 2 STORIES

TYPICAL DRIVE AISLE:

DRAINAGE BASIN: MONUMENT CREEK PROPOSED LOT COVERAGE:

34,897 SF / 0.809 AC 100.0% ASPHALT/CONCRETE/BUILDING COVERAGE: 34,897 SF / 0.799 AC 98.8% LANDSCAPE: 422 SF / 0.010 AC 1.2%

3,268 SF / 0.075 AC 100.0% ASPHALT/CONCRETE/BUILDING COVERAGE: 2,462 SF / 0.056 AC 75.3% 806 SF / 0.019 AC 24.7%

CASCADE AVENUE VARIES-1.1'-11.4' VARIES-0.7'-34.3' W MORENO AVENUE VARIES-0.9'-15.5' PUBLIC ALLEY (N) WEST PROPERTY LINE VARIES-0.4'-5.2' W. MORENO AVENUE

PARKING REQUIRED: NONE PER FBZ 2.6.2.1 25 TOTAL PARKING SPACES INTERIOR TO BUILDING PARKING PROVIDED: 6 STANDARD STALLS 9 TANDEM STALLS (18 TOTAL)

1.35'

1 ADA STALL (VAN) 9' X 18' TYPICAL PARKING SPACE:

TYPICAL HANDICAPPED PARKING SPACE: TYPICAL HANDICAPPED ZONE: 8' X 18' OR 5' X 18'

WEST PROPERTY LINE

NOT APPLICABLE IN FORM BASED ZONE 22 INTERIOR WALL MOUNTED BIKE RACKS 6 BIKE PARKING SPACES IN PUBLIC ROW

FLOODPLAIN STATEMENT:
ACCORDING TO THE NATIONAL FLOOD INSURANCE PROGRAM, FLOOD INSURANCE RATE MAP PANEL 08041C0729G WITH AN EFFECTIVE DATE OF DECEMBER 7, 2018, THE SUBJECT PROPERTY IS LOCATED IN ZONE X (AN AREA DETERMINED TO BE OUTSIDE THE 500-YEAR FLOODPLAIN).

CITY WIDE DEVELOPMENT IMPACT FEE:

LOT 1: HOTEL (TIER 1) LOT 2: HOTEL UNIT (TIER 1) EX. OFFICE BUILDING (TIER 3) EX. STORAGE BUILDING (TIER 4)

1.430 SF 13,272 SF

WARRANTS:

	FBZ SECTION	STANDARD	MODIFICATION	JUSTIFICATION
1	FBZ SECTION 2.3.3.3 BUILDING ENVELOPE: MEASURING SETBACKS	O' MINIMUM FRONT SETBACK	LOT 1 BUILDING SETBACK ALONG MORENO AVENUE IS 34.3' WITH A SCREEN WALL (SETBACK 2.7') ENCLOSING AN OUTDOOR PATIO	12' HEIGHT PATIO SCREEN WALL IS ANCHORED TO BUILDING FACADE AND SERVES AS AN EXTENSION OF THE MAIN HOTEL BUILDING, THEREFORE SATISFYING THE INTENDED ENVELOPE/SETBACK INTENDED
2	FBZ SECTION 2.4.7 GLAZING		LOT 2 CONTAINS GUEST HOUSE BUILDING WITH 28% GLAZING	GLAZING PERCENTAGE IS CONSISTENT WITH RESIDENTIAL DESIGN AND SECURES PRIVACY FOR GROUND FLOOR USE ASSOCIATED WITH THE GUEST HOUSE UNIT

ADDITIONAL NOTES: A REVOCABLE PERMIT WILL BE REQUIRED TO ALLOW FOR THE PRIVATE HANDRAIL AND RELATED INFRASTRUCTURE IN THE PUBLIC RIGHT OF WAY.



FBZ-CEN DEVELOPMENT PLAN

524 S. CASCADE SUBDIVISION

DATE 10/15/2024 DESIGNED BY | EAS | SCALE EAS | (H) 1"= 50' | SHEET 1 OF 18 |(V) 1" = N/A | JOB NO.

OR CITY USE:


FBZN-24-0013


NOTICE TO THE ARCHITECT/CONTRACTOR/ENGINEER:


THE DETAILS SHOWN ON THIS DEVELOPMENT PLAN ARE FOR PLANNING PURPOSES ONLY. DO NOT USE THIS PLAN SET FOR PRODUCT SPECS, ENGINEERING DETAILS, OR CONSTRUCTION PURPOSES. A PRE-CONSTRUCTION MEETING MUST BE SCHEDULED TO REVIEW ALL APPROVALS AND DESIGN CRITERIA PRIOR TO STARTING ANY SITE WORK.


619 N. Cascade Avenue, Suite 200

Colorado Springs, Colorado 80903

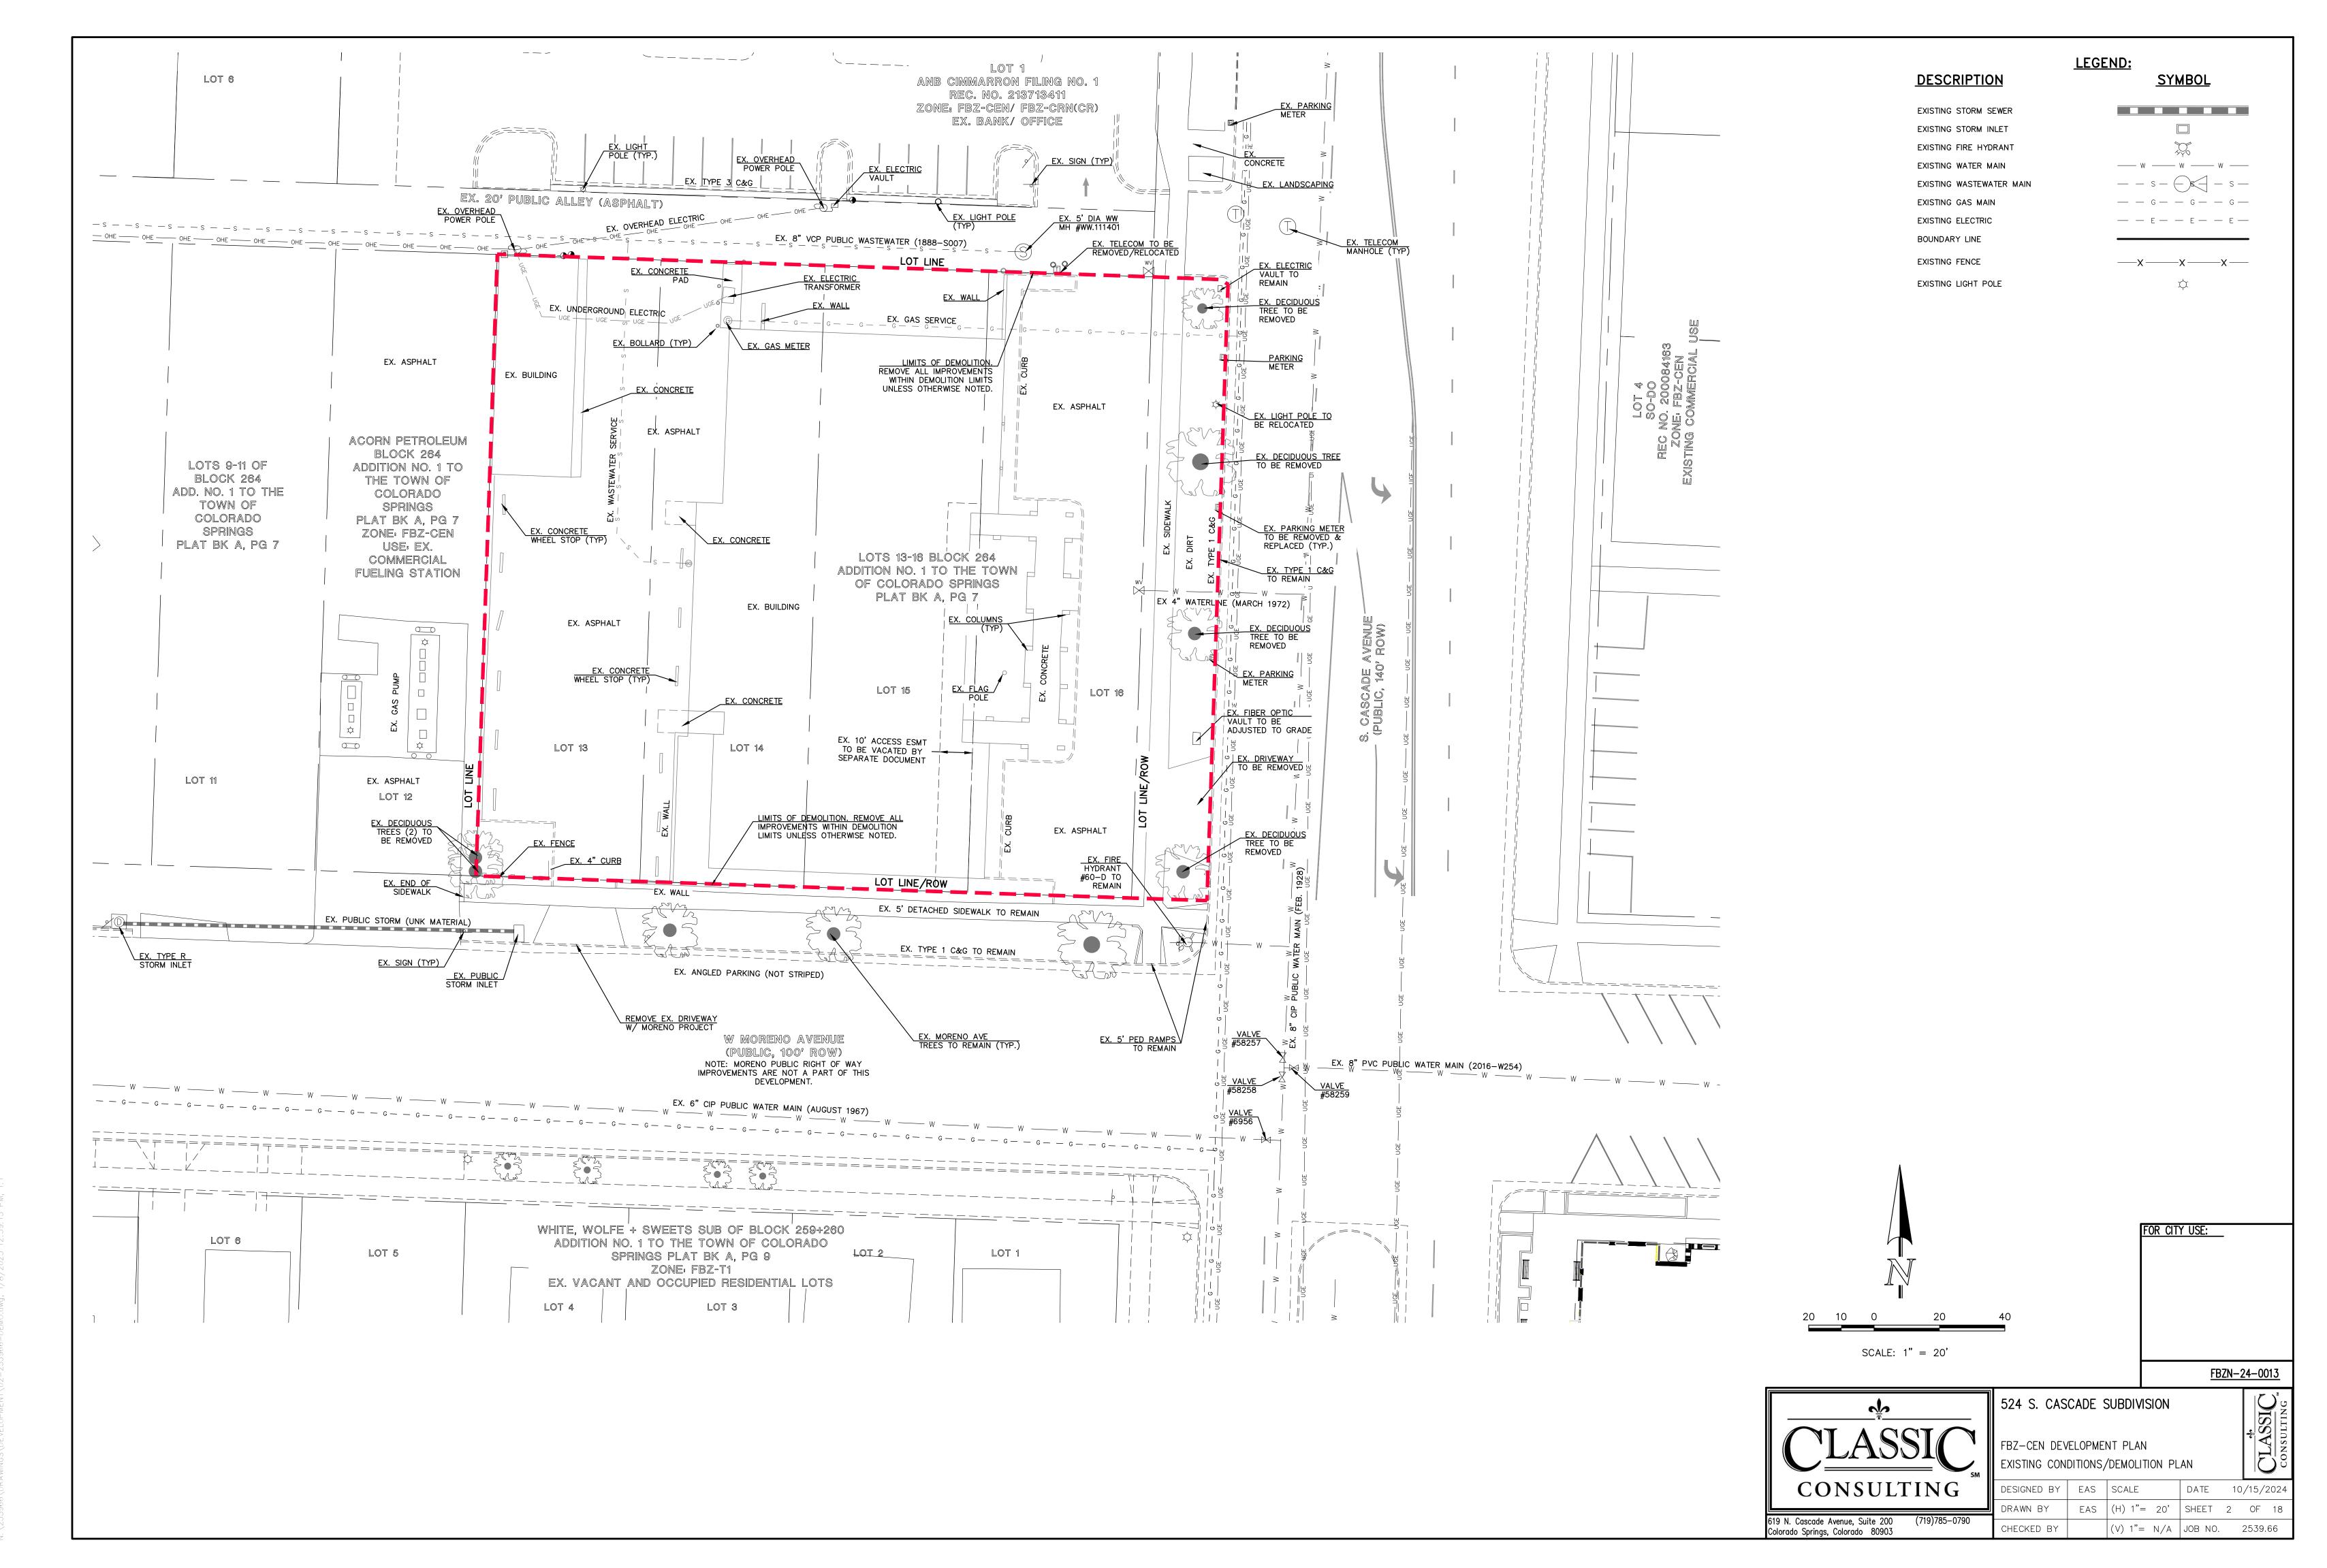

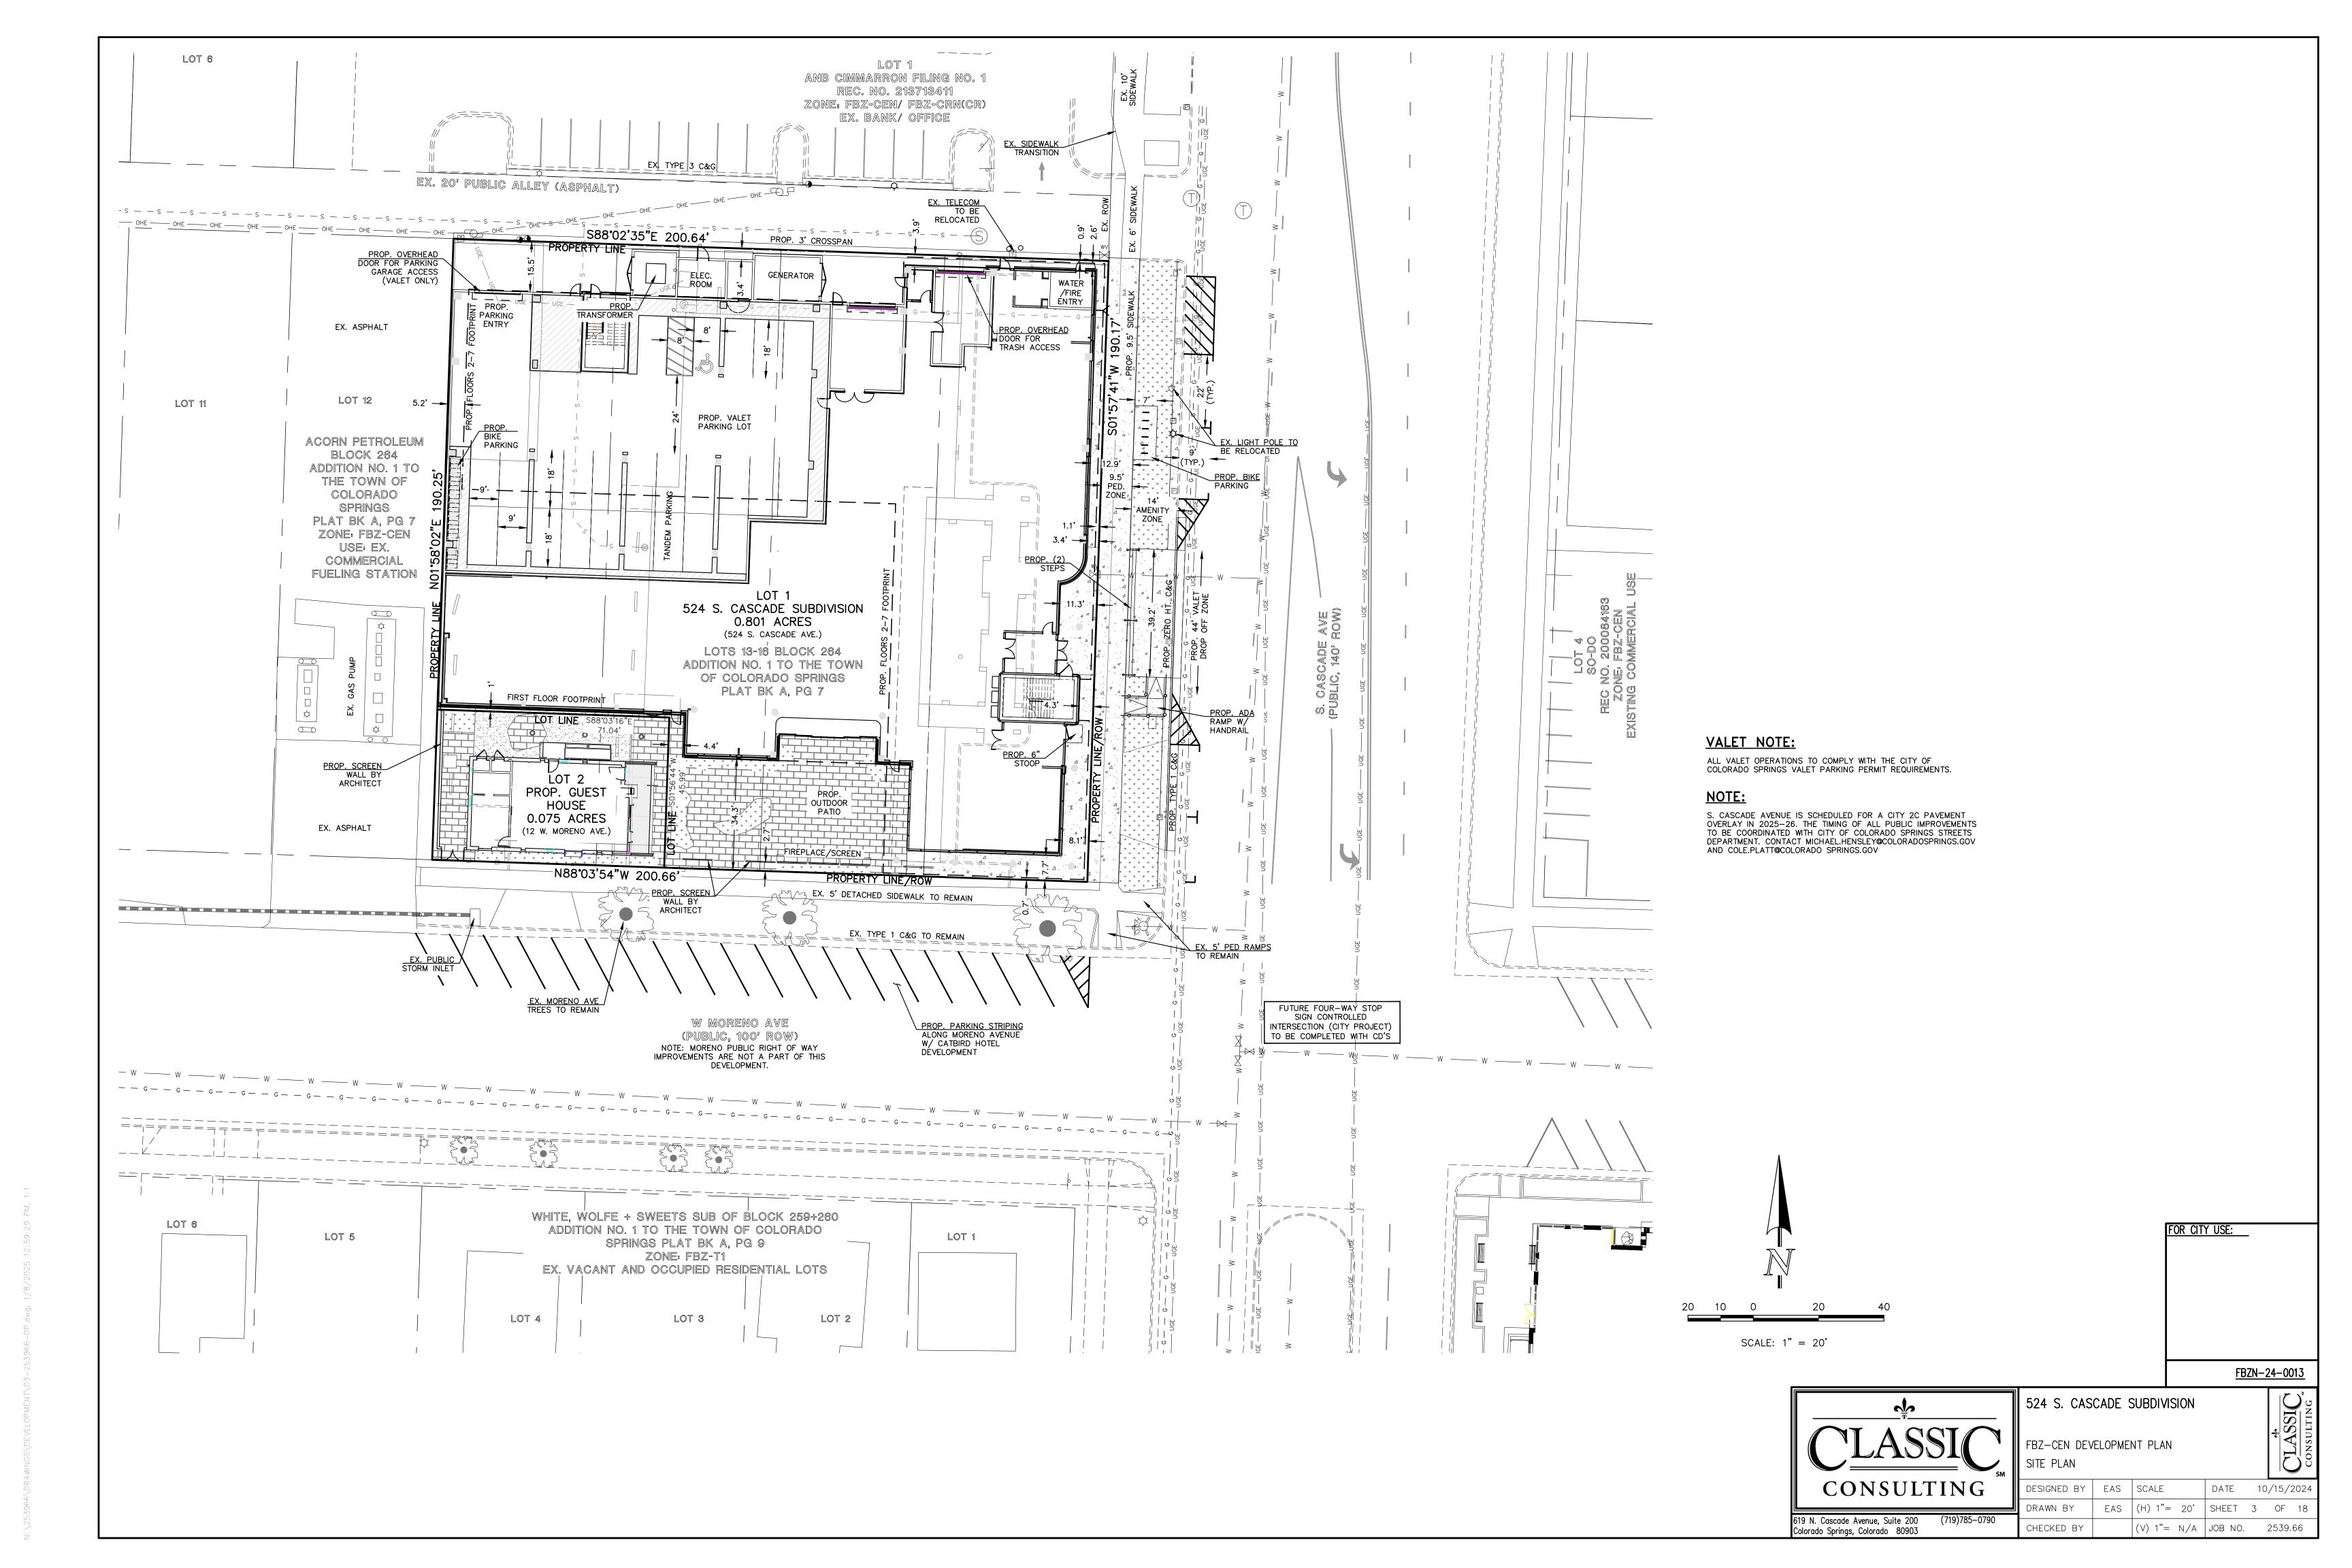

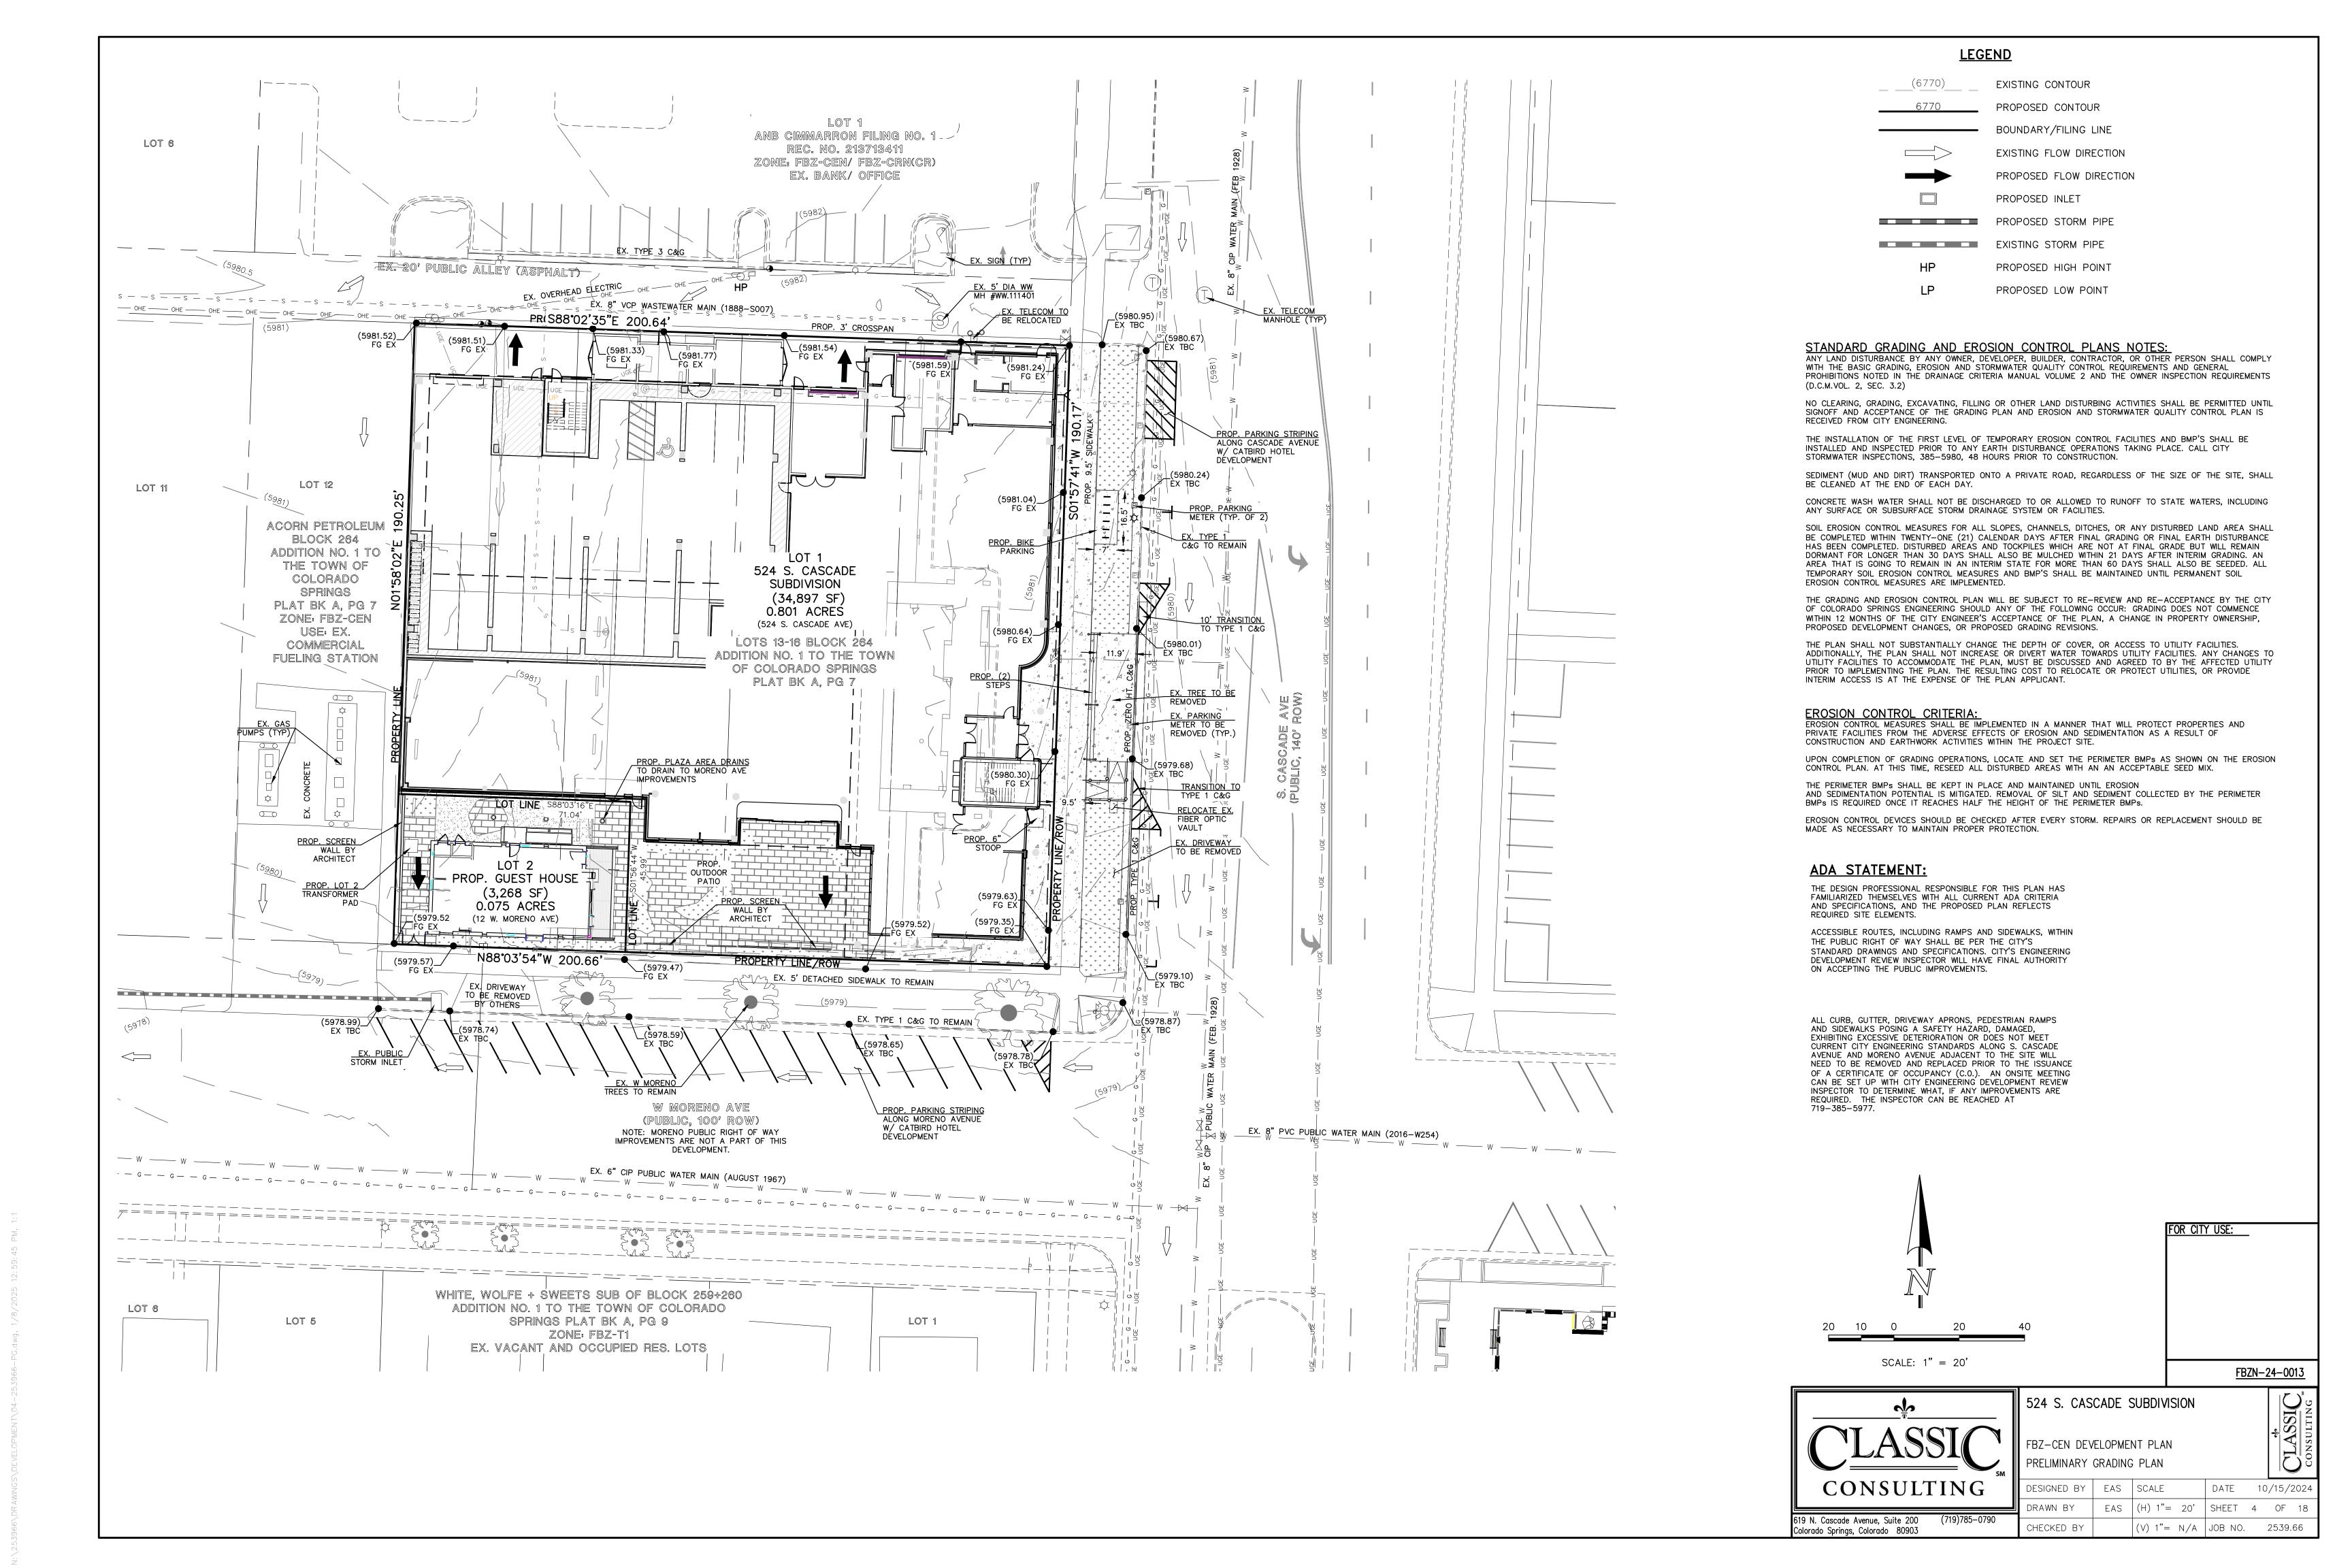

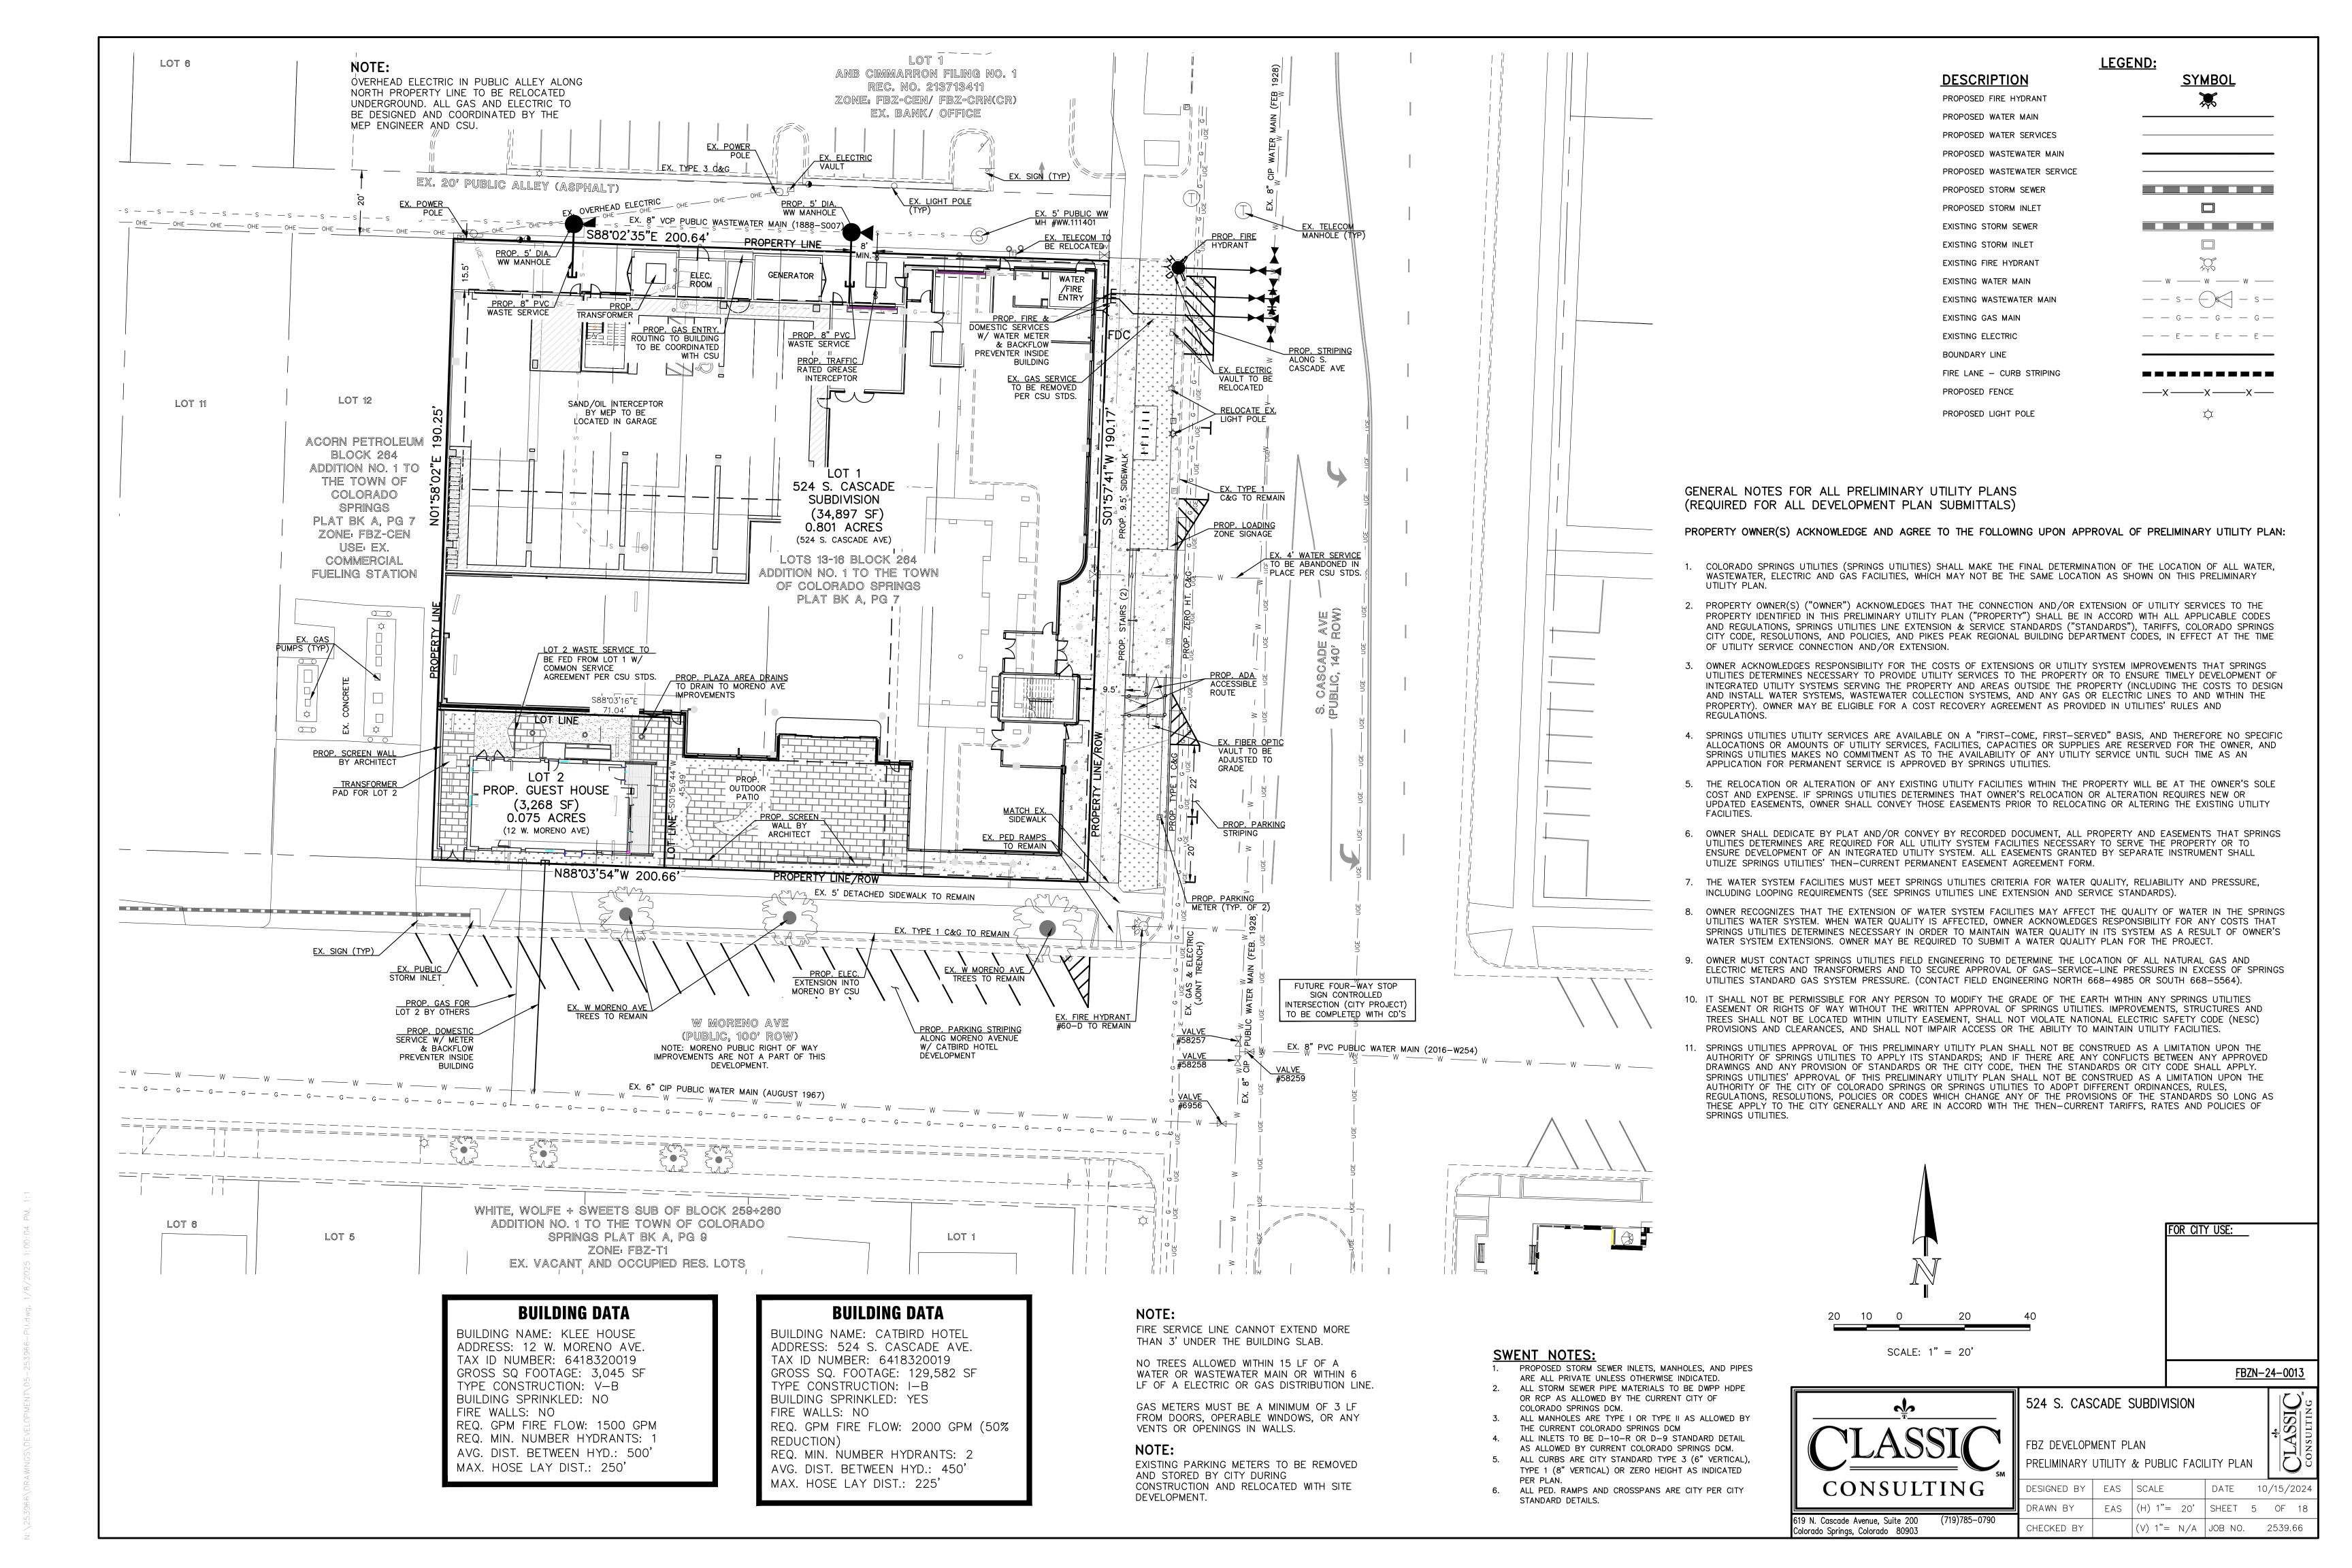

SITE SPECIFIC NOTES


THOSE RESPONSIBLE FOR THIS PLAN HAVE FAMILIARIZED THEMSELVES WITH ALL CURRENT ACCESSIBILITY CRITERIA AND SPECIFICATIONS AND THE PROPOSED PLAN REFLECTS ALL SITE ELEMENTS REQUIRED BY THE APPLICABLE AA DESIGN STANDARDS AND GUIDELINES AS PUBLISHED BY THE UNITED STATES DEPARTMENT OF JUSTICE. APPROVAL OF THIS PLAN BY THE CITY OF COLORADO SPRINGS DOES NOT ASSURE COMPLIANCE WITH THE ADA OR ANY OTHER FEDERAL OF STATE ACCESSIBILITY LAWS OR ANY REGULATIONS OR GUIDELINES ENACTED OR PROMULGATED UNDER OR WITH RESPECT TO SUCH LAWS. SOLE RESPONSIBILITY FOR COMPLIANCE WITH FEDERAL AND STATE ACCESSIBILITY LAWS LIES WITH THE PROPERTY OWNER.

REVOCABLE PERMITS REQUIRED FOR ALL SURFACE LEVEL(e.g. SIDEWALK STEPS) AND ELEVATED(e.g. AWNINGS) ENCROACHMENTS INTO THE PUBLIC RIGHT-OF-WAY, INCLUDING ART OR SCULPTURES.

ACCESSIBLE ROUTES, INCLUDING RAMPS AND SIDEWALKS, WITHIN THE PUBLIC RIGHT-OF-WAY SHALL BE PER THE CITY'S STANDARD DRAWINGS AND SPECIFICATIONS. CITY'S ENGINEERING DEVELOPMENT REVIEW INSPECTOR WILL HAVE THE FINAL AUTHORITY ON ACCEPTING THE PUBLIC IMPROVEMENTS.

INSTALLATION OF ELECTRICAL DEVICES IN THE PUBLIC ROW SHALL BE PREFORMED IN ACCORDANCE WITH THE CITY SPECIFICATION SECTION 1001 AND COMPLETE THE COLORADO SPRINGS UTILTIES "ELECTRIC INSPECTION IN THE RIGHT-OF-WAY CERTIFICATE" IN ACCORDANCE WITH UTILITIES' REQUIREMENTS FOR ELECTRIFICATION. THE CERTIFICATE SHALL ALSO BE PROVIDED TO CTHE CITY INSPECTOR.

ALL STREET TREES AND STREETSCAPE IMPROVEMENTS LOCATED IN THE ROW SHALL BE MAINTAINED BY THE ABUTTING PROPERTY OWNER.

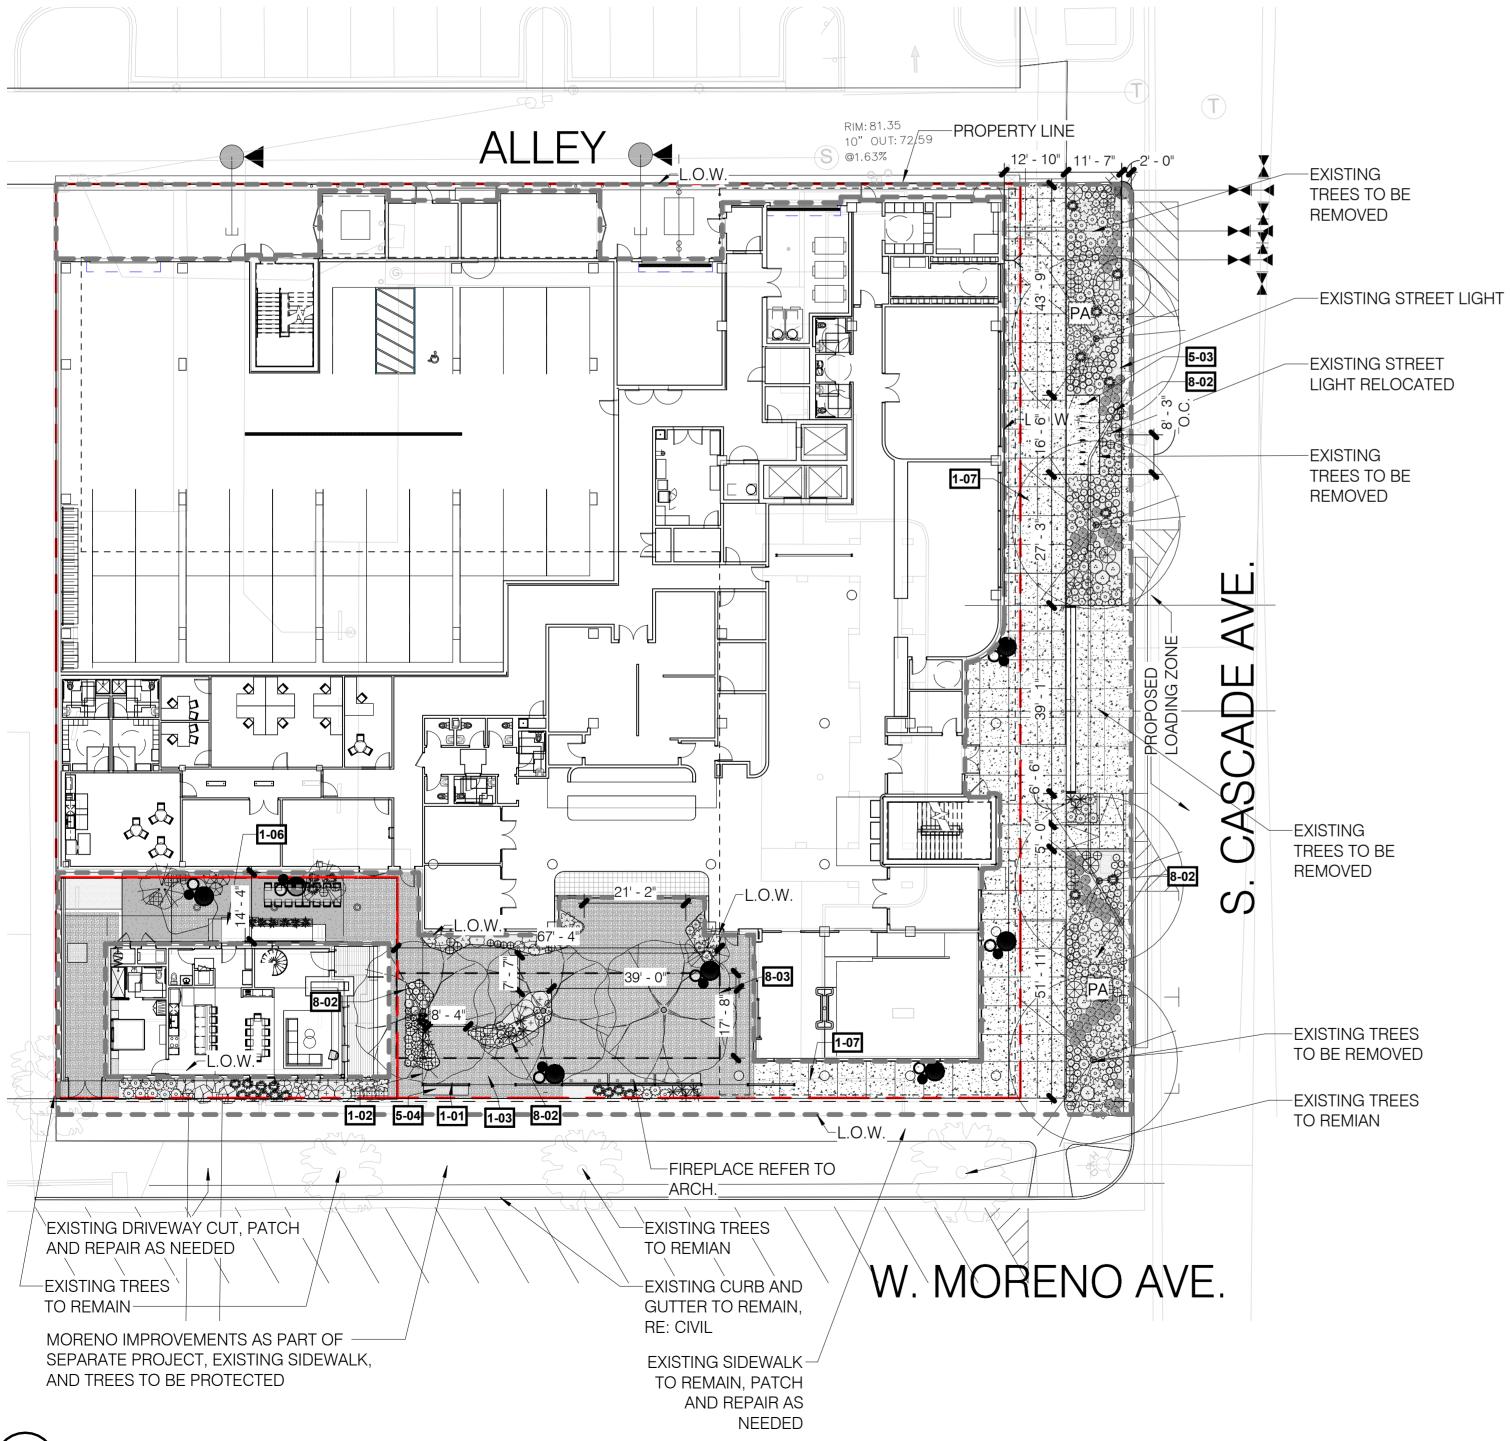

LEGAL DESCRIPTION & OWNER

THOSE RESPONSIBLE FOR THIS PLAN HAVE FAMILIARIZED THEMSELVES WITH ALL CURRENT ACCESSIBILITY CRITERIA AND SPECIFICATIONS AND THE PROPOSED PLAN REFLECTS ALL SITE ELEMENTS REQUIRED BY THE APPLICABLE AA DESIGN STANDARDS AND GUIDELINES AS PUBLISHED BY THE UNITED STATES DEPARTMENT OF JUSTICE. APPROVAL OF THIS PLAN BY THE CITY OF COLORADO SPRINGS DOES NOT ASSURE COMPLIANCE WITH THE ADA OR ANY OTHER FEDERAL OF STATE ACCESSIBILITY LAWS OR ANY REGULATIONS OR GUIDELINES ENACTED OR PROMULGATED UNDER OR WITH RESPECT TO SUCH LAWS. SOLE RESPONSIBILITY FOR COMPLIANCE WITH FEDERAL AND STATE ACCESSIBILITY LAWS LIES WITH THE PROPERTY OWNER.

REVOCABLE PERMITS REQUIRED FOR ALL SURFACE LEVEL(e.g. SIDEWALK STEPS) AND ELEVATED(e.g. AWNINGS) ENCROACHMENTS INTO THE PUBLIC RIGHT-OF-WAY, INCLUDING ART OR SCULPTURES.

ACCESSIBLE ROUTES, INCLUDING RAMPS AND SIDEWALKS, WITHIN THE PUBLIC RIGHT-OF-WAY SHALL BE PER THE CITY'S STANDARD DRAWINGS AND SPECIFICATIONS. CITY'S ENGINEERING DEVELOPMENT REVIEW INSPECTOR WILL HAVE THE FINAL AUTHORITY ON ACCEPTING THE PUBLIC IMPROVEMENTS.


INSTALLATION OF ELECTRICAL DEVICES IN THE PUBLIC ROW SHALL BE PREFORMED IN ACCORDANCE WITH THE CITY SPECIFICATION SECTION 1001 AND COMPLETE THE COLORADO SPRINGS UTILTIES "ELECTRIC INSPECTION IN THE RIGHT-OF-WAY CERTIFICATE" IN ACCORDANCE WITH UTILITIES' REQUIREMENTS FOR ELECTRIFICATION. THE CERTIFICATE SHALL ALSO BE PROVIDED TO CTHE CITY INSPECTOR.


ALL STREET TREES AND STREETSCAPE IMPROVEMENTS LOCATED IN THE ROW SHALL BE MAINTAINED BY THE ABUTTING PROPERTY OWNER.


MAINTENANCE STATEMENTS:

ALL LANDSCAPING SHOWN ON THIS PLAN SHALL BE MAINTAINED BY OWNER IN A NEAT AND ADEQUATE MANNER. REQUIRED MAINTENANCE ACTIVITIES SHALL INCLUDE. BUT NOT LIMITED TO. TRIMMING OG HEDGES. ADEQUATE IRRIGATION, REPLACEMENT OF DEAD, DISEASED OR UNSIGHTLY LANDSCAPING, REMOVAL OF WEEDS FROM PLANTED AREAS. AND APPROPRIATE PRUNING OF PLANT MATERIALS.

STREETSCAPE & COURTYARD MATERIALS SCHEDULE

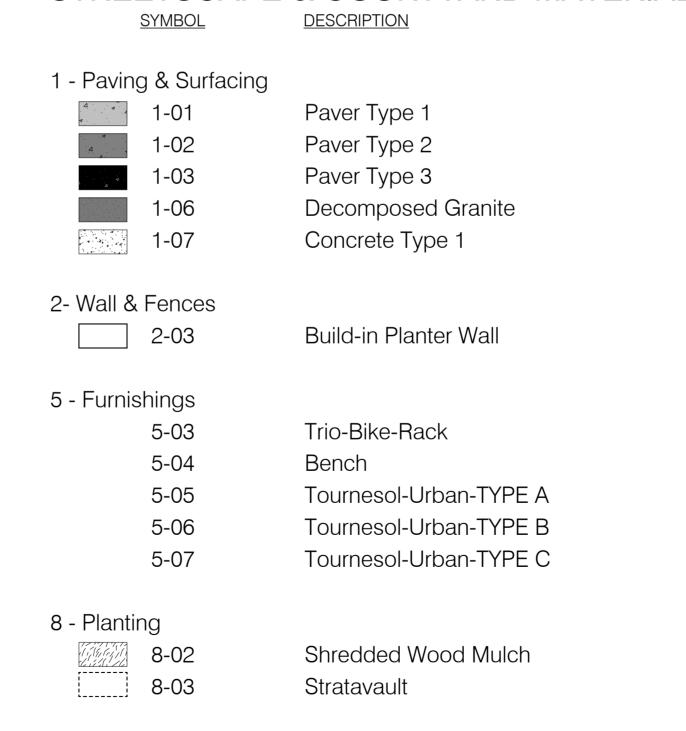

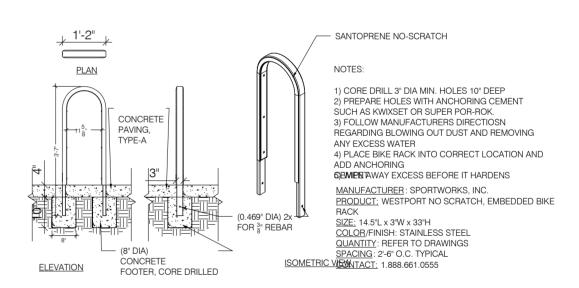

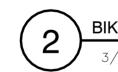

SHEET INDEX

Sheet Number	Sheet Name				
06	SITE PLAN				
07	ROOFTOP PLAN				
08	LANDSCAPE PLAN				
09	HYDROZONE PLAN				

FOR CITY USE: CITY FILE NUMBER


524 S. CASCADE AVENUE CONSULTING 1521 15th Street

Denver, Colorado 80202

FBZ-CEN DEVELOPMENT PLAN PRELIMINARY SITE PLAN


DESIGNED BY TM/RZ SCALE DATE TM/RZ | (H) 1"= 20' | SHEET 6 OF 18 CHECKED BY | TM/PS | (V) 1" = N/A | JOB NO. 2539.66

PRELIMINARY SITE PLAN

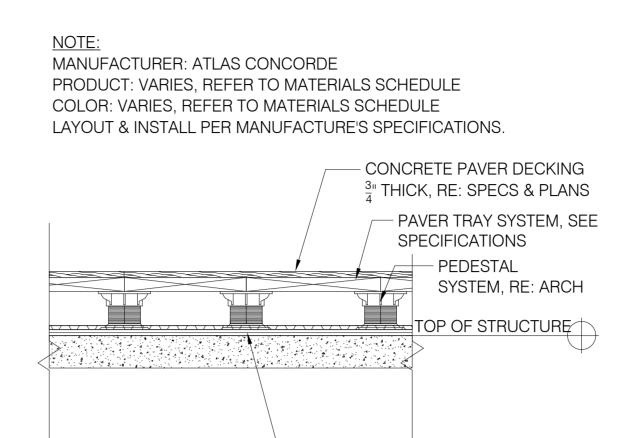

WATERPROOFING SYSTEM RE: ARCH

CONCRETE PAVER ON STRUCTURE

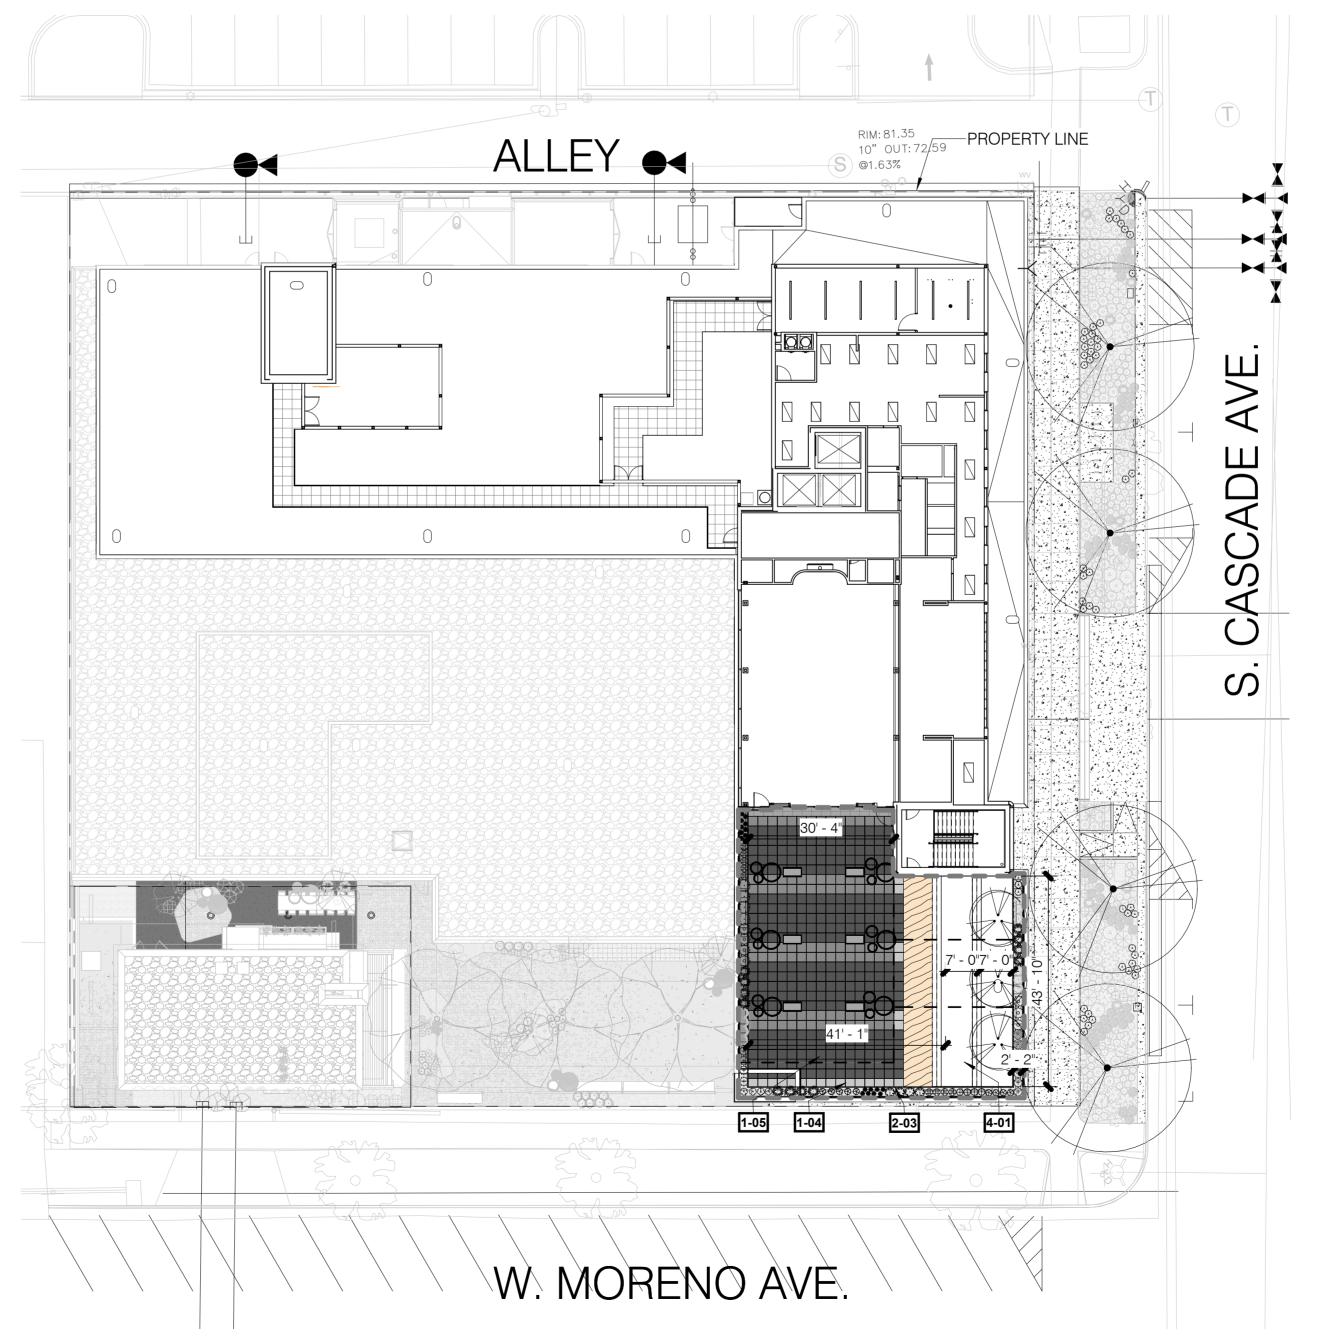

ROOFTOP MATERIALS SCHEDULE

SYMBOL DESCRIPTION

1 - Paving & Surfacing

Roof Top Paver Type 1 Roof Top Paver Type 2

2- Wall & Fences

Build-in Planter Wall

4 - Wood, Plastics and Composites

4-01 Roof Top Wood Deck

5 - Furnishings

5-05 Tournesol-Urban-TYPE A 5-06 Tournesol-Urban-TYPE B 5-07 Tournesol-Urban-TYPE C

8 - Planting

8-01 Planter Soil

FOR CITY USE:

CITY FILE NUMBER

CONSULTING

(720)328-1986


1521 15th Street Denver, Colorado 80202

524 S. CASCADE AVENUE

FBZ-CEN DEVELOPMENT PLAN PRELIMINARY AMENITY DECK

DESIGNED BY TM/RZ SCALE DRAWN BY TM/RZ (H) 1"= 20' SHEET 7 OF 18 CHECKED BY TM/PS (V) 1"= N/A JOB NO. 2539.66

PRELIMINARY AMENITY DECK

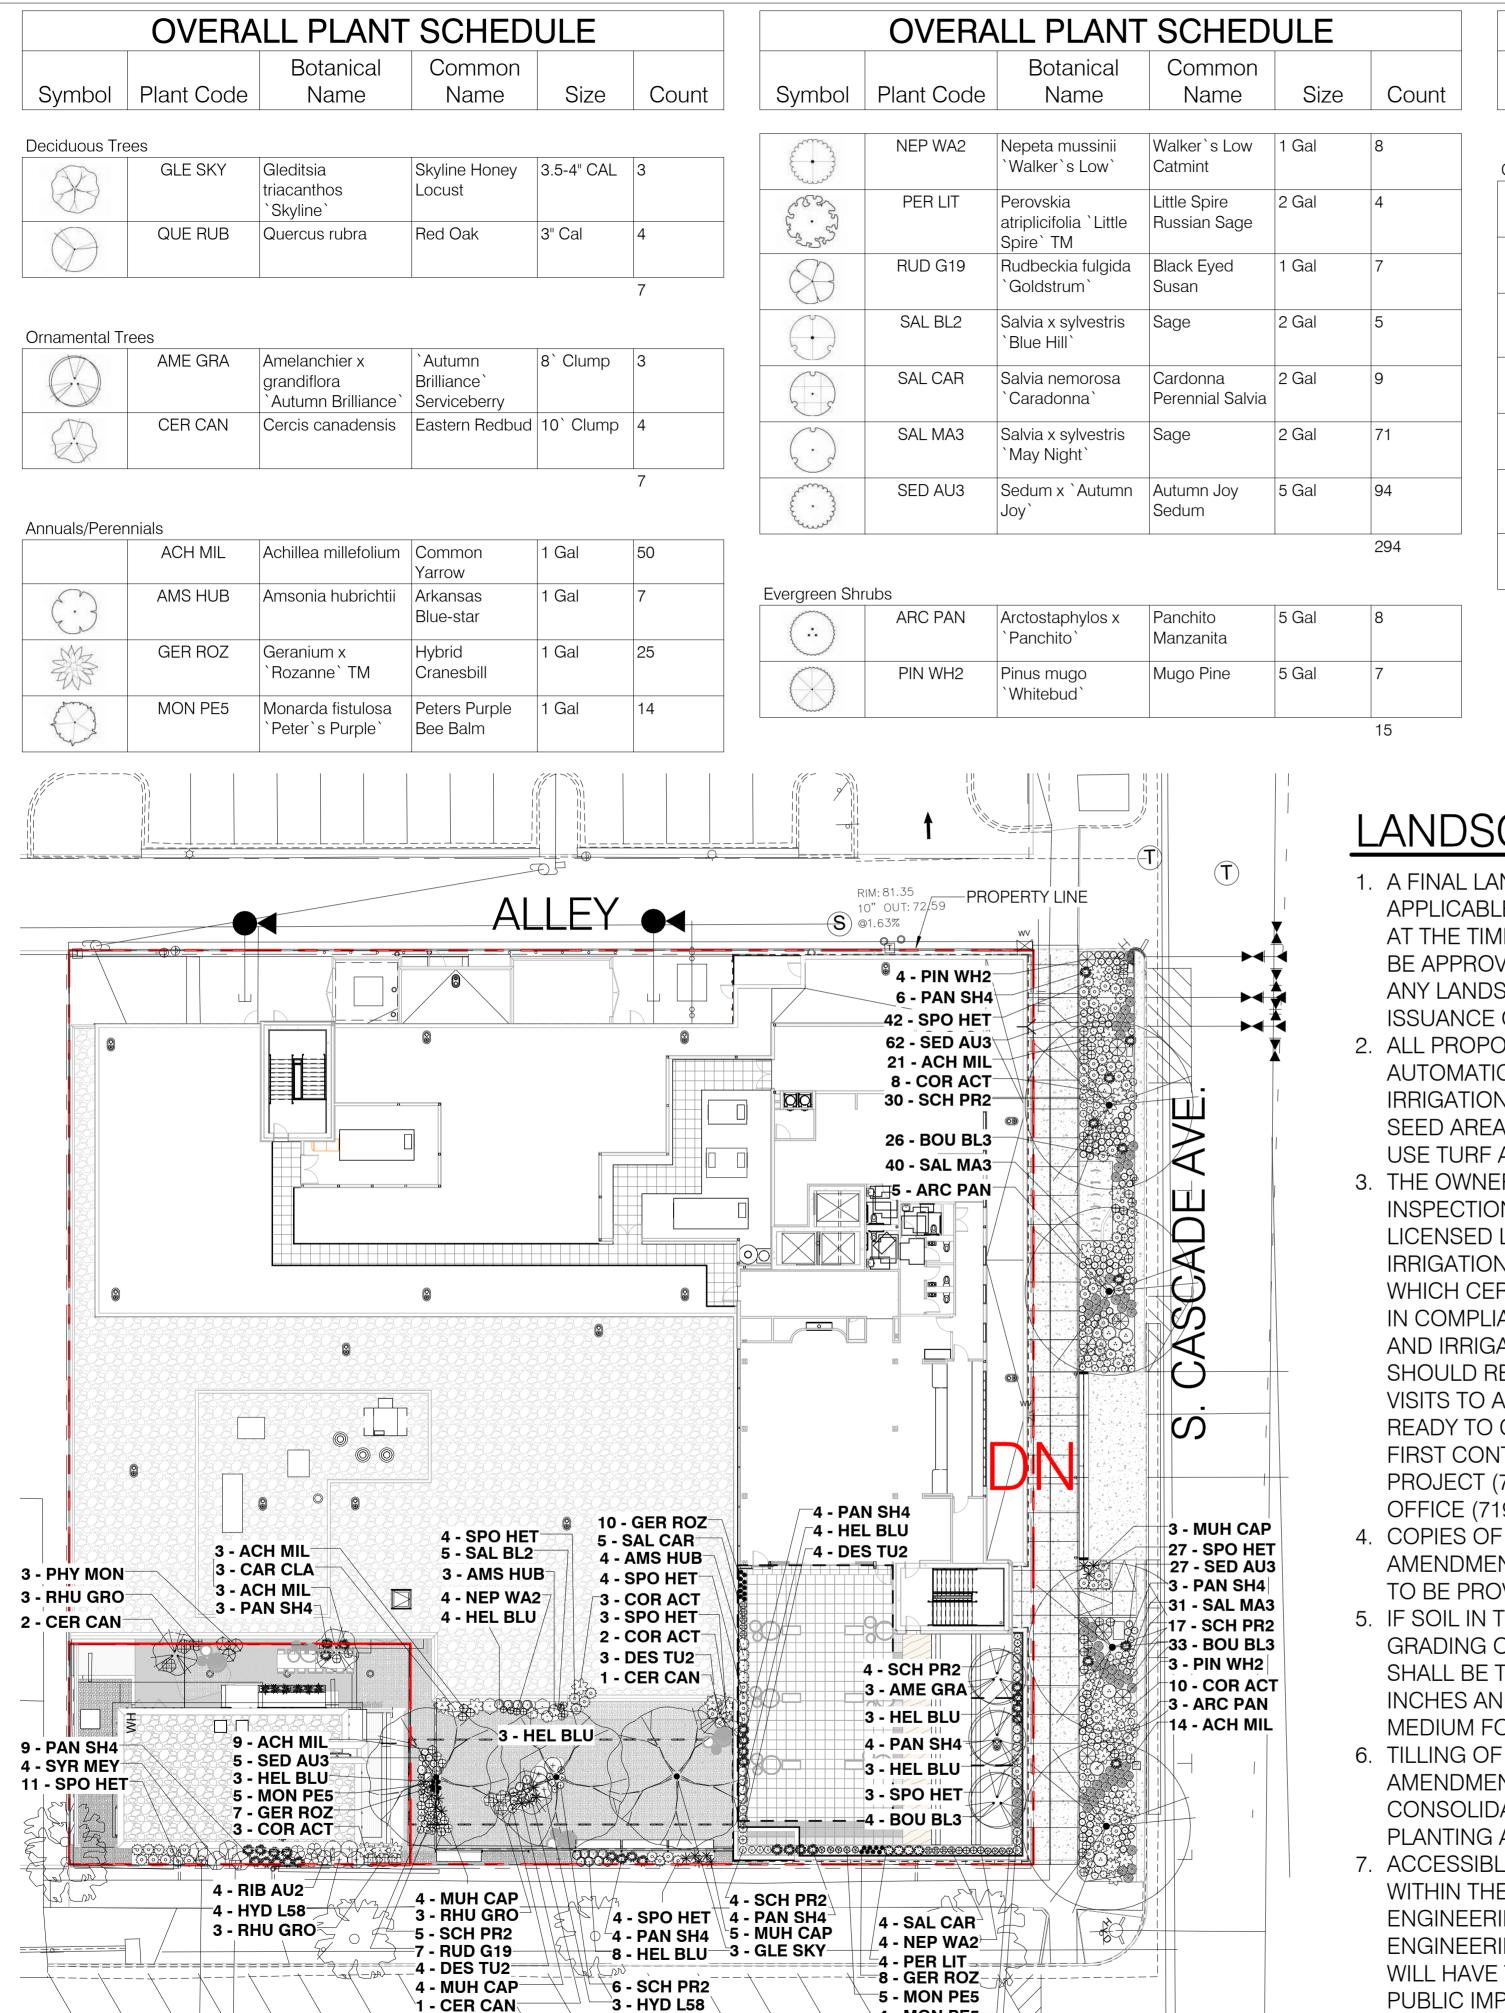

4 - MON PE5-

3 - DES TU2

PRELIMINARY LANDSCAPE PLAN

OVERALL PLANT SCHEDULE Botanical Symbol Size Plant Code Name Name Count

Grasses					
	BOU BL3	Bouteloua gracilis `Blonde Ambition`	Blue Grama	1 Gal	63
{+}	DES TU2	Deschampsia cespitosa	Tufted Hair Grass	1 Gal	14
•	HEL BLU	Helictotrichon sempervirens `Blue Oats`	Blue Oat Grass	1 Gal	28
*	MUH CAP	Muhlenbergia capillaris	Pink Muhly	1 Gal	16
SANNE SANNE	PAN SH4	Panicum virgatum `Shenandoah`	Switch Grass	1 Gal	37
	SCH PR2	Schizachyrium scoparium `Prairie Blues`	Little Bluestem Grass	1 Gal	66
30}	SPO HET	Sporobolus heterolepis	Prairie Dropseed	1 Gal	98

(Shrubs					
	\bigcirc	CAR CLA	Caryopteris x clandonensis `Blue Mist`	Blue Mist Shrub	5 Gal	3
	£3	COR ACT	Cornus stolonifera `Arctic Fire`	Arctic Fire Dogwood	5 Gal	26
	+	HYD L58	Hydrangea paniculata `Little Lime`	Little Lime Hydrangea	5 Gal	7
		PHY MON	Physocarpus monogynus	Mountain Ninebark	5 Gal	3
		RHU GRO	Rhus aromatica `Gro-Low`	Gro-Low Fragrant Sumac	5 gal	9
		RIB AU2	Ribes alpinum `Aureum`	Dwarf Golden Alpine Currant	5 Gal	4
		SYR MEY	Syringa meyeri `Palibin`	Dwarf Korean Lilac	5 gal	4

OVERALL PLANT SCHEDULE

Common Name

Size

Count

56

Botanical


Name


Plant Code

Symbol

LANDSCAPE NOTES

- 1. A FINAL LANDSCAPE AND IRRIGATION PLAN, WITH APPLICABLE SUPPORTING MATERIAL. SHALL BE SUBMITTED AT THE TIME OF BUILDING PERMIT APPLICATION AND SHALL BE APPROVED BEFORE ANY BUILDING PERMIT APPROVAL ANY LANDSCAPE OR IRRIGATION CONSTRUCTION, AND ISSUANCE OF A CERTIFICATE OF OCCUPANCY
- 2. ALL PROPOSED LANDSCAPING SHALL BE WATERED BY ANN AUTOMATIC IRRIGATION SYSTEM WHICH WILL PROVIDE DRIP IRRIGATION TO ALL SHRUB BEDS AND TREES WITHIN NATIVE SEED AREAS AND SPRAY IRRIGATION TO ALL HIGH WATER USE TURF AND NATIVE SEED
- 3. THE OWNER OR DEVELOPER IS REQUIRED TO PROVIDE INSPECTION AFFIDAVITS EXECUTED BY THE COLORADO LICENSED LANDSCAPE ARCHITECT OR CERTIFIED IRRIGATION DESIGNER OF RECORD FOR THE PROJECT WHICH CERTIFIES THAT THE PROJECT WAS INSTALLED AND IN COMPLIANCE WITH THE APPROVED FINAL LANDSCAPE AND IRRIGATION PLAN ON FILE IN CITY PLANNING. THIS SHOULD REQUIRE LIMITED CONSTRUCTION OBSERVATION VISITS TO ACCURATELY COMPLETE THE AFFIDAVITS. WHEN READY TO CALL FOR INSPECTION AND SUBMIT AFFIDAVITS, FIRST CONTACT THE CITY PLANNER OF RECORD FOR THE PROJECT (719-385-5905) AND AS NECESSARY OUR DRE OFFICE (719-385-5982)
- 4. COPIES OF RECEIPTS/DELIVERY TICKETS FOR SOIL AMENDMENTS INSTALLED ON THE PROJECT ARE REQUIRED TO BE PROVIDED WITH THE INSPECTION AFFIDAVITS.
- 5. IF SOIL IN THE PARKING LOT HAS BEEN COMPACTED BY GRADING OPERATIONS, THE SOIL WITHIN THE PLANTER SHALL BE TILLED, OR REMOVED TO A DEPTH OF THIRTY (30) INCHES AND REPLACED WITH AN ACCEPTABLE GROWING MEDIUM FOR THE SPECIES BEING INSTALLED.
- 6. TILLING OF THE EXISTING SOIL TO INCORPORATE AMENDMENTS AND COUNTER ANY COMPACTION OR SOIL CONSOLIDATION SHALL BE REQUIRED FOR ALL LANDSCAPE PLANTING AREAS.
- 7. ACCESSIBLE ROUTES, INCLUDING RAMPS AND SIDEWALKS. WITHIN THE PUBLIC RIGHT-OF-WAY SHALL BE PER CITY ENGINEERING STANDARD DRAWINGS AND SPECIFICATIONS. ENGINEERING DEVELOPMENT REVIEW DIVISION INSPECTOR WILL HAVE THE FINAL AUTHORITY ON ACCEPTING THE PUBLIC IMPROVEMENTS.
- 8. TREES SHALL MAINTAIN A 15'-0" SEPARATION FROM WATER AND WASTEWATER MAINS AND A 6'-0" MINIMUM SEPARATION FROM ELECTRIC AND GAS DISTRIBUTION LINES.
- 9. LANDSCAPE IMPROVEMENTS AND MAINTENANCE SHALL BE THE RESPONSIBILITY OF OWNER, AND/OR THEIR ASSIGNS.

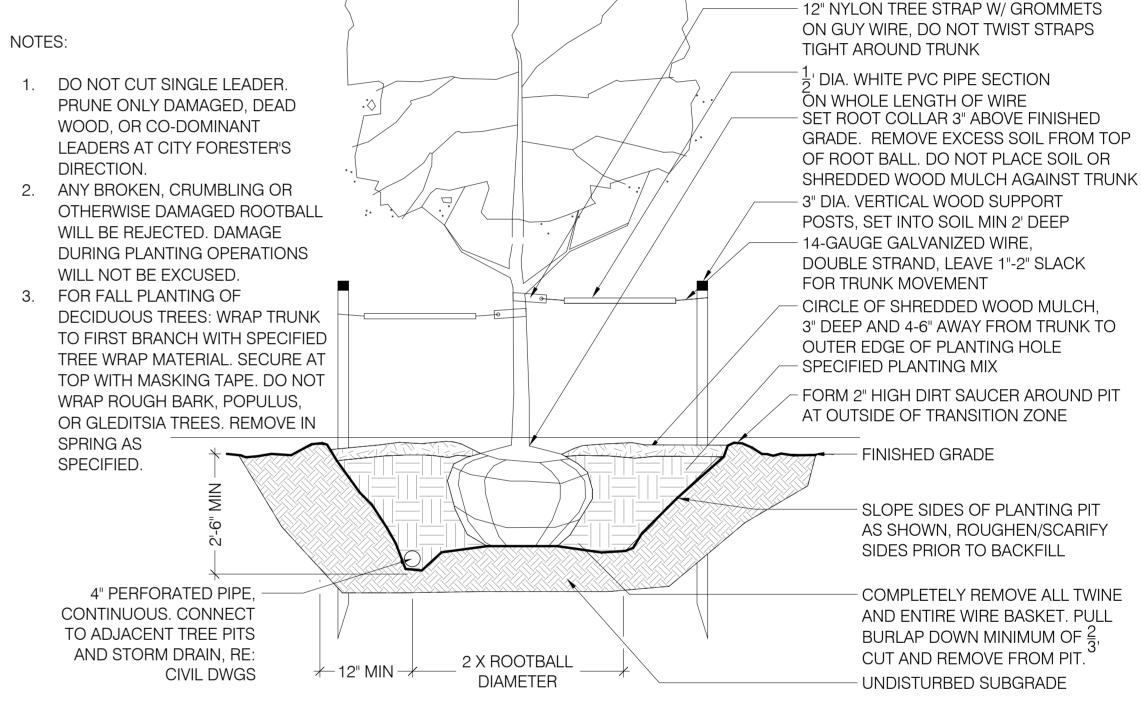


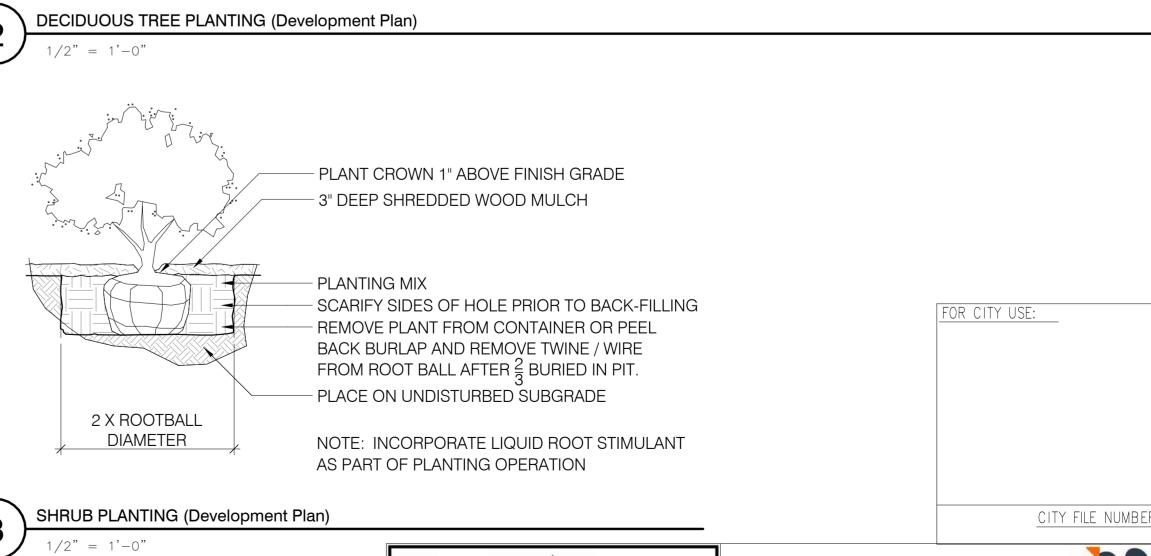



FBZ-CEN DEVELOPMENT PLAN

PRELIMINARY LANDSCAPE PLAN DESIGNED BY TM/RZ SCALE | TM/RZ | (H) 1"= 20' | SHEET 8 OF 18 CHECKED BY | TM/PS | (V) 1" = N/A | JOB NO. 2539.66

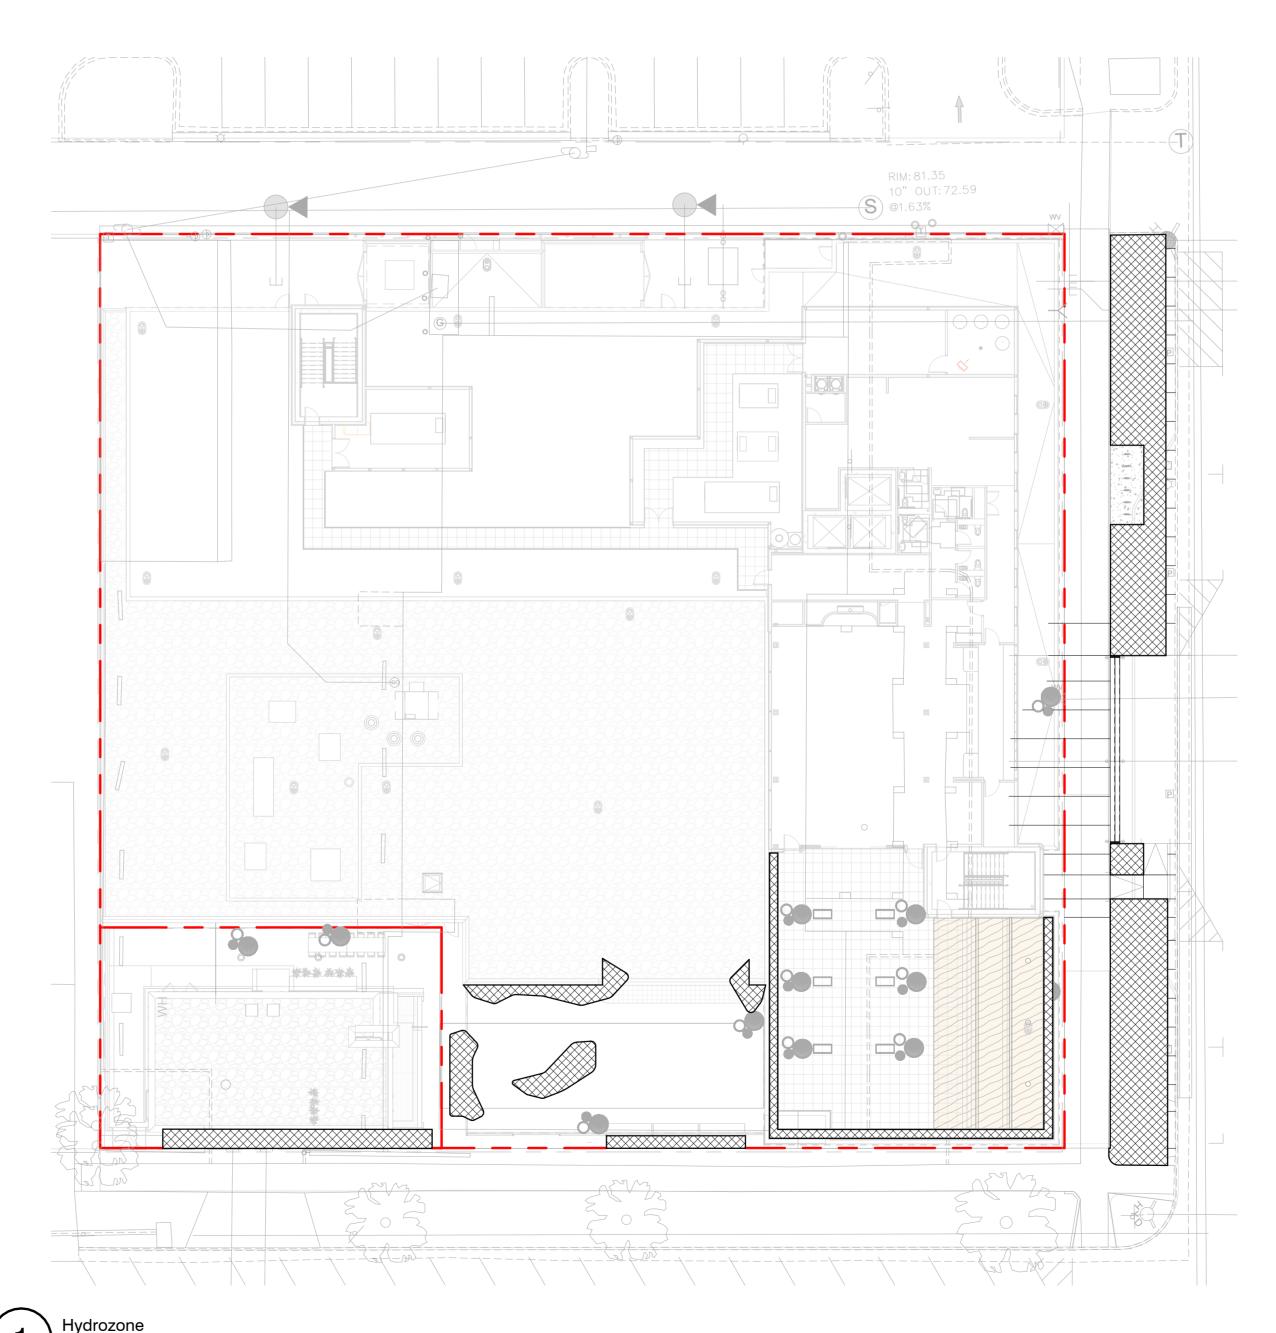

LEGEND

SITE WATER USE AREA TOTALS

MED WATER USE(M) - 2528.26 SF

FOR CITY USE:


CITY FILE NUMBER




524 S. CASCADE AVENUE


FBZ-CEN DEVELOPMENT PLAN

PRELIMINARY LANDSCAPE PLAN DESIGNED BY TM/RZ SCALE DRAWN BY TM/RZ (H) 1"= 20' SHEET 9 OF 18 CHECKED BY TM/PS (V) 1"= N/A JOB NO. 2539.66

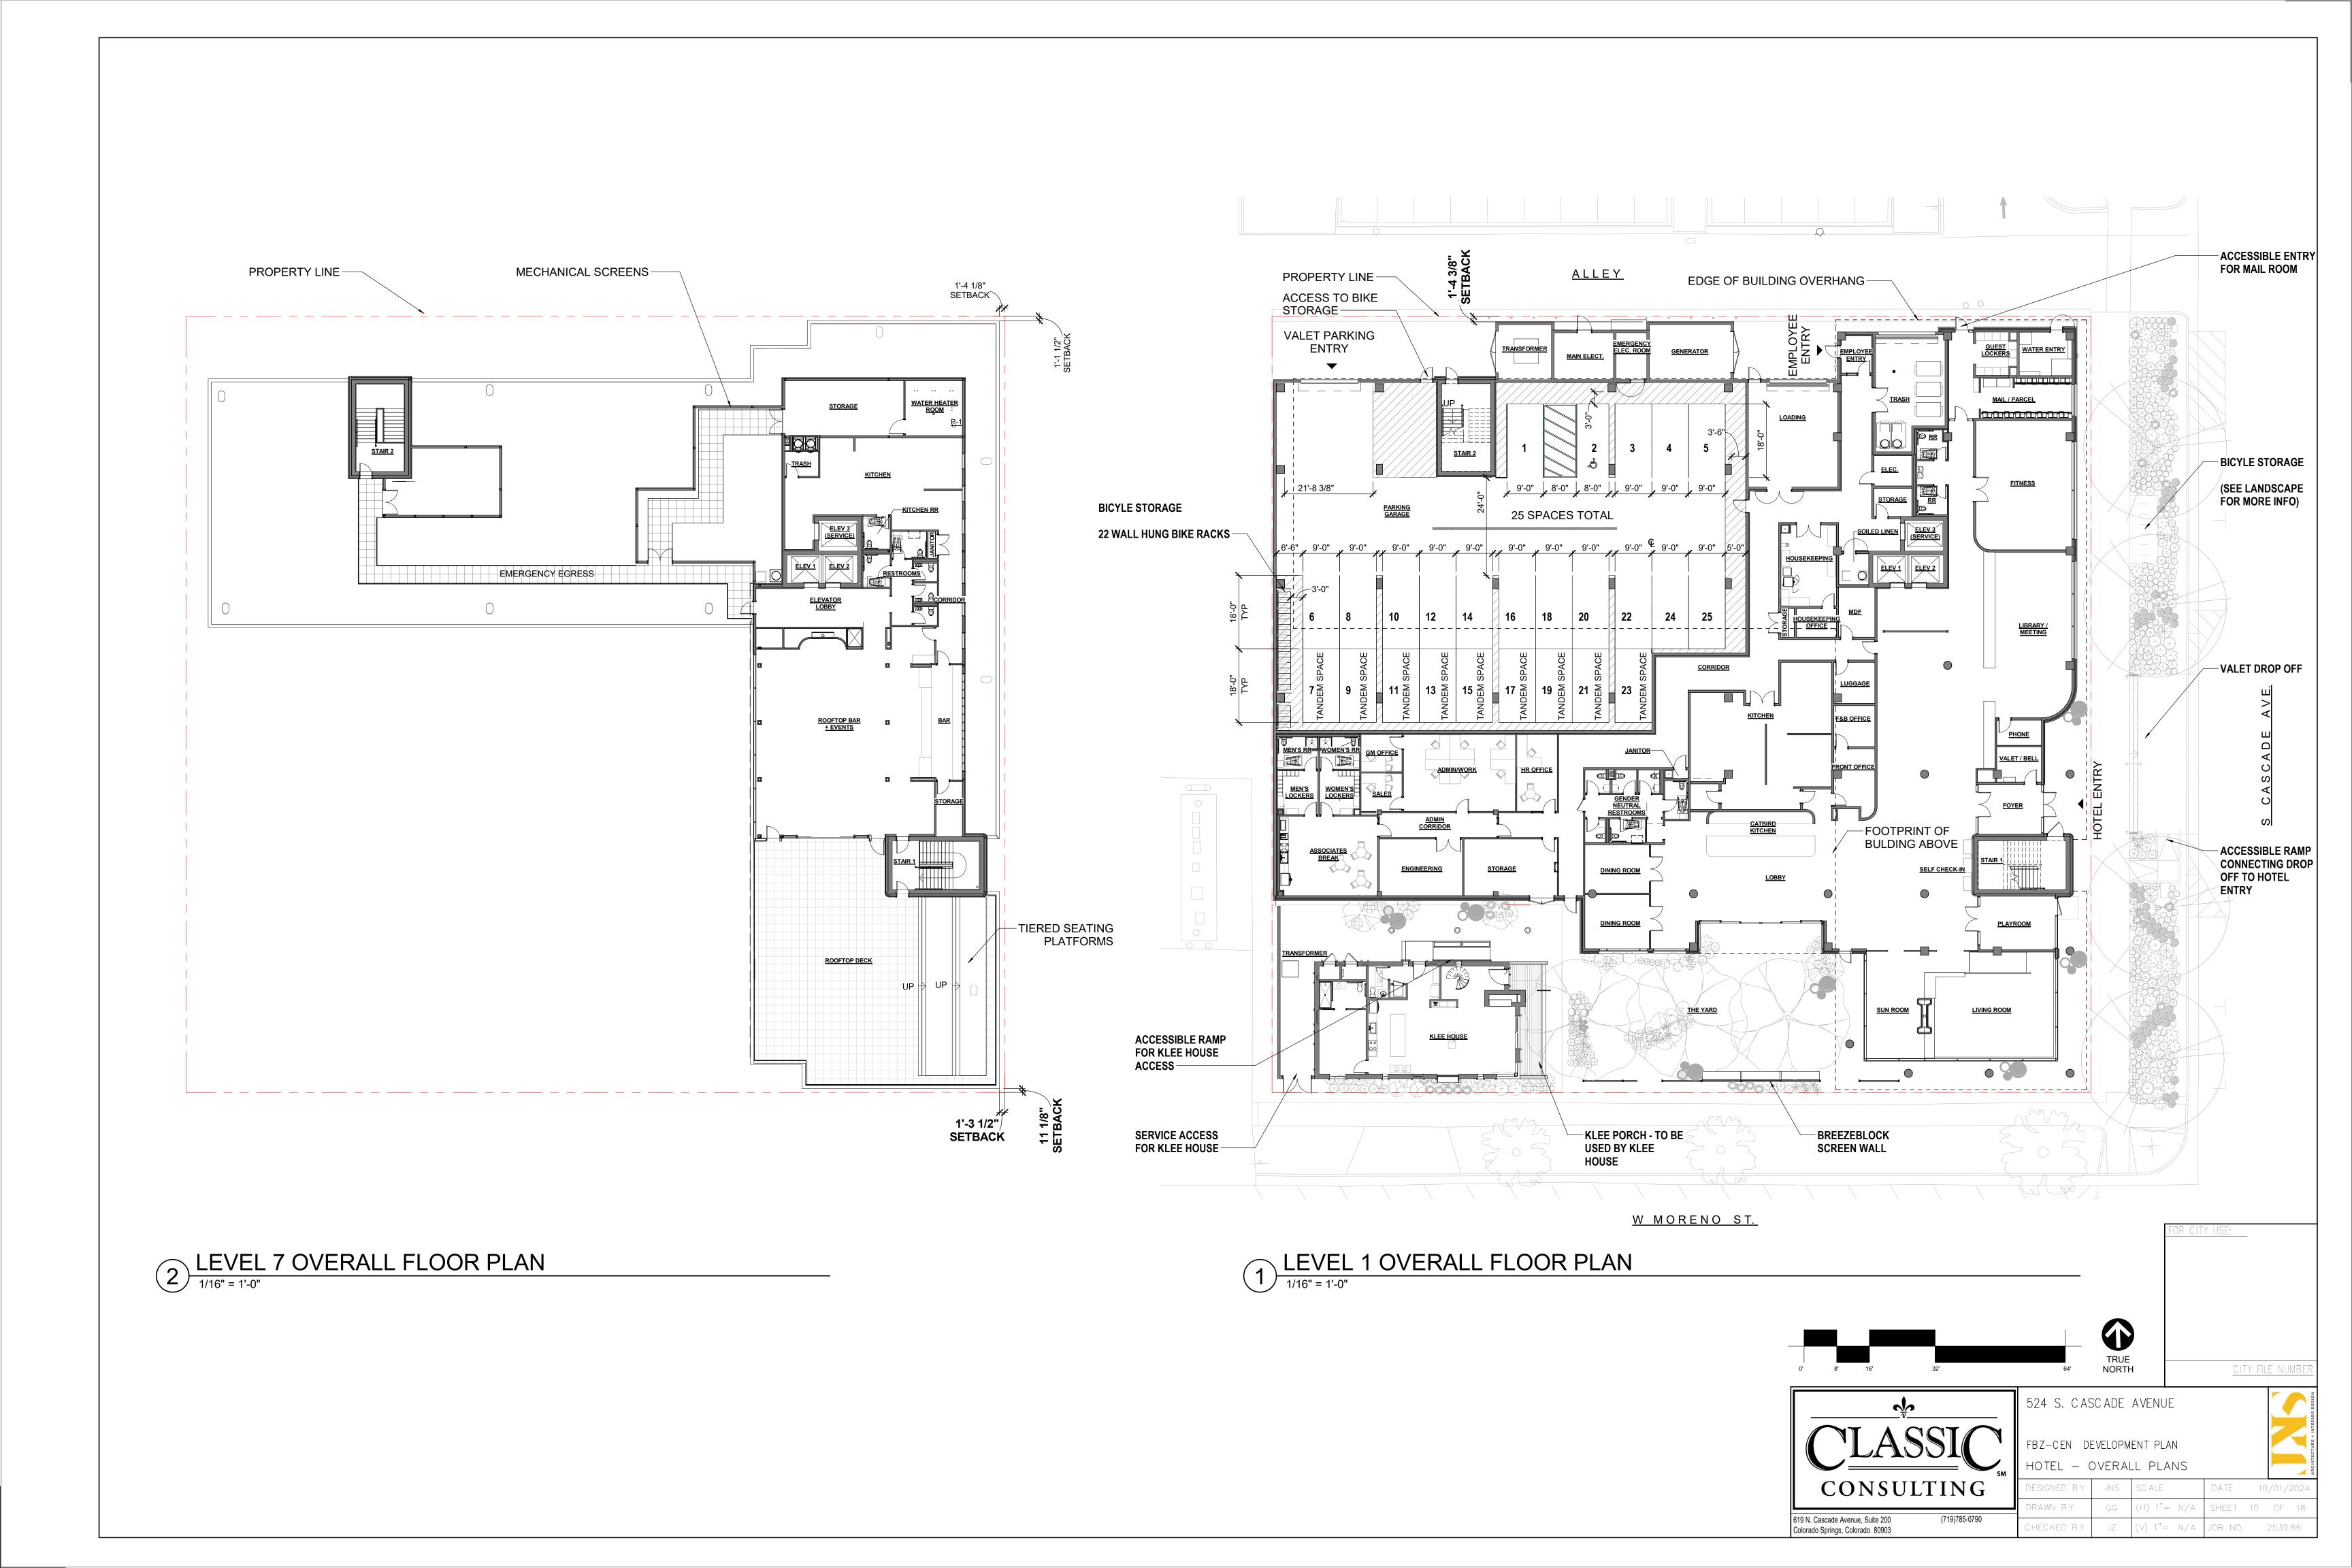

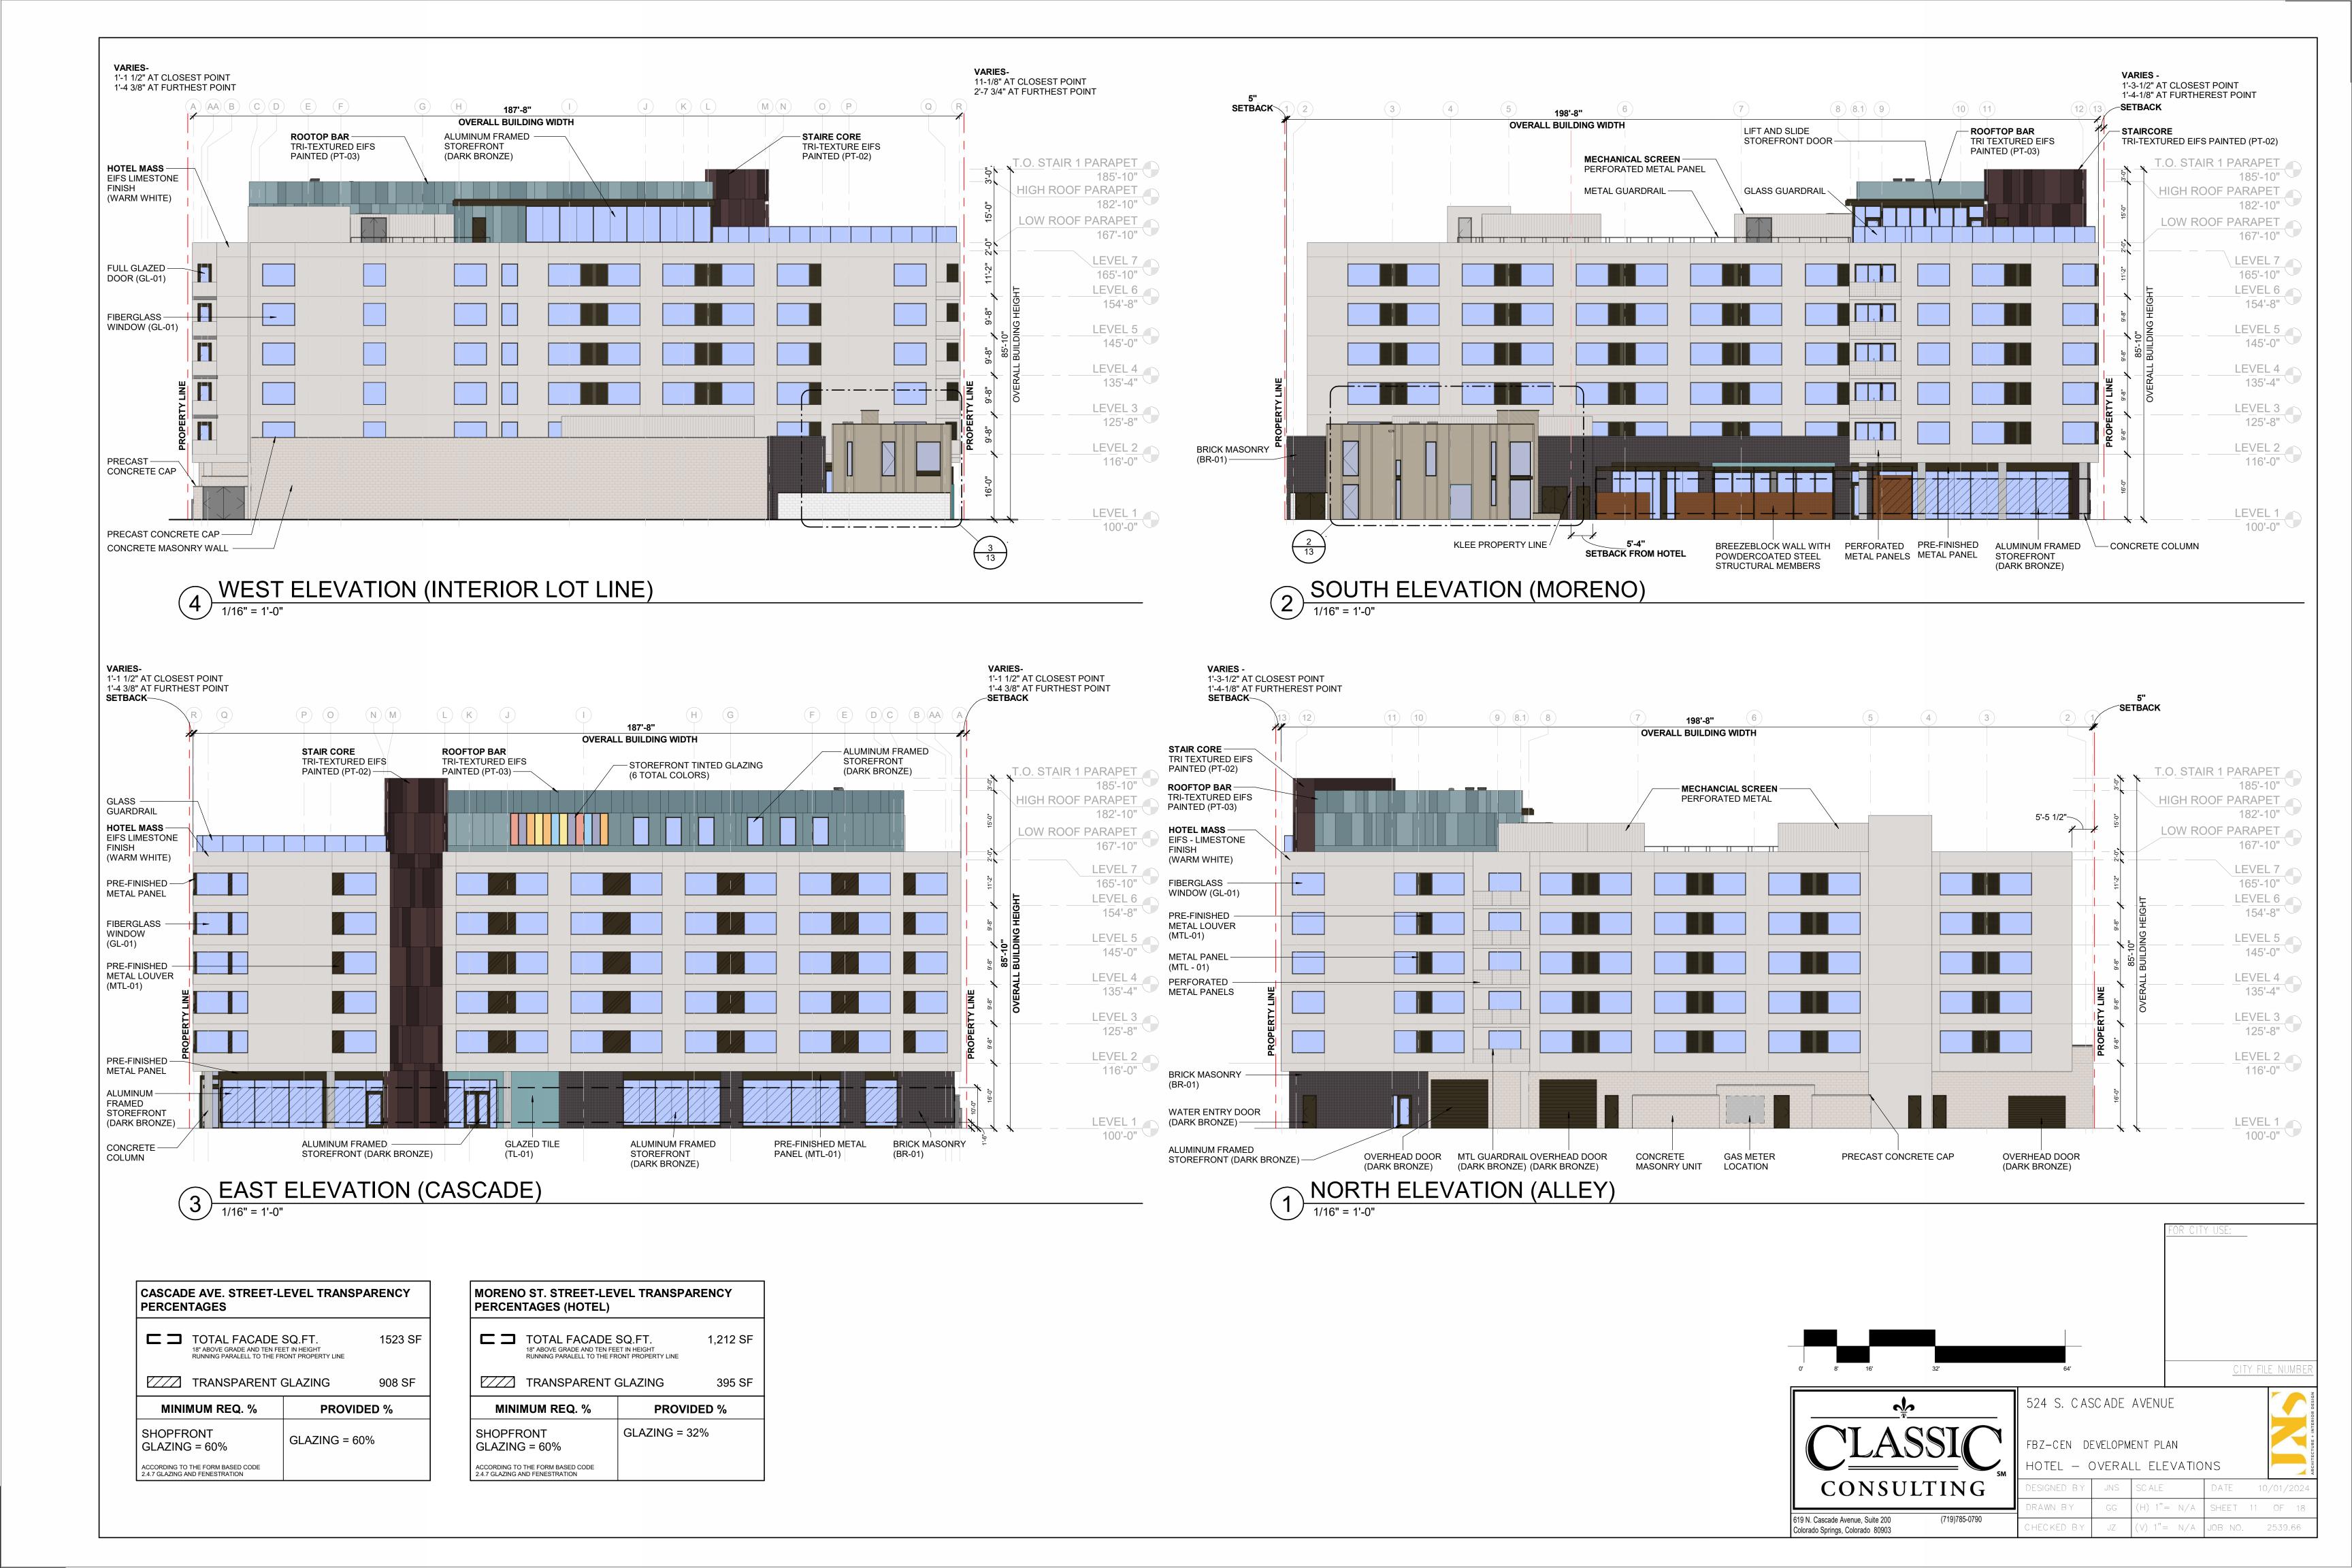



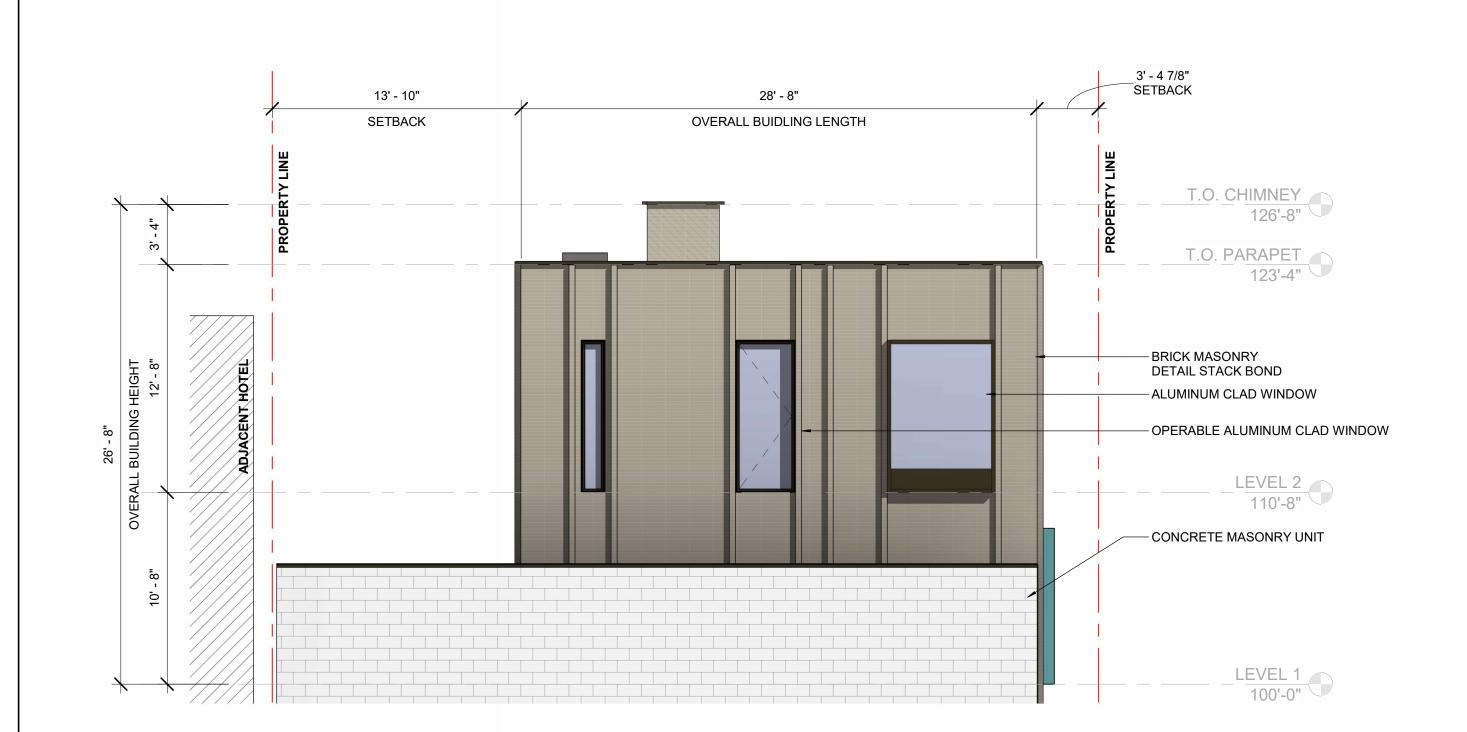


3 KLEE HOUSE - WEST ELEVATION 3/16" = 1'-0"



KLEE HOUSE - EAST ELEVATION


3/16" = 1'-0"

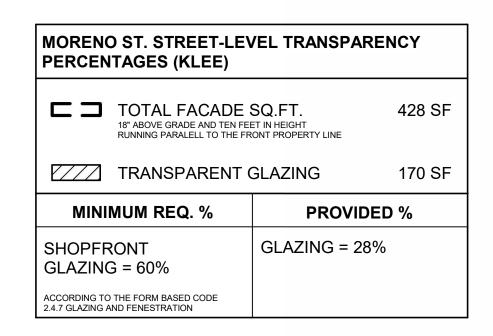




KLEE HOUSE - SOUTH ELEVATION (MORENO)


3/16" = 1'-0"

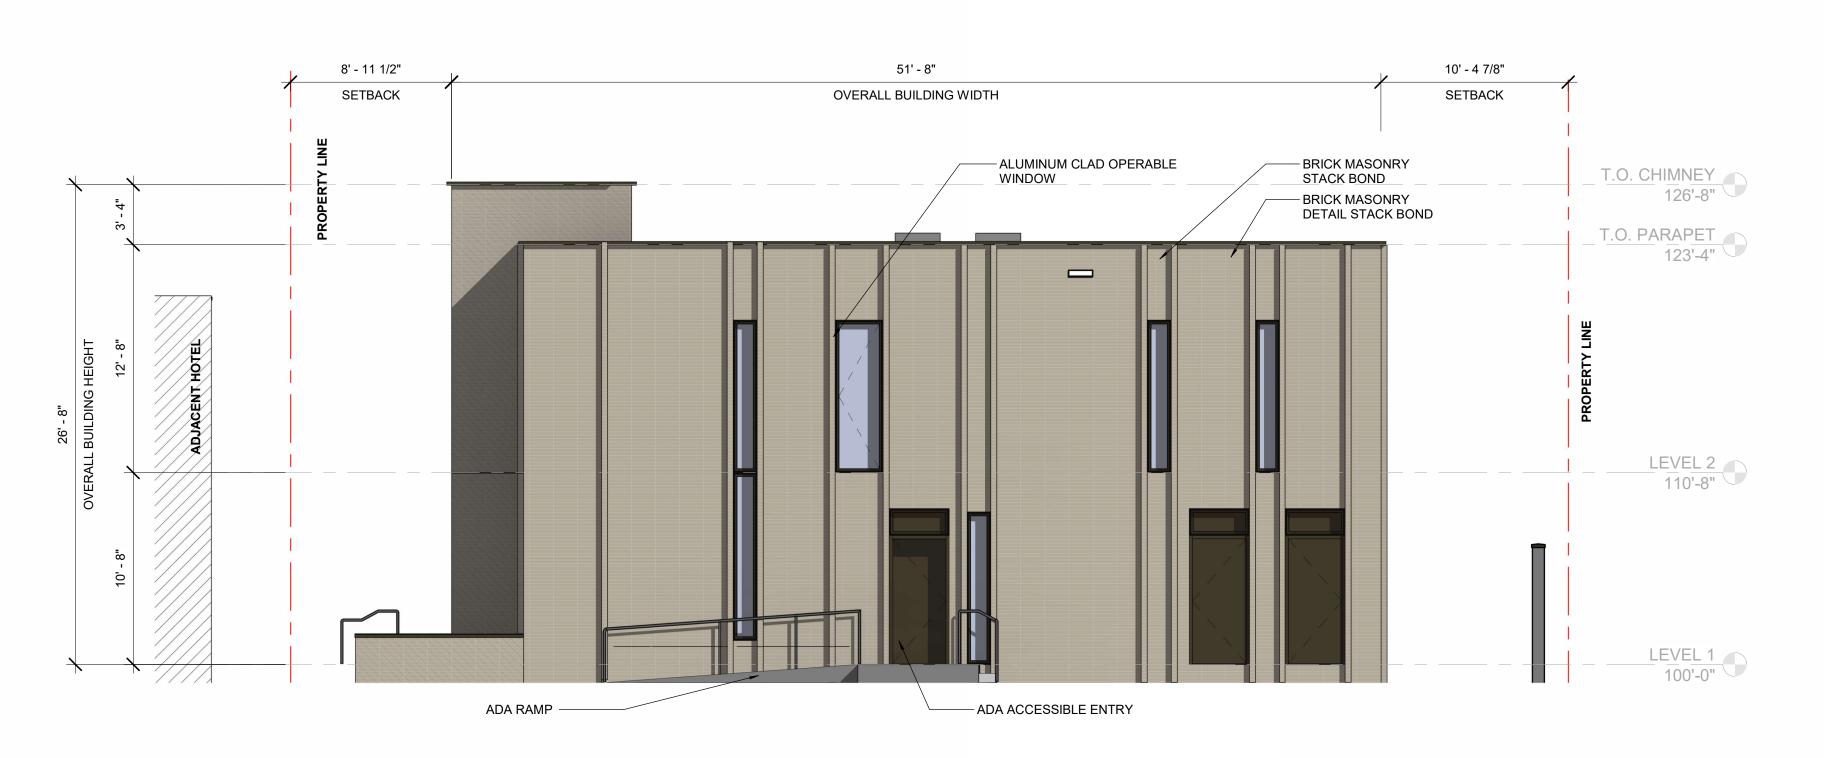

1 KLEE HOUSE - NORTH ELEVATION
3/16" = 1'-0"

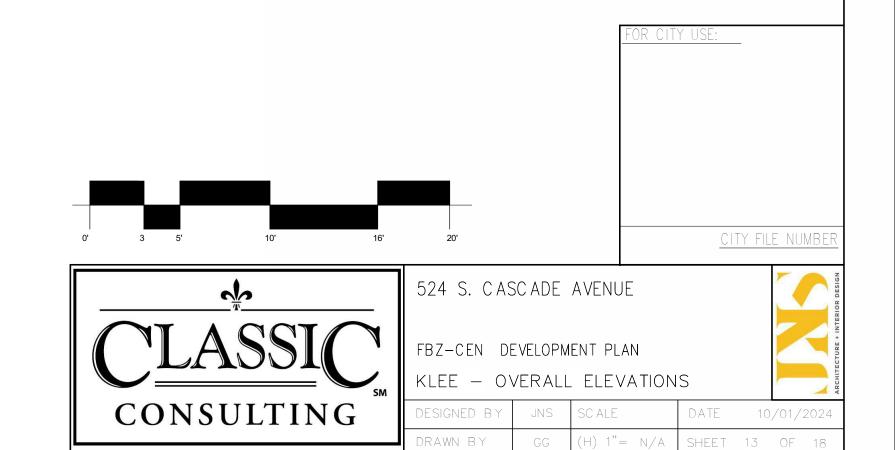

619 N. Cascade Avenue, Suite 200 Colorado Springs, Colorado 80903

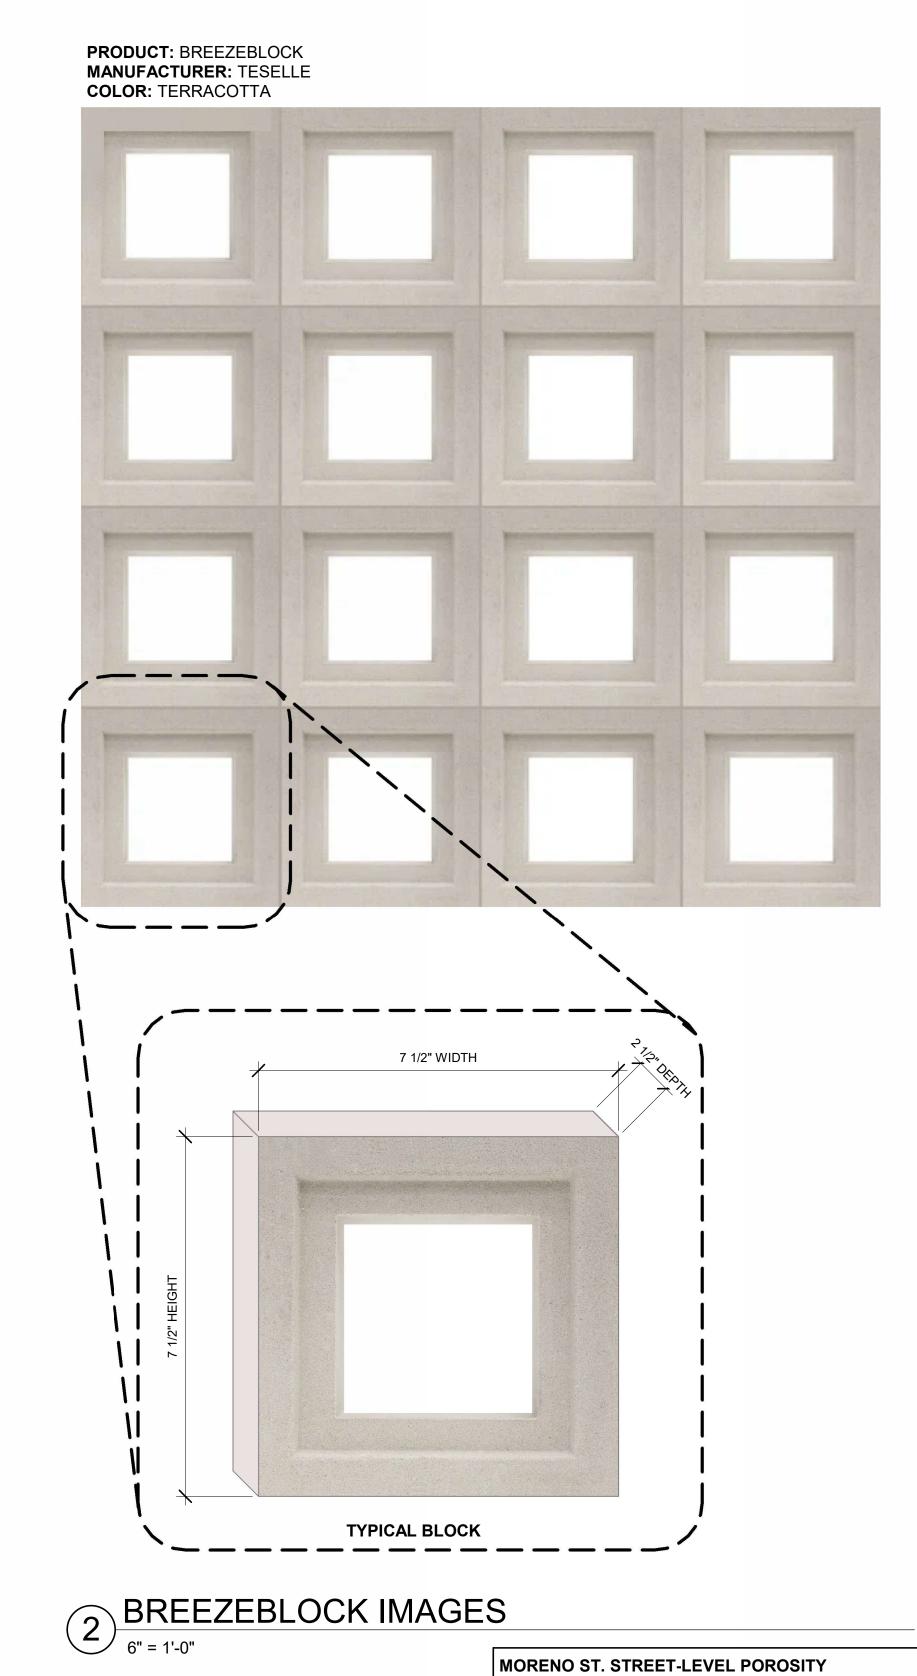

PERCENTAGES (BREEZEBLOCK)

TOTAL FACADE SQ.FT.


18" ABOVE GRADE AND TEN FEET IN HEIGHT RUNNING PARALELL TO THE FRONT PROPERTY LINE

431 SF

PROVIDED %

POROSITY = 66%

TRANSPARENT GLAZING

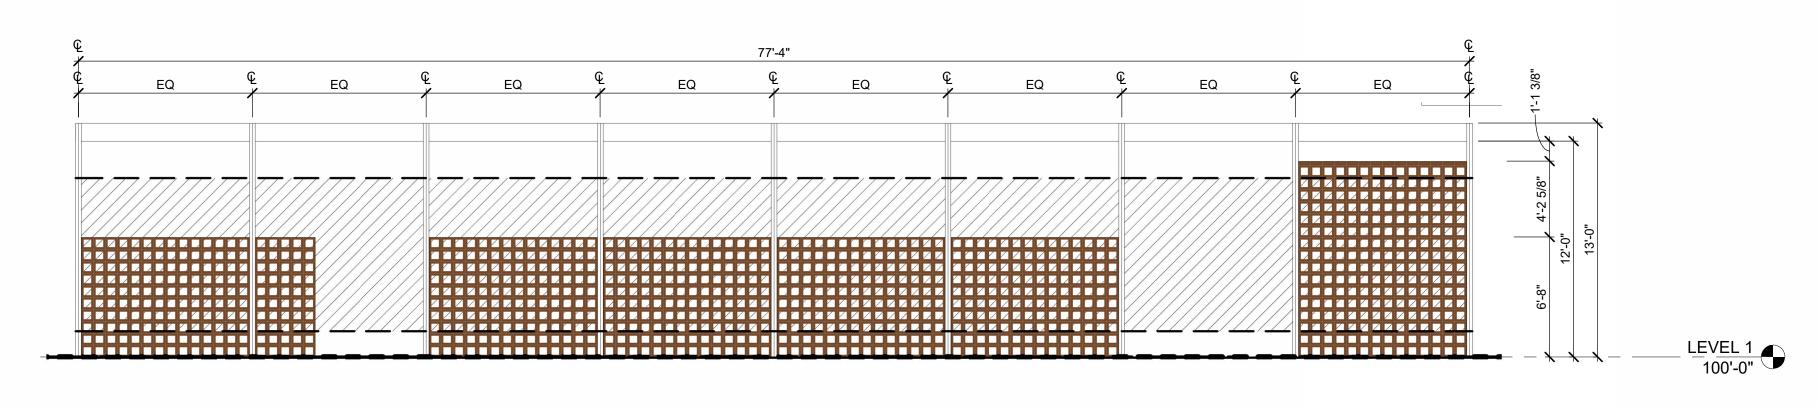

3 BREEZEBLOCK ELEVATION

3/16" = 1'-0"



VIEW FROM MORENO

N.T.S.

CONSULTING 619 N. Cascade Avenue, Suite 200 Colorado Springs, Colorado 80903

524 S. CASCADE AVENUE

CITY FILE NUMBE

FBZ-CEN DEVELOPMENT PLAN BREEZEBLOCK DETAILS

NOTES:

- CALCULATION POINTS ARE BASED ON A 10' X 10' GRID.
- 2. LIGHT TRESPASS CALCULATIONS POINTS ARE BASED ON A 5' ON CENTER SPACING AT A HEIGHT OF 3'-0" ABOVE FINISH GROUND.
- 3. ALL ILLUMINANCE VALUES IN CALCULATION GRID ARE SHOWN AT GRADE AND WERE CALCULCATED USING A LIGHT LOSS FACTOR OF
- 4. PER CITY OF COLORADO SPRINGS UDC CODE SECTION 7.4.1203.C.1: ALL LIGHTING FIXTURES SHALL BE INSTALLED SO THAT LIGHT TRESPASS FROM ANY PROPERTY LINE, EXCEPT A PROPERTY LINE ADJACENT TO A PUBLIC STREET, SHALL NOT EXCEED ONE (1) FOOTCANDLE AT THE PROPERTY LINE. IT IS ASSUMED THE ALLEY TO THE NORTH IS A PUBLIC STREET IN ADDITION TO S. CASCADE AVE. AND W. MORENO AVE.
- 5. ALL LIGHTS ARE AIMED DOWN TO REDUCE GLARE BEYOND THE PROPERTY LINE. REFER TO LUMINAIRE SCHEDULE FOR BUG RATINGS.
- 6. ALL EXTERIOR LIGHTING TO BE CONTROLLED ACCORDING TO 2021 IECC REQUIREMENTS.

	SITE LUMINAIRE SCHEDULE										
TYPE	DESCRIPTION	MOUNTING	TYPE	INITIAL LUMENS	CRI	ССТ	CUTOFF	INPUT WATTS	MANUFACTURER	CATALOG NUMBER	SPECIFIC NOTES
X01	HANDRAIL LIGHT	HANDRAIL	LED	160	80	2700K	B0-U1-G0	1.5	WILA	PUCK-XT SERIES	
X02	LANDSCAPE LIGHT	STAKE	LED	540	80	2700K	B0-U0-G0	8.4	ZANEEN	FONT POST SERIES	
X03	STEP LIGHT	IN WALL	LED	46	90	2700K	B0-U1-G0	46	DESIGNPLAN	NAKA 2.1 SERIES	
X04	LINEAR LED IN ROUND LENS CHANNEL CONCEALED IN WALL	SURFACE	LED	300 LM/FT	90	2700K	B1-U2-G1	2.5 W/FT	KELVIX	OUTDOOR WHITE LIGHT TAPE SERIES WITH CH-016	
X05	RECESSED LED DOWNLIGHT	RECESSED	LED	1100	90	2700K	B1-U0-G0	13.4	USAI	BEVELLED MINI BASIC SERIES	
X06	MOONLIGHTS MOUNTED HIGH IN TREES	TREE	LED	189	80	2700K	B0-U3-G0	2.3	SPJ	LI'L BEAST SERIES	
X07	LINEAR LED IN ROUND LENS CHANNEL UNDER BENCH	SURFACE	LED	100 LM/FT	90	2700K	B1-U2-G1	2.5 W/FT	KELVIX	OUTDOOR WHITE LIGHT TAPE SERIES WITH CH-016	
ZW1G	EXTERIOR WALL PACK WITH FULL CUTOFF DISTRIBUTION	WALL	LED	1024	80	2700K	B1-U0-G0	20.5	BEGA	B22360-2700K-*	

524 S. CASCADE AVENUE

FOR CITY USE:

CONSULTING

619 N. Cascade Avenue, Suite 200
Colorado Springs, Colorado 80903


(719)785-0790

FBZ-CEN DEVELOPMENT PLAN
SITE PHOTOMETRIC PLAN

 DESIGNED BY
 TLN
 SCALE
 DATE
 10/15/2024


 DRAWN BY
 TLN
 (H) 1"= N/A
 SHEET 15 OF 18

 CHECKED BY
 (V) 1"= N/A
 JOB NO. 2539.66

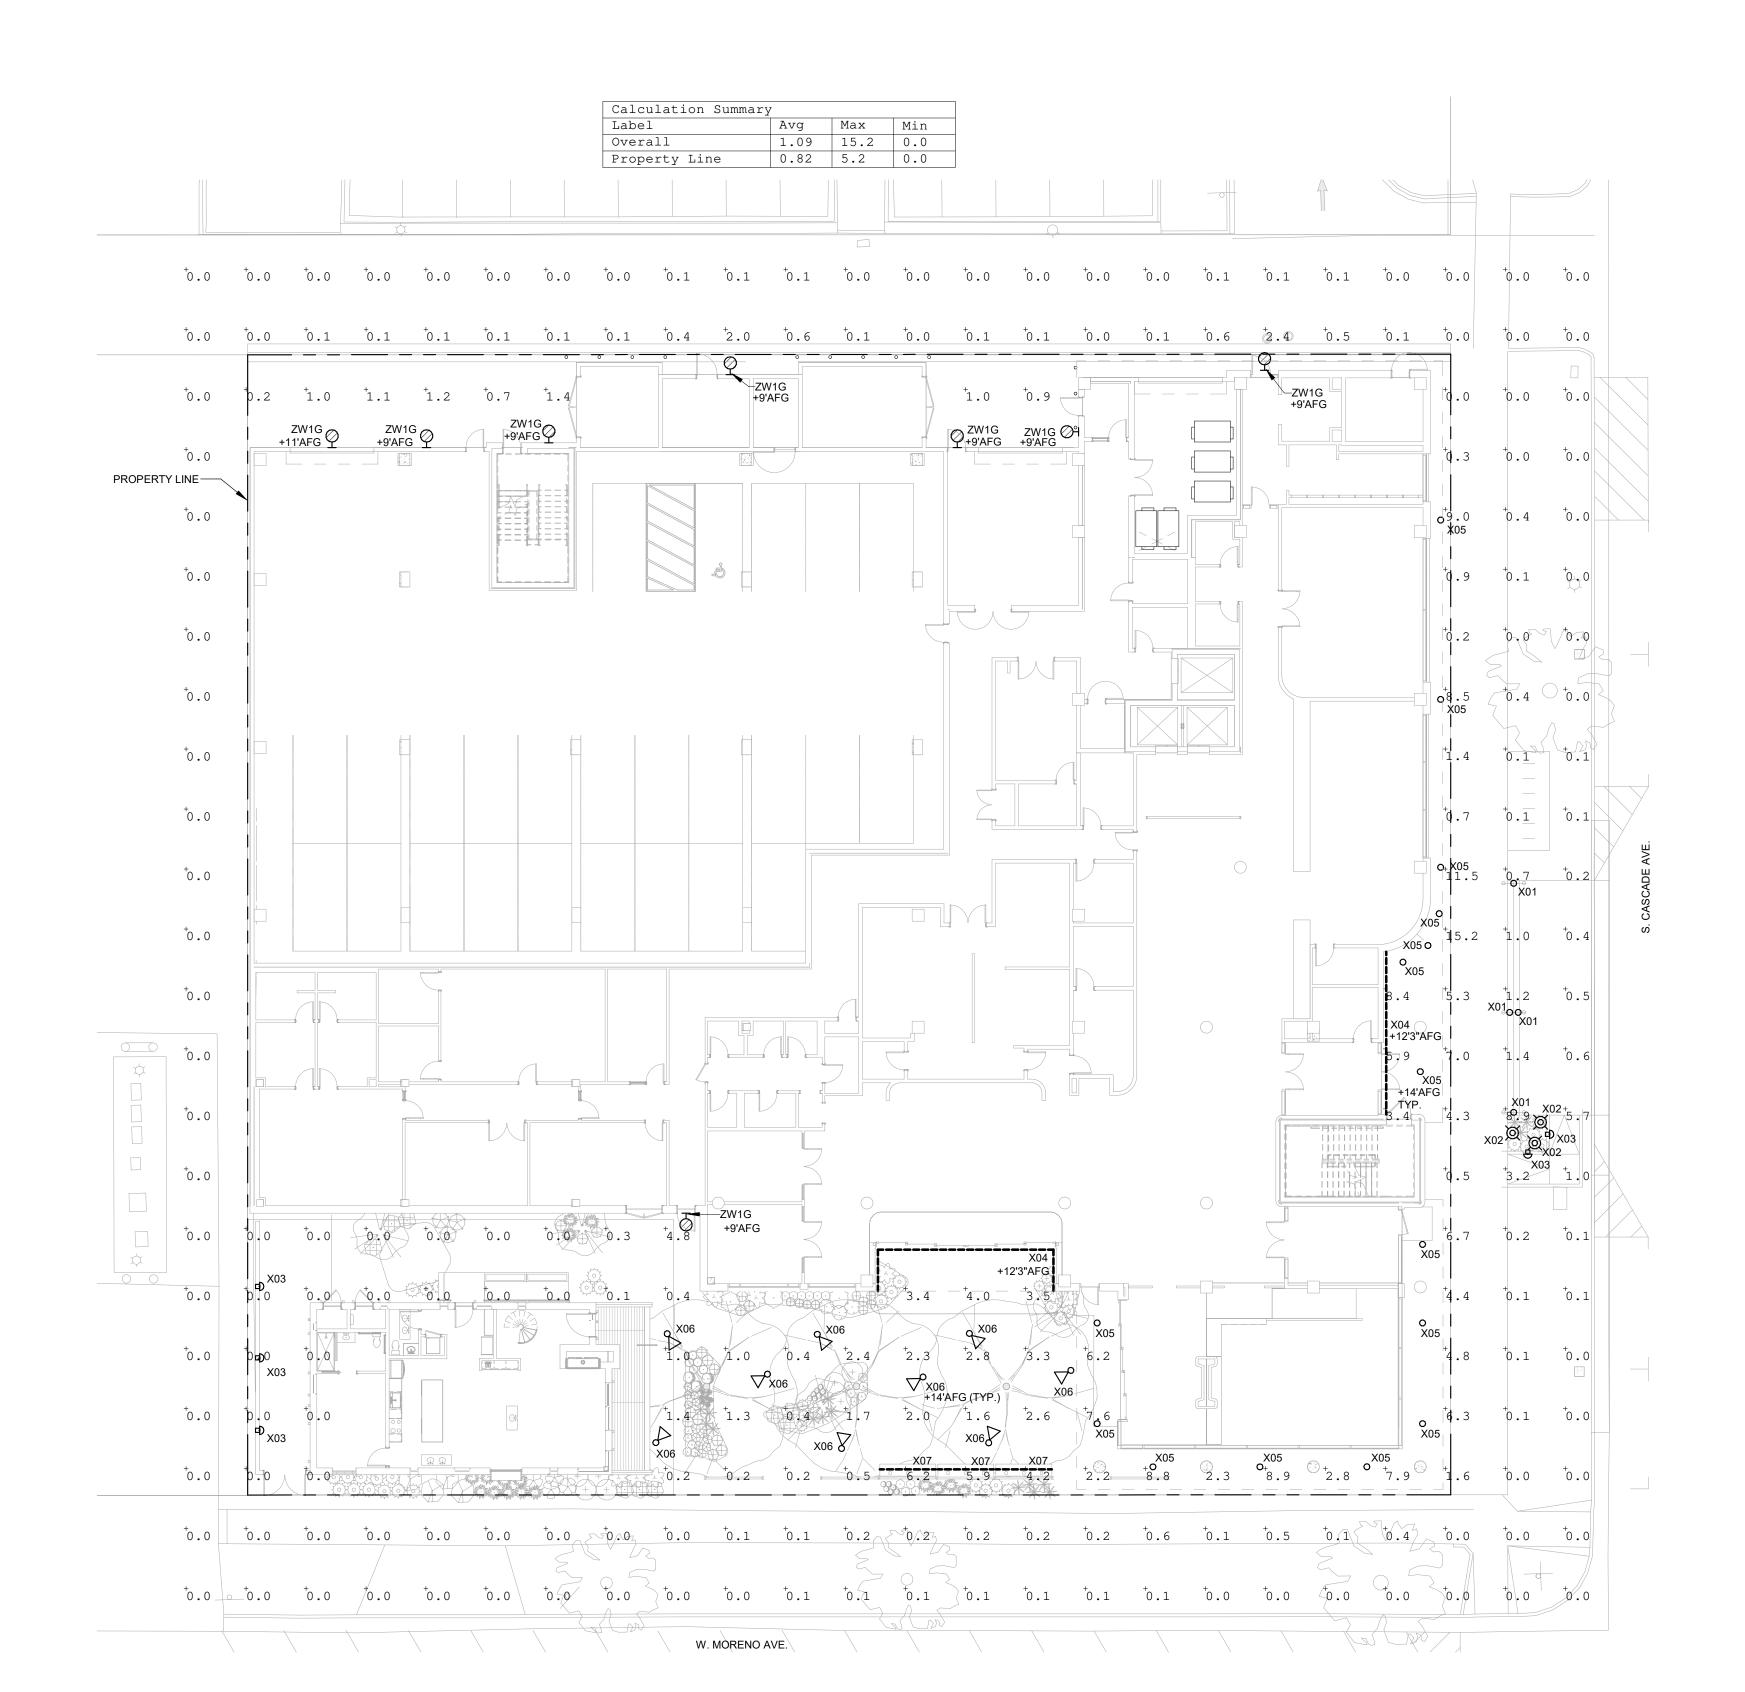

SCALE: 1/16" = 1'-0"



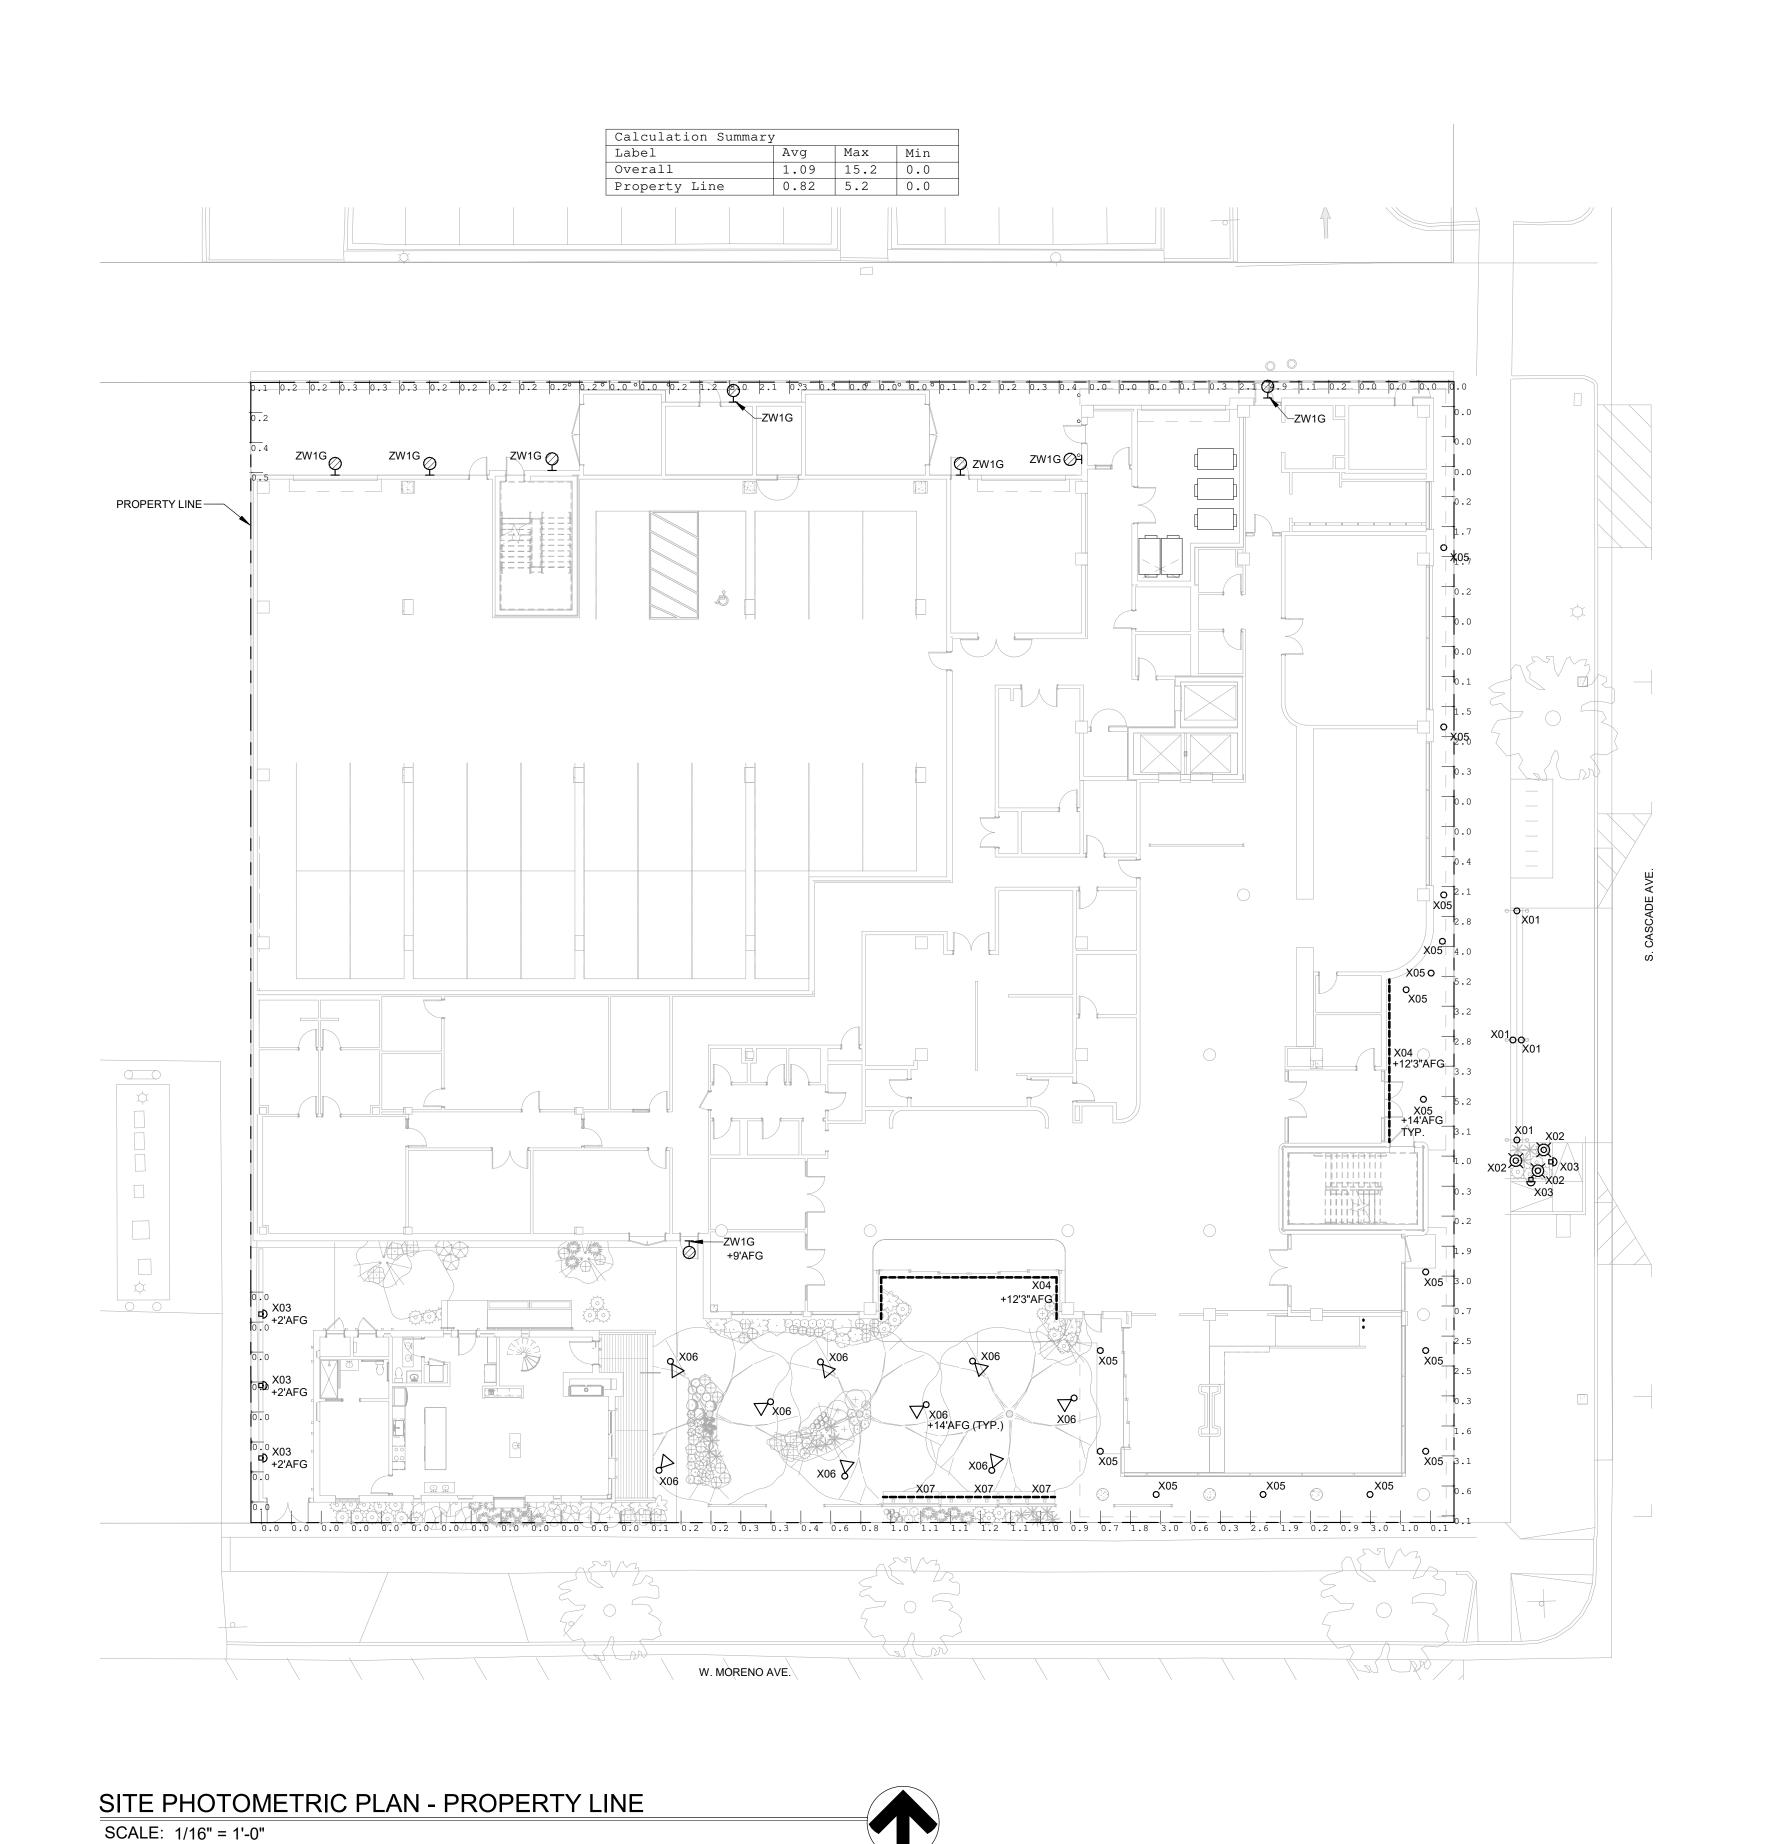

NOTES:

- 1. CALCULATION POINTS ARE BASED ON A 10' X 10'
- LIGHT TRESPASS CALCULATIONS POINTS ARE BASED ON A 5' ON CENTER SPACING AT A HEIGHT OF 3'-0" ABOVE FINISH GROUND.
- 3. ALL ILLUMINANCE VALUES IN CALCULATION GRID ARE SHOWN AT GRADE AND WERE CALCULCATED USING A LIGHT LOSS FACTOR OF
- 4. PER CITY OF COLORADO SPRINGS UDC CODE SECTION 7.4.1203.C.1: ALL LIGHTING FIXTURES SHALL BE INSTALLED SO THAT LIGHT TRESPASS FROM ANY PROPERTY LINE, EXCEPT A PROPERTY LINE ADJACENT TO A PUBLIC STREET, SHALL NOT EXCEED ONE (1) FOOTCANDLE AT THE PROPERTY LINE. IT IS ASSUMED THE ALLEY TO THE NORTH IS A PUBLIC STREET IN ADDITION TO S. CASCADE AVE AND W. MORENO AVE AVE. AND W. MORENO AVE.
- 5. ALL LIGHTS ARE AIMED DOWN TO REDUCE GLARE BEYOND THE PROPERTY LINE. REFER TO LUMINAIRE SCHEDULE FOR BUG RATINGS.
- ALL EXTERIOR LIGHTING TO BE CONTROLLED ACCORDING TO 2021 IECC REQUIREMENTS.


FOR CITY USE:

CITY FILE NUMBER



FBZ-CEN DEVELOPMENT PLAN

SITE PHOTOMETRIC PLAN - PROPERTY LINE **DESIGNED BY** TLN SCALE CHECKED BY (V) 1"= N/A JOB NO. 2539.66

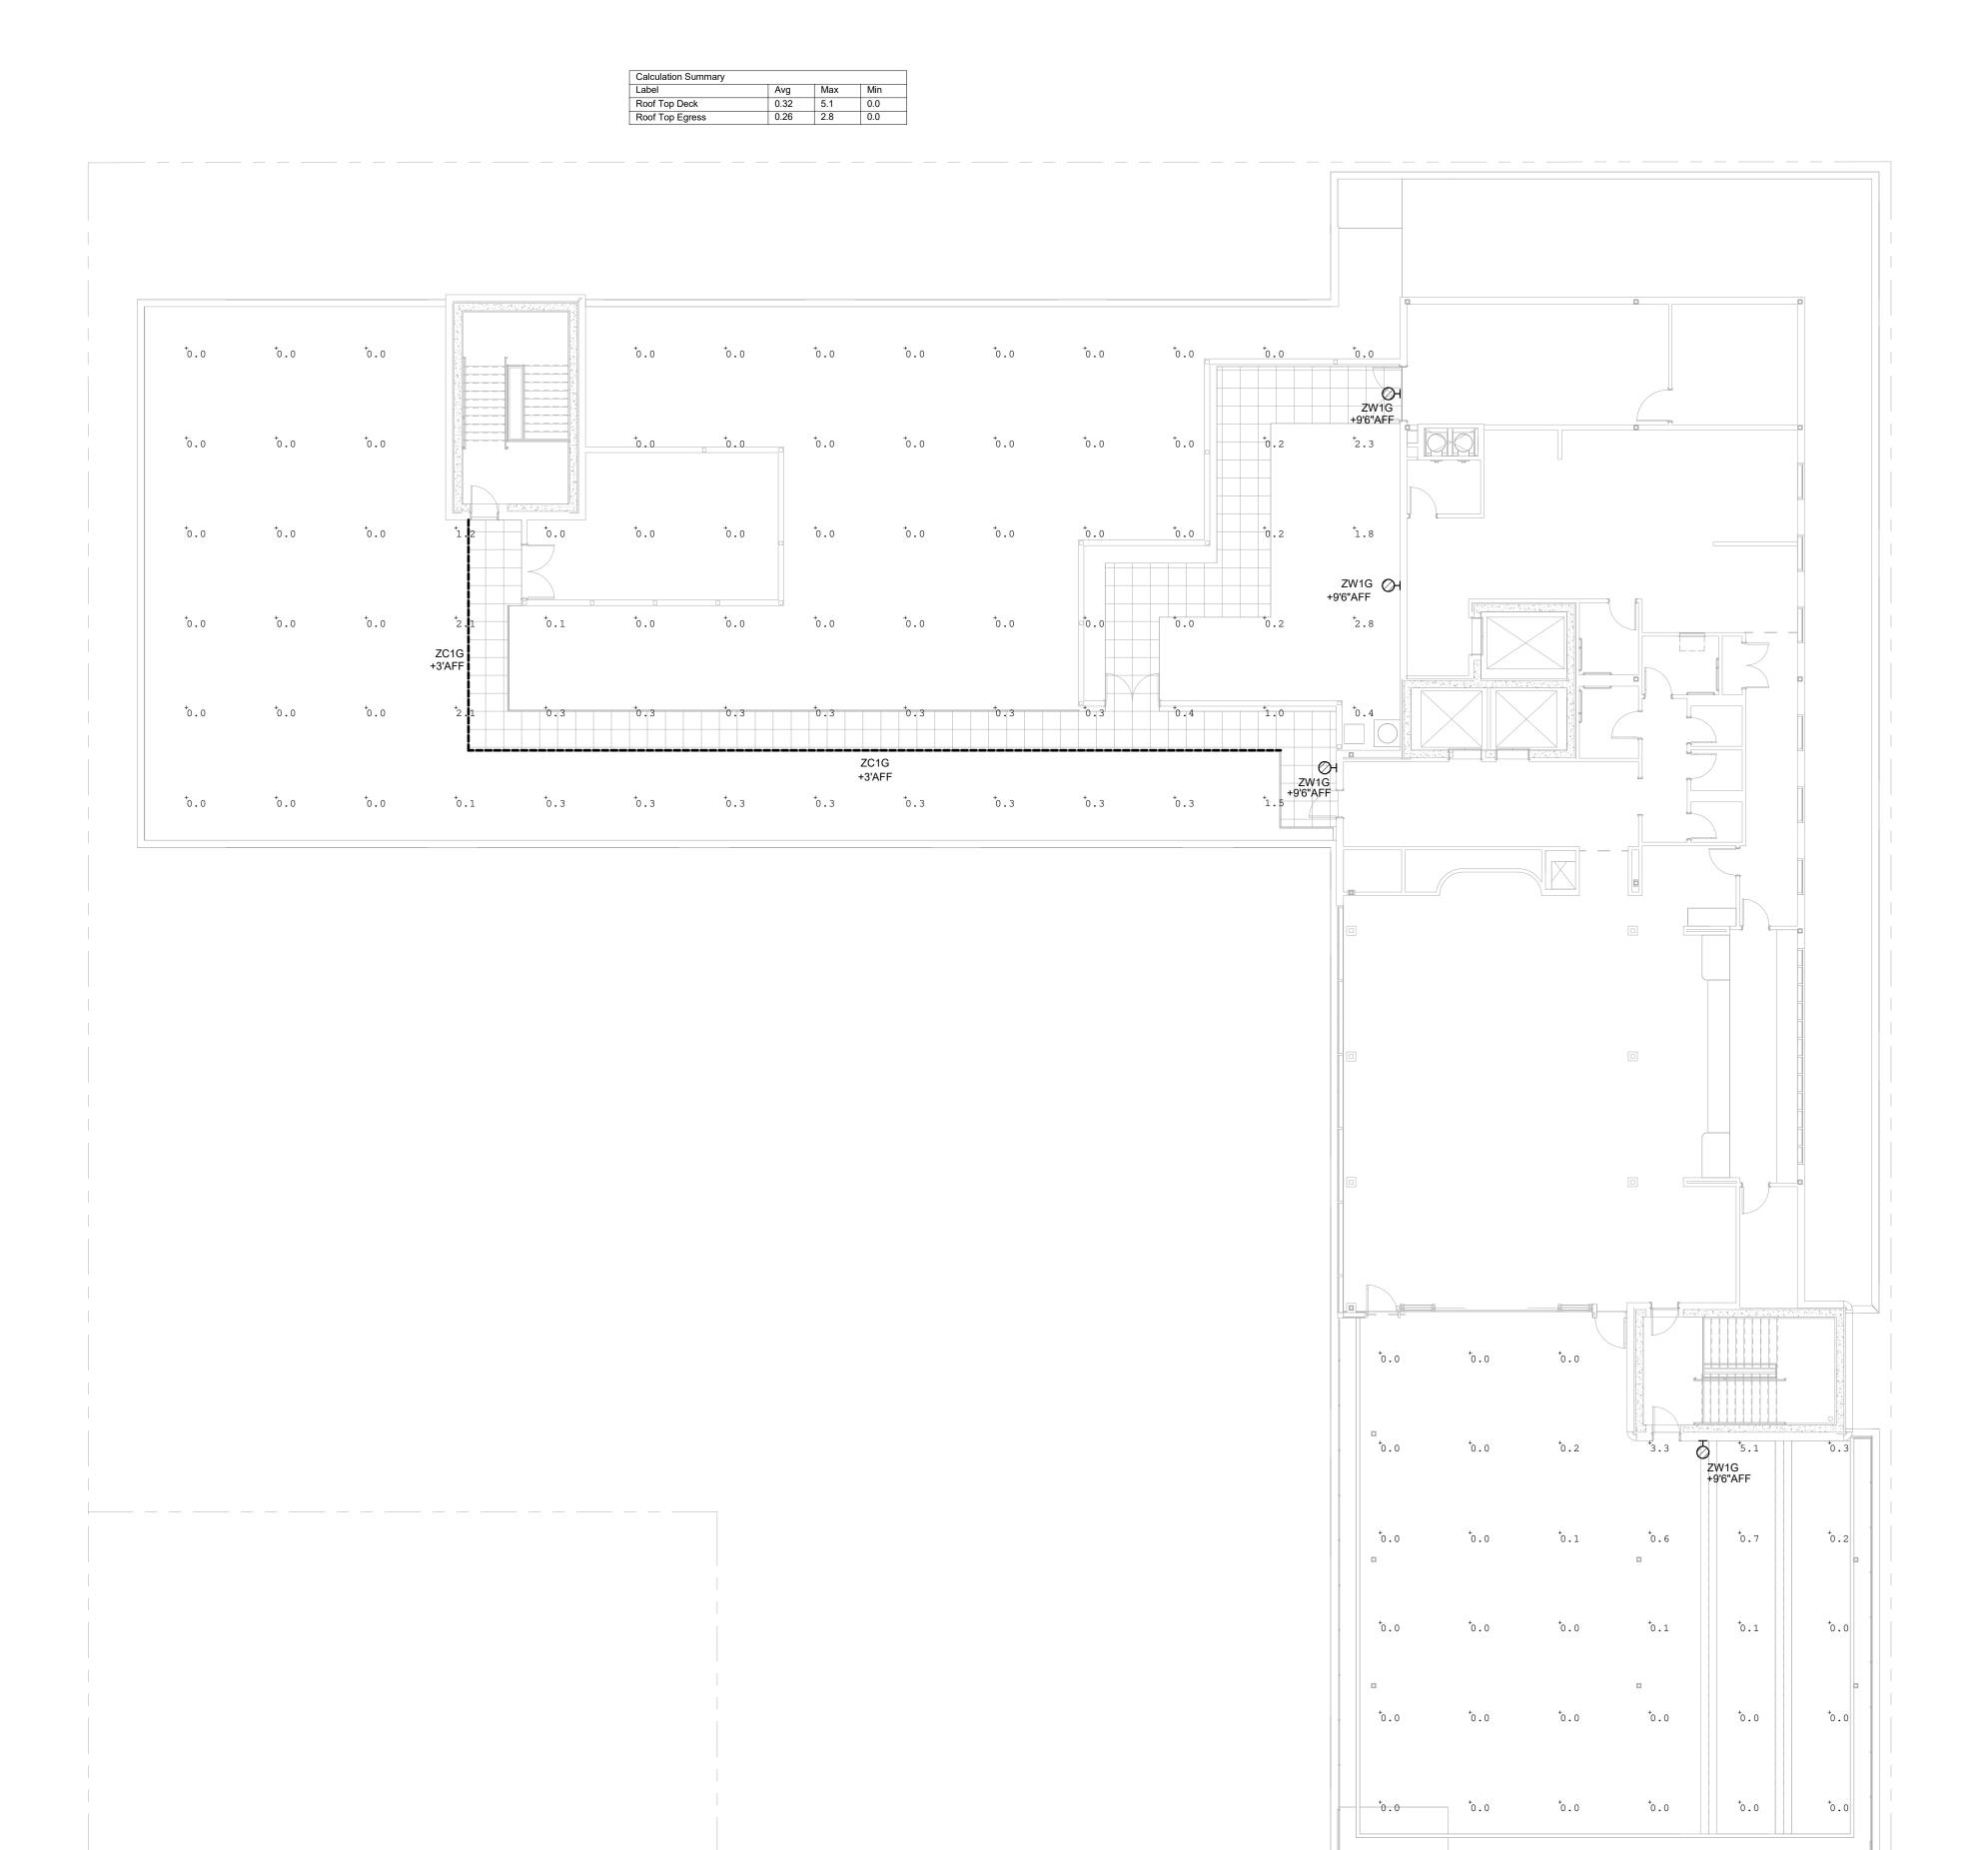


NOTES:

- 1. CALCULATION POINTS ARE BASED ON A 10' X 10'
- 2. LIGHT TRESPASS CALCULATIONS POINTS ARE BASED ON A 5' ON CENTER SPACING AT A HEIGHT OF 3'-0" ABOVE FINISH GROUND.
- 3. ALL ILLUMINANCE VALUES IN CALCULATION GRID ARE SHOWN AT GRADE AND WERE CALCULCATED USING A LIGHT LOSS FACTOR OF
- 4. PER CITY OF COLORADO SPRINGS UDC CODE SECTION 7.4.1203.C.1: ALL LIGHTING FIXTURES SHALL BE INSTALLED SO THAT LIGHT TRESPASS SHALL BE INSTALLED SO THAT LIGHT TRESPAS FROM ANY PROPERTY LINE, EXCEPT A PROPERTY LINE ADJACENT TO A PUBLIC STREET, SHALL NOT EXCEED ONE (1) FOOTCANDLE AT THE PROPERTY LINE. IT IS ASSUMED THE ALLEY TO THE NORTH IS A PUBLIC STREET IN ADDITION TO S. CASCADE AVE. AND W. MORENO AVE. AVE. AND W. MORENO AVE.
- ALL LIGHTS ARE AIMED DOWN TO REDUCE GLARE BEYOND THE PROPERTY LINE. REFER TO LUMINAIRE SCHEDULE FOR BUG RATINGS.
- 6. ALL EXTERIOR LIGHTING TO BE CONTROLLED ACCORDING TO 2021 IECC REQUIREMENTS.

FOR CITY USE:

CITY FILE NUMBER

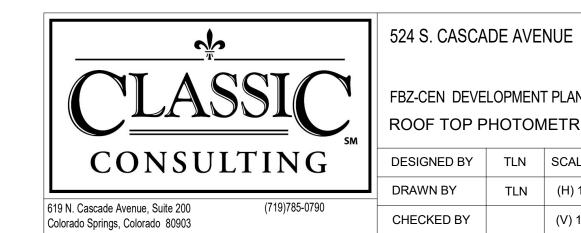



FBZ-CEN DEVELOPMENT PLAN ROOF TOP PHOTOMETRIC


DESIGNED BY TLN SCALE DRAWN BY CHECKED BY (V) 1"= N/A JOB NO. 2539.66

ROOF TOP PHOTOMETRIC PLAN


SCALE: 3/32" = 1'-0"

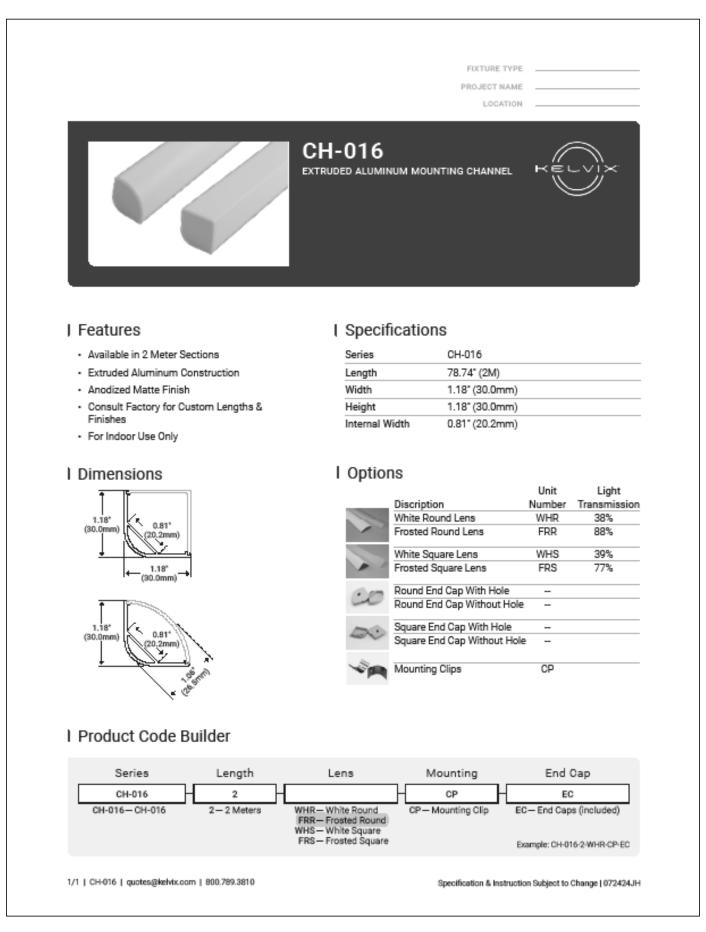

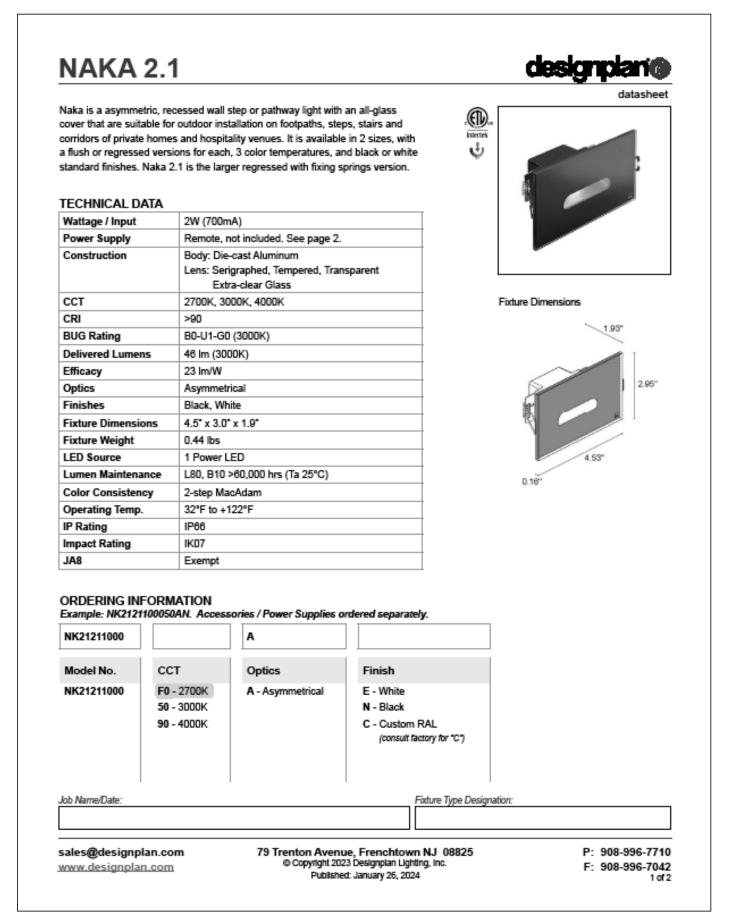


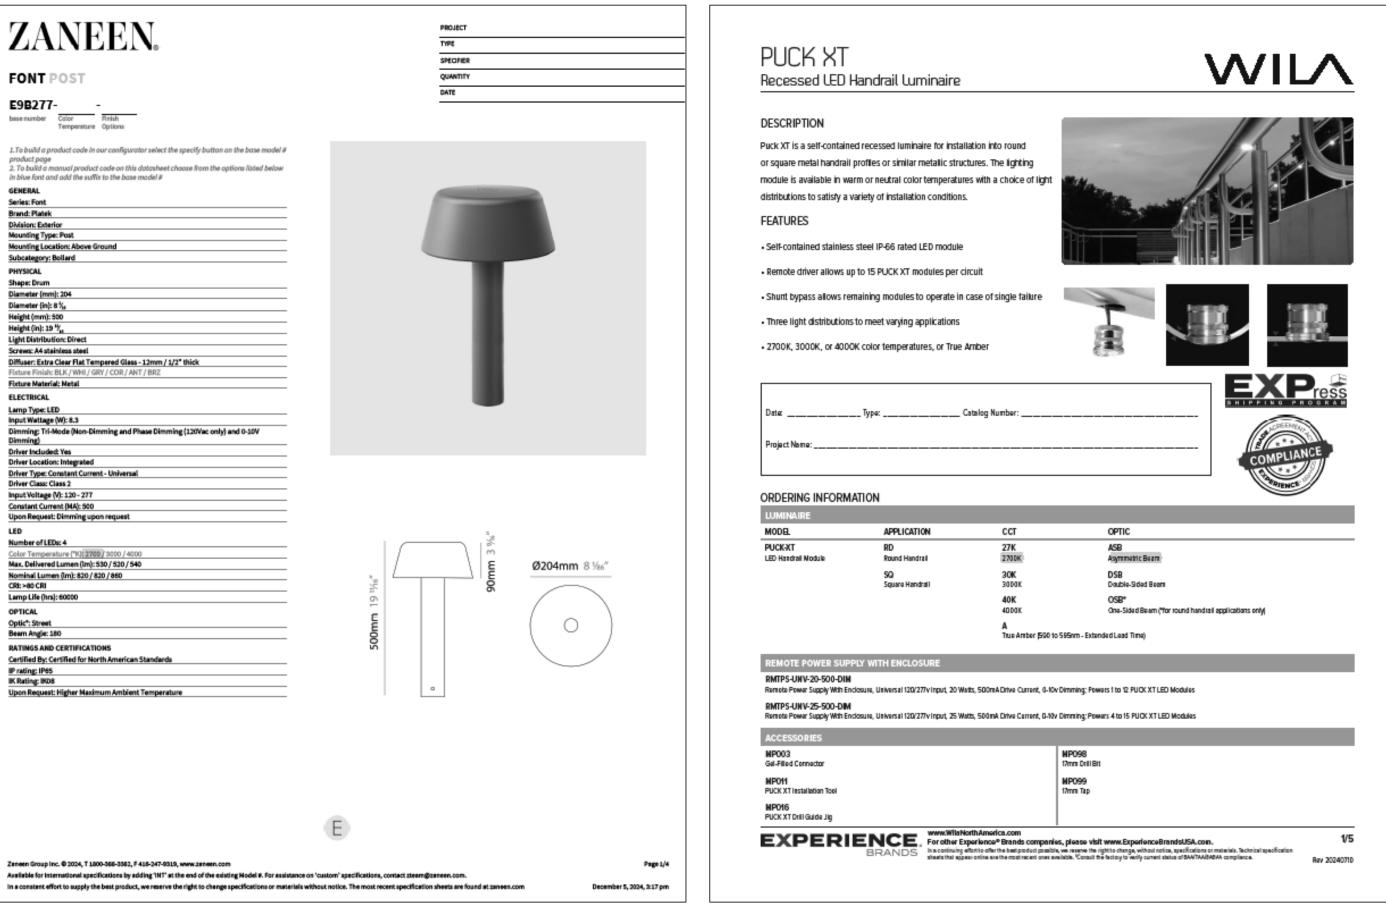



TYPE X04 TYPE X03 TYPE X02

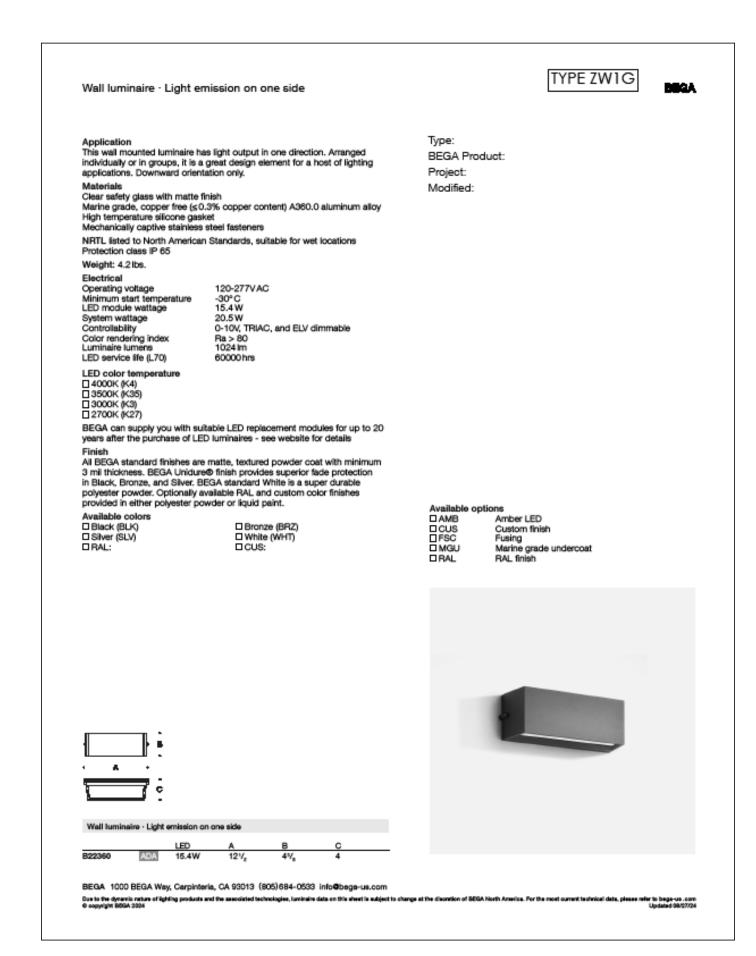

TYPE ZW1G

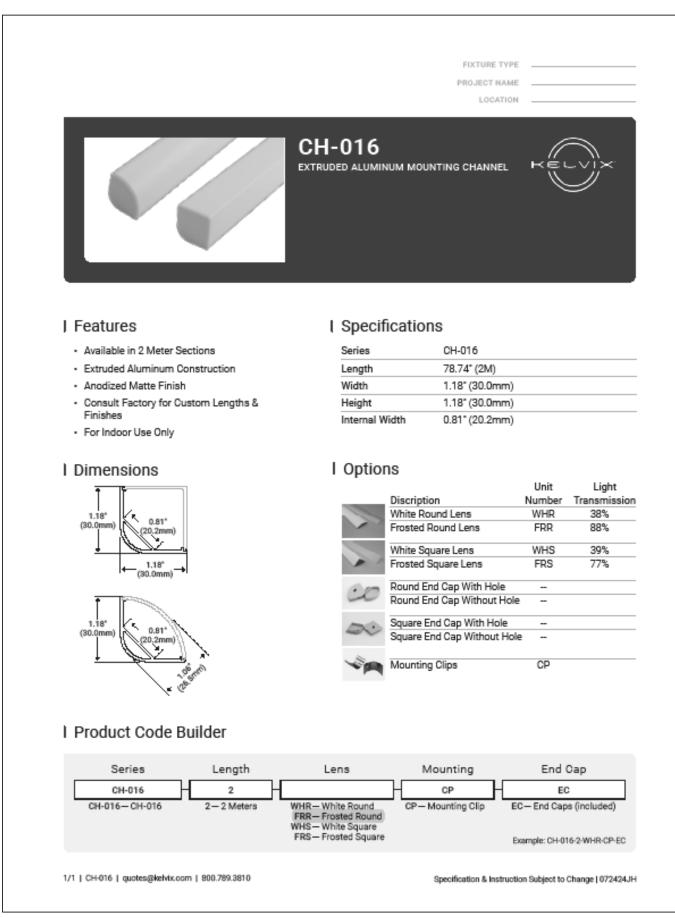

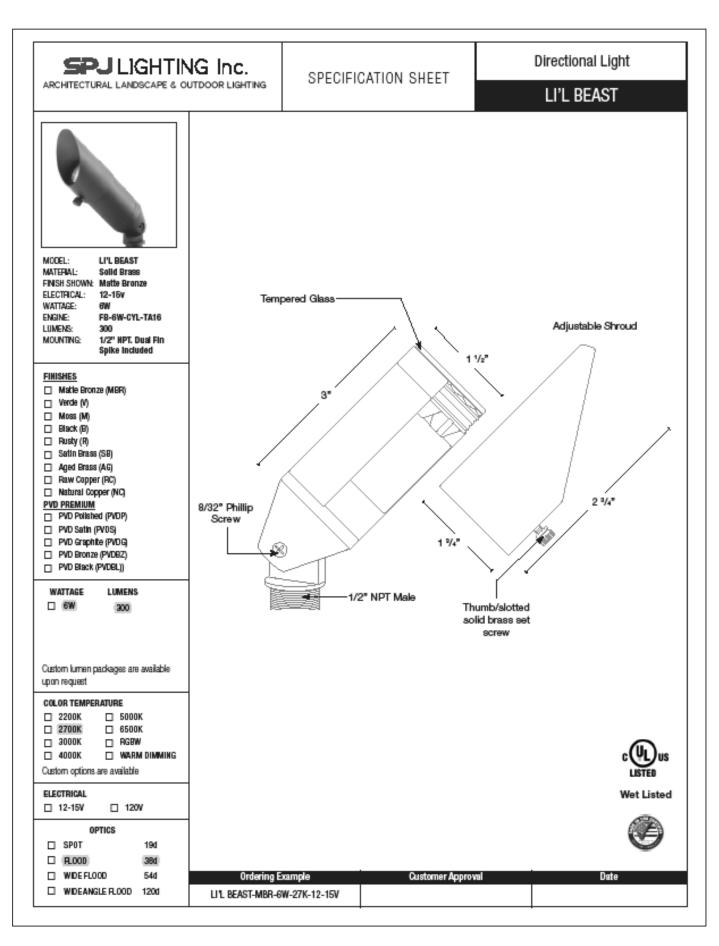

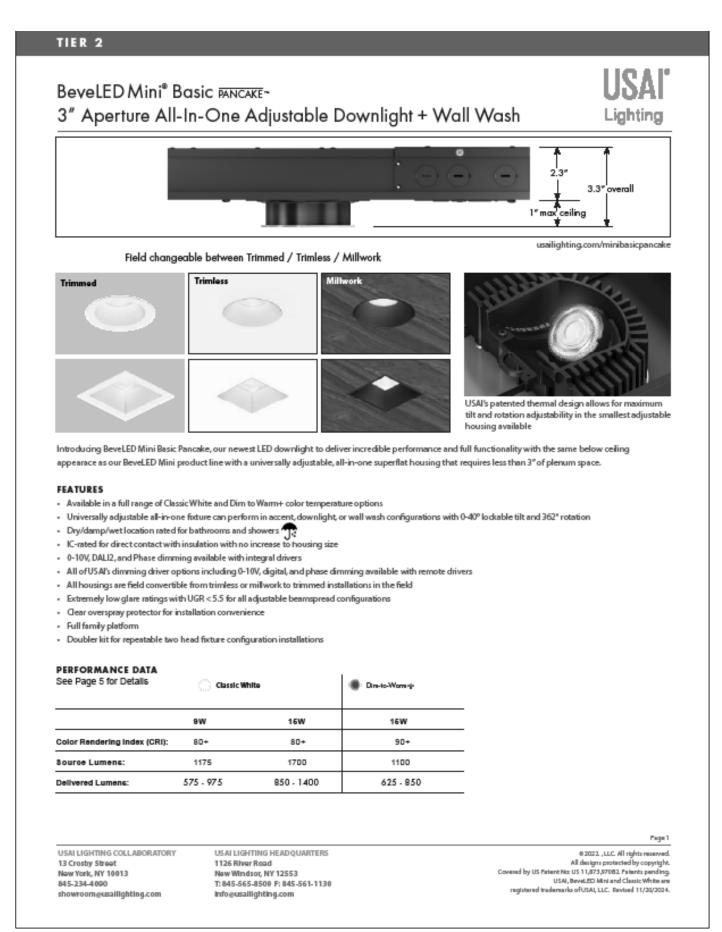

TYPE X01

TYPE X07

TYPE X06

TYPE X06

S24 S. CASCADE AVENUE

S24 S. CASCADE AVENUE



FOR CITY USE: