

N.E.S. Inc.
619 N. Cascade Avenue, Suite 200
Colorado Springs, CO 80903
Tel. 719.471.0073
Fax 719.471.0267
www.nescolorado.com
© 2012. All Rights Reserved.

PLANNER / LANDSCAPE ARCHITECT

ASSOCIATION WITH

KALEIDOS

DEVELOPMENT PLAN

MURRAY BLVD & PULSAR DRIVE
DATE: 10/30/2020
PROJECT MGR: A. BARLOW
PREPARED BY: B. SWENSON

SCALE

ISSUE INFO

DATE	BY	DESCRIPTION
12/18/2020	JBS	PER CITY COMMENTS
1/14/2021	JBS	PER CITY COMMENTS

ISSUE / REVISION

SHEET TITLE

COVER

SHEET NUMBER

1 OF 14

PLAN FILE # CPC DP 20-00152


KALEIDOS

LOT 2 ATLAS PREPARATORY CHARTER SCHOOL FILING NO.1B

CITY OF COLORADO SPRINGS, COLORADO

DEVELOPMENT PLAN

VICINITY MAP

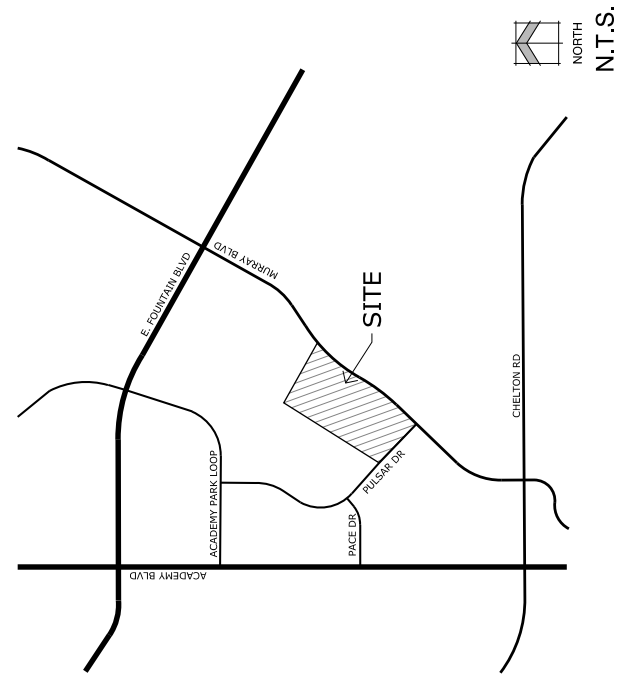

NORTH
N.T.S.

GENERAL NOTES

- SIGNAGE IS NOT APPROVED WITH THIS PLAN. A SEPARATE SIGN PERMIT IS REQUIRED. CONTACT THE DEVELOPMENT REVIEW DIVISION FOR SIGNAGE REQUIREMENTS.
- ALL LIGHTING FIXTURES SHALL HAVE FULL CUT-OFF SHIELDING OR FIXTURES TO REDUCE OFF-SITE LIGHTING IMPACTS.
- SCHOOL AND PARK FEES WILL BE PAID IN LIEU OF LAND DEDICATION.
- ALL COMMON AREAS INCLUDING LANDSCAPING WILL BE OWNED AND MAINTAINED BY THE PROPERTY OWNER.
- ALL PRIVATE TRAFFIC SIGNAGE SHALL BE IN CONFORMANCE WITH MUTCD GUIDELINES AND INSTALLED BY THE DEVELOPER.
- FIRE APPARATUS ACCESS ROADS SHALL BE DESIGNED AND MAINTAINED TO SUPPORT THE IMPOSED LOADS OF FIRE APPARATUS AND SHALL BE SURFACED SO AS TO PROVIDE ALL WEATHER DRIVING CAPABILITIES. PRIVATE ROADS WILL BE BUILT TO MEET A MINIMUM OF 27000LBS SINGLE AXLE WEIGHT AND 75000LB TOTAL APPARATUS WEIGHT.
- PRIOR TO CERTIFICATE OF OCCUPANCY, THE DEVELOPER SHALL BE RESPONSIBLE FOR VERIFYING FIRE LANE MARKING INSTALLATION SHALL BE IN ACCORDANCE WITH THE CITY OF COLORADO SPRINGS FIRE DEPARTMENT REQUIREMENTS.
- THE DEVELOPER WILL BE REQUIRED TO DEDICATE 15' OF RIGHT-OF-WAY ON THE WEST END OF THE COMMERCIAL/OFFICE PARCEL FRONTING HAWCOCK EXPRESSWAY.
- ALL SIDEWALKS SHOWN ON THE DEVELOPMENT PLAN ARE TO BE 5' CONCRETE UNLESS OTHERWISE SPECIFIED.
- ALL EXISTING CURB, GUTTER, PEDESTRIAN RAMPS AND CROSSPANS POSING A SAFETY HAZARD, DAMAGED, EXHIBITING EXCESSIVE DETERIORATION OR NOT MEETING CURRENT CITY ENGINEERING STANDARDS ALONG PUBLIC STREETS ADJACENT TO THE SITE WILL NEED TO BE REMOVED AND REPLACED PRIOR TO ISSUING THE CERTIFICATE OF OCCUPANCY (C.O.). AN ON SITE MEETING CAN BE SET UP WITH THE ENGINEERING DEVELOPMENT REVIEW INSPECTOR TO DETERMINE WHAT, IF ANY, IMPROVEMENTS ARE REQUIRED.
- THE INSPECTOR CAN BE REACHED AT 719-385-5977.
- ALL IMPROVEMENTS WITHIN THIS SUBDIVISION IS SUBJECT TO AVIGATION EASEMENTS AS RECORDED AT RECEPTION NOS. 215070621 & 215070622.
- THIS PROPERTY IS NOT SUBJECT TO THE FINDINGS, SUMMARY AND CONCLUSIONS OF A GEOLOGIC HAZARD REPORT. A GEOLOGIC HAZARD WAIVER WAS APPROVED FOR THIS SITE.
- STREET TREES, STREETSCAPE IMPROVEMENTS, AND VEGETATION WITHIN THE CITY ROW SHALL BE MAINTAINED BY THE ABUTTING PROPERTY OWNER.

ADA NOTE

THE PARTIES RESPONSIBLE FOR THIS PLAN HAVE FAMILIARIZED THEMSELVES WITH ALL CURRENT ACCESSIBILITY CRITERIA AND SPECIFICATIONS AND THE PROPOSED PLAN REFLECTS ALL SITE ELEMENTS REQUIRED BY THE APPLICABLE ADA DESIGN STANDARDS AND GUIDELINES AS PUBLISHED BY THE UNITED STATES DEPARTMENT OF JUSTICE. APPROVAL OF THIS PLAN BY THE CITY OF COLORADO SPRINGS DOES NOT ASSURE COMPLIANCE WITH THE ADA OR ANY OTHER FEDERAL OR STATE ACCESSIBILITY LAWS OR ANY REGULATIONS OR GUIDELINES ENACTED OR PROMULGATED UNDER OR WITH RESPECT TO SUCH LAWS. SOLE RESPONSIBILITY FOR COMPLIANCE WITH FEDERAL AND STATE ACCESSIBILITY LAWS LIES WITH THE PROPERTY OWNER.


FEMA FLOODPLAIN NOTE

FLOODPLAIN STATEMENT: THIS SITE IS NOT WITHIN A DESIGNATED F.E.M.A. FLOODPLAIN AS DETERMINED BY THE FLOOD INSURANCE RATE MAP NUMBER 08041C0742 G. EFFECTIVE DECEMBER 7, 2018.


LEGAL DESCRIPTION

LOT 2, ATLAS PREPARATORY CHARTER SCHOOL FILING NO. 1B
CONTAINING A CALCULATED AREA OF 414,384 SQUARE FEET (9.51 ACRES), MORE OR LESS.


ADA VAN PARKING STALL LAYOUT

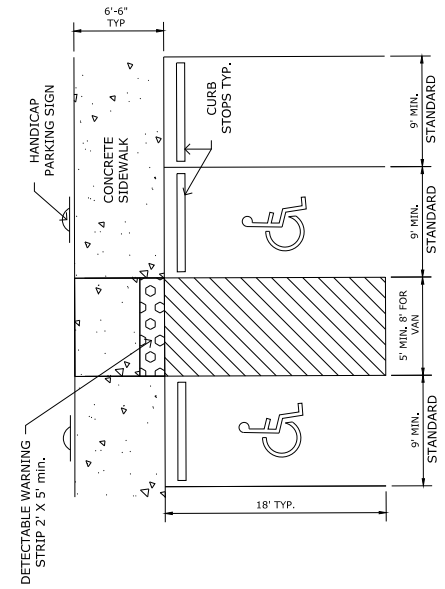

ADA / VAN ACCESSIBLE PARKING SIGNS

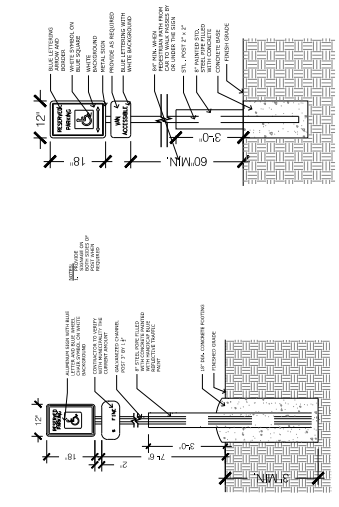

STANDARD CURB RAMP DETAIL

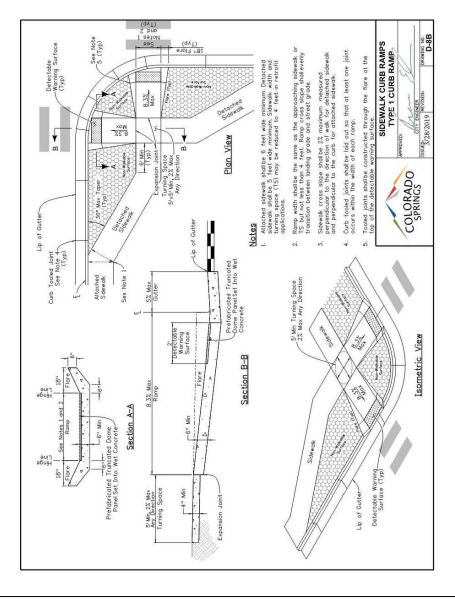

DWELLING UNIT TOTALS

BUILDING TYPE	# of Bldgs	Studio	1BR	2BR	3BR	4BR	Area per Building
Building C (5-PLEX)	25	1	2	2			5620
Building E (5-PLEX Large)	5	1	2	1	1		5735
	30	0	30	60	55	5	169175

PARKING CALCULATIONS

1 BEDROOMS: 30 UNITS (1.5) = 45 SPACES
2 BEDROOMS: 60 UNITS (1.7) = 102 SPACES
3 BEDROOMS: 55 UNITS (2) = 110 SPACES
4 BEDROOMS: 5 UNITS (2) = 10 SPACES
TOTAL SPACES REQUIRED: 267
ADA REQUIRED: 9 SPACES (2 VAN ACCESSIBLE)
ADA PROVIDED: 12 SPACES (6 VAN ACCESSIBLE)
TOTAL PARKING SPACES PROVIDED: 271

SHEET INDEX

Sheet	Description
Sheet 1 of 14:	Cover
Sheet 2 of 14:	Development Plan
Sheet 3 of 14:	Preliminary Grading Plan
Sheet 4 of 14:	Preliminary Utility Plan
Sheet 5 of 14:	Preliminary Landscape Plan
Sheet 6 of 14:	Preliminary Landscape Detail
Sheet 7 of 14:	Building Elevations
Sheet 8 of 14:	Building Elevations
Sheet 9 of 14:	Building Elevations
Sheet 10 of 14:	Building Elevations
Sheet 11 of 14:	Building Elevations
Sheet 12 of 14:	Building Elevations
Sheet 13 of 14:	Photometric Plan
Sheet 14 of 14:	Light Fixture Details

DEVELOPMENT PLAN

- GRADING LEGEND**
- 5902. EXISTING CONTOUR MINOR
 - 5910. EXISTING CONTOUR MAJOR
 - 5902. PROP. CONTOUR MINOR
 - 5910. PROP. CONTOUR MAJOR
 - LIMITS OF GRADING
 - DIRECTION OF SURFACE FLOW
 - HIGH POINT
 - LOW POINT
 - FINISHED FLOOR ELEVATION
 - BLDG 16 TYPE 'C'



ATLAS PREPARATORY CHARTER SCHOOL FILING No. 1A
LOT 1
693,118 SQUARE FEET

LOT 1
ATLAS PREPARATORY CHARTER SCHOOL FILING No. 1A
(REC. No. 215713654)

LOT 1
AIRPORT SQUARE SUBDIVISION FILING No. 4
(REC. No. 201018814)

MURRAY BOULEVARD
(80' PUBLIC R.O.W.)
(PLAT BOOK 0-3, PAGE 78)

LOT 1
ELITE BUSINESS PARK SUBDIVISION FILING No. Z
(REC. No. 99078426)

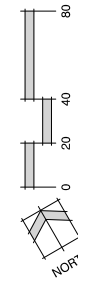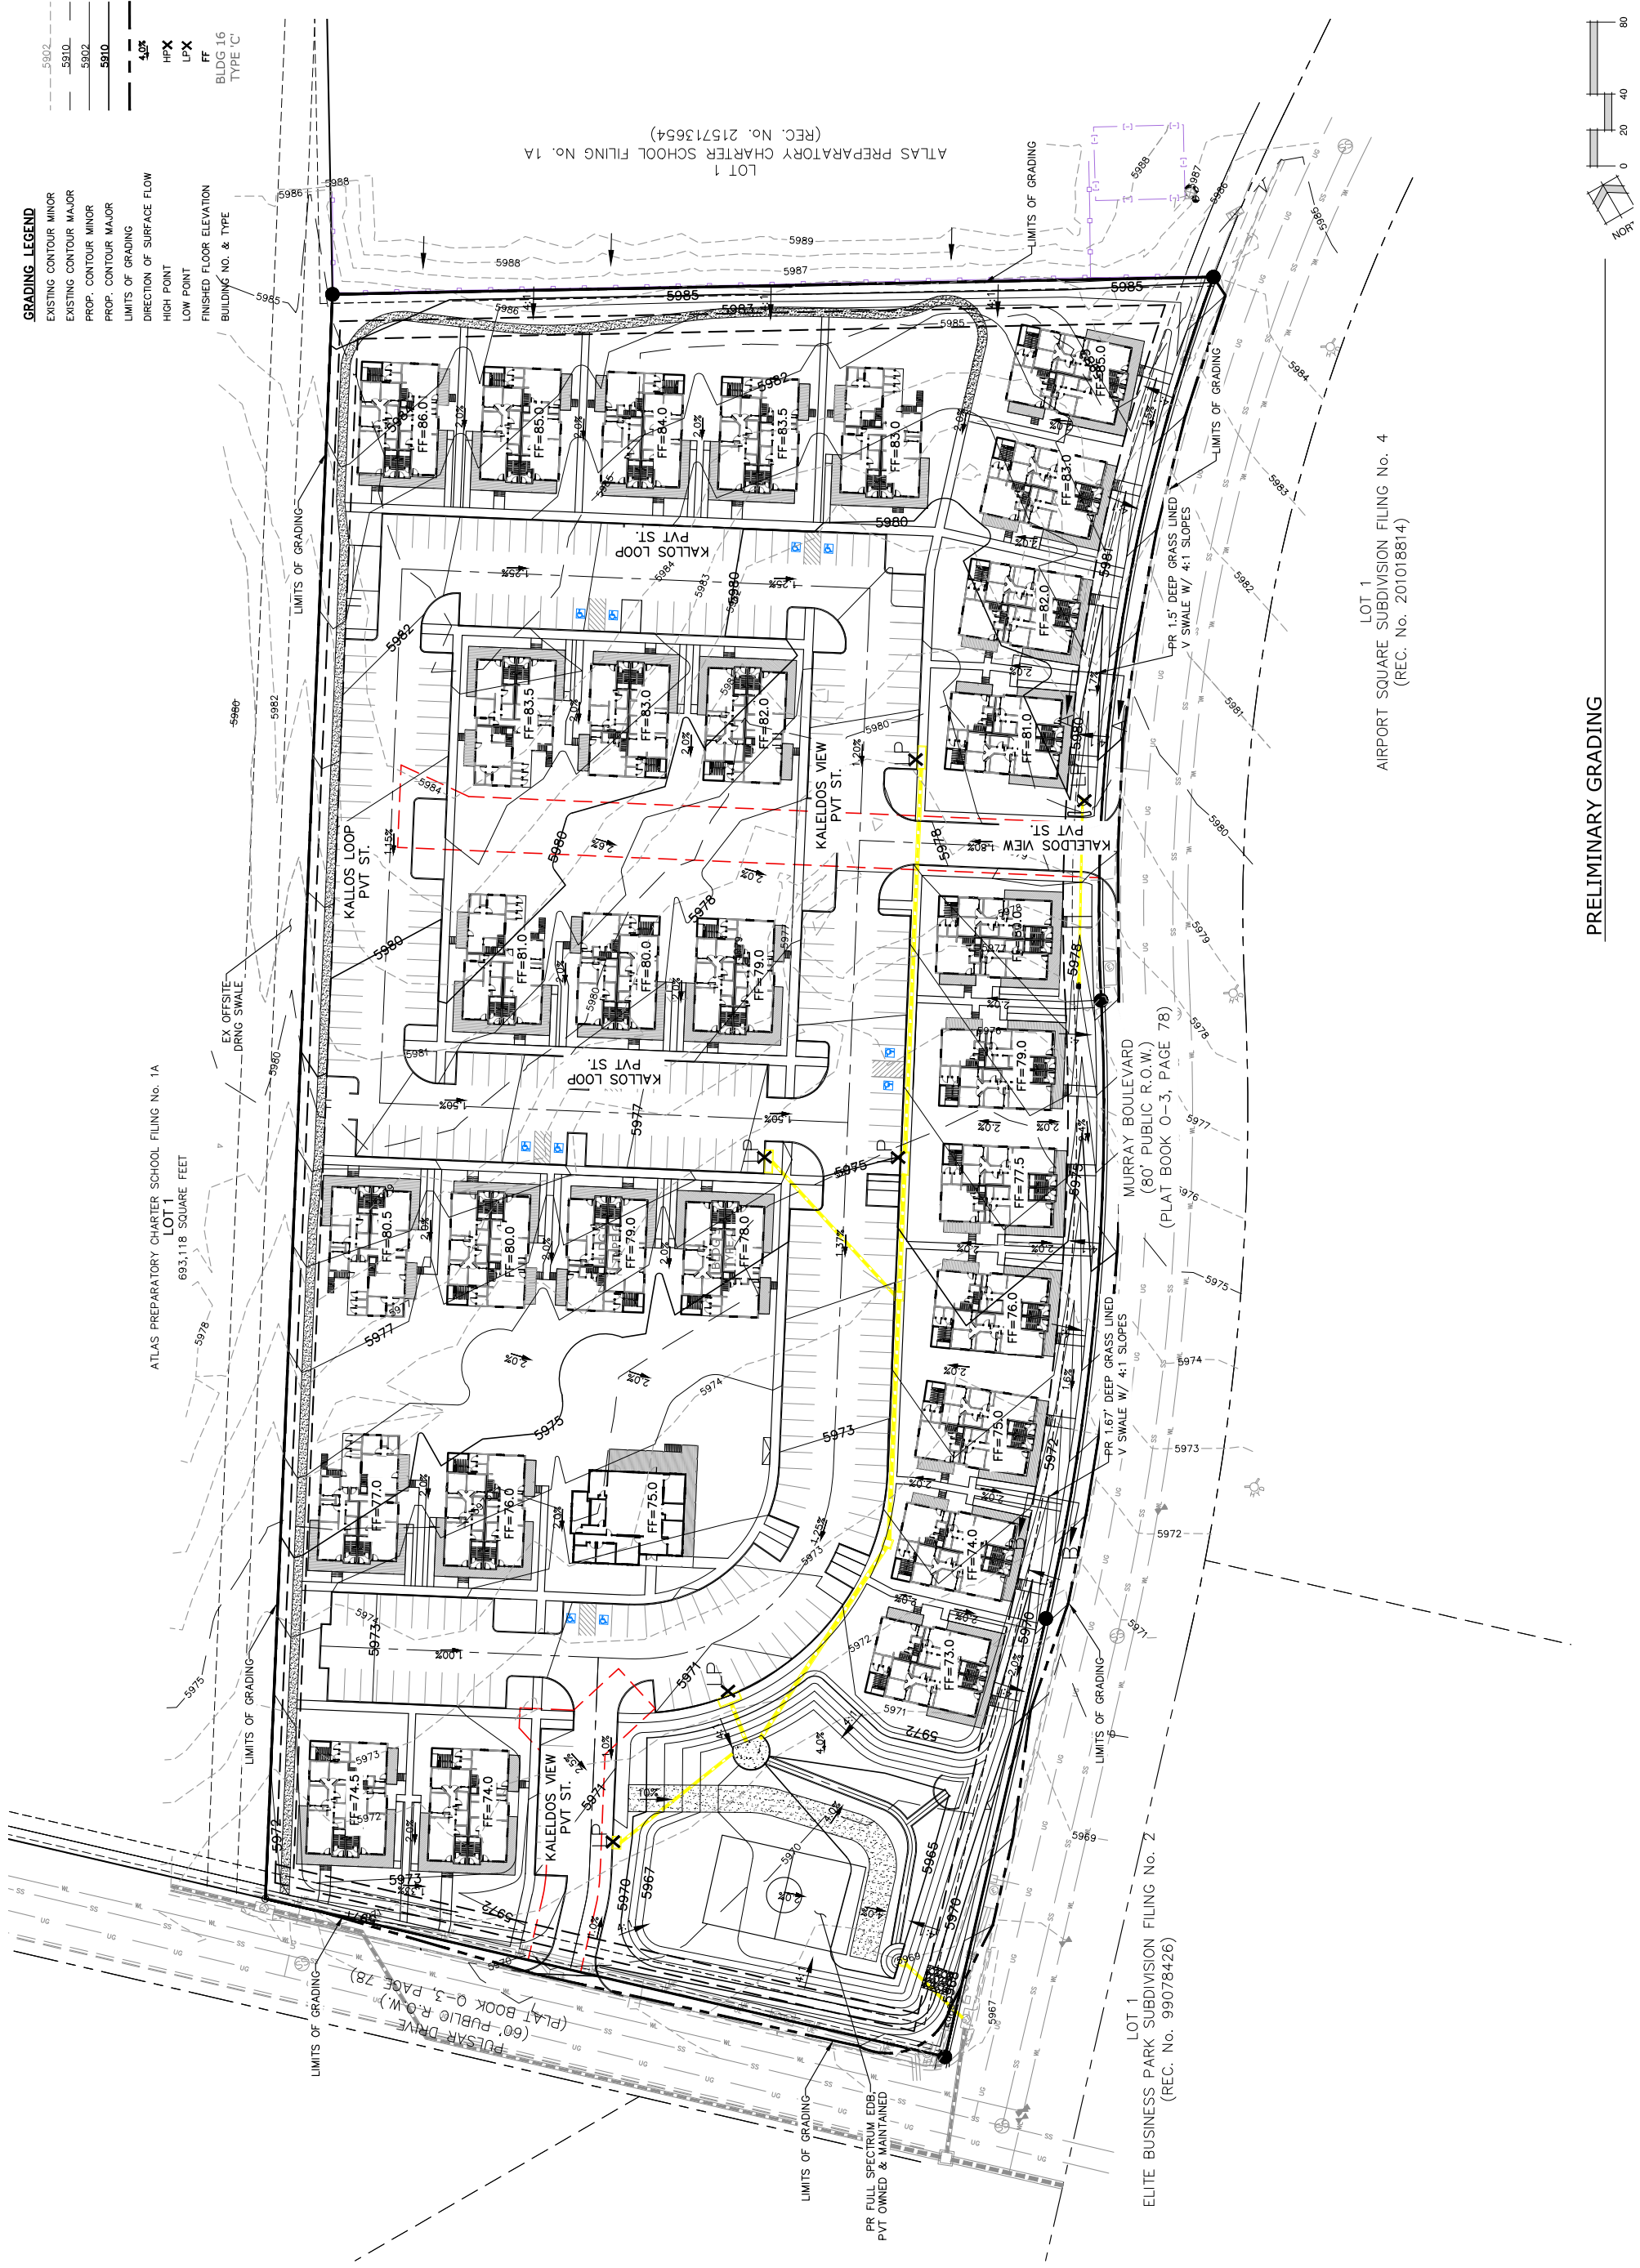

KALEIDOS

CITY OF COLORADO SPRINGS, COLORADO PRELIMINARY LANDSCAPE PLAN

Land Planning
Landscape
Architecture
Urban Design



N.E.S. Inc.
619 N. Cascade Avenue, Suite 200
Colorado Springs, CO 80903

Tel. 719.471.0073
Fax 719.471.0267

www.niescolorado.com

© 2012. All Rights Reserved.

PLANNER / LANDSCAPE ARCHITECT

KALEIDOS

DEVELOPMENT PLAN

MURRAY BLVD &
PULSAR DRIVE

DATE: 10/30/2020
PROJECT INGR: A. BARLOW
PREPARED BY: B. SWENSON & B. ITEN

DATE: 12/18/2020
BY: JBS
DESCRIPTION: PER CITY COMMENTS

DATE: 1/15/2021
BY: JBS
DESCRIPTION: PER CITY COMMENTS

PRELIMINARY LANDSCAPE PLAN


5 OF 14

CPC DP 20-00152



CONCEPT_PLANT_SCHEDULE

Plant Type	Quantity	Material
DECIDUOUS SHADE	91	BLUEGRASS SOD
EVERGREEN LARGE	13	NATIVE SEED
EVERGREEN COLUMNAR	65	MULCH PLANTING BED
ORNAMENTAL	51	ROCK MULCH
EVERGREEN SMALL	25	COBBLE
		73,879 sf
		36,974 sf
		22,098 sf
		42,770 sf
		1,408 sf

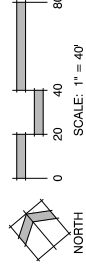

DEVELOPMENT PLAN


LANDSCAPE NOTES

- SOIL AMENDMENT - INCORPORATE 1 CUBIC YARD(S) OF AREA OF "PREMIUM 3 ORGANIC COMPOST" OR APPROVED COMPOST, BLENDERS, MULCHES, OR FERTILIZERS TO ALL NATIVE SEED AREAS. TILL INTO TOP 8" OF SOIL. FOR PLANTING PIT AMENDMENTS, (DECOMPOSED MANURE) TO ALL NATIVE SEED AREAS. TILL INTO TOP 8" OF SOIL. FOR PLANTING PIT AMENDMENTS, SEE LANDSCAPE DETAILS. FERTILIZER REQUIREMENTS ARE TO BE BASED ON SOIL ANALYSIS.
- RECOMMENDED SOIL AMENDMENT: TR-MIX III as supplied by C&C Sand - to be applied as backfill in planting pits
- CONTRACTOR TO UTILIZE STOCKPILED TOPSOIL FROM GRADING OPERATION AS AVAIL. TILL INTO TOP 8" OF SOIL. FOR GRADING PLAN, REFER TO CIVIL ENGINEER'S DRAWINGS.
- A FULLY AUTOMATED SPRINKLER IRRIGATION SYSTEM WILL DRIP IRRIGATE ALL TREE, SHRUB, AND GROUND COVER PLANTING AREAS AND SPRAY ANY TURF. IRRIGATION PLAN WILL INCLUDE AN IRRIGATION SCHEDULE THAT NOTES PLANTING AND MAINTENANCE SCHEDULES. IRRIGATION SYSTEM SHALL BE DESIGNED TO PROVIDE 1.0" OF WATER PER WEEK TO ALL PLANTS AND GENERAL RECOMMENDATIONS REGARDING SEASONAL ADJUSTMENTS (SPRING AND FALL).
- NATIVE SEED AREAS TO USE SEED MIX SPECIFIED. ALL SEED AREAS SHALL BE IRRIGATED UNTIL ESTABLISHMENT. SUBMIT SEED MIX PRODUCT INFORMATION TO J.A. FOR APPROVAL PRIOR TO INSTALLATION.
- ALL PLANTS AND TREES NOT INSTALLED IN PLANTING BEDS TO RECEIVE 3" DEPTH WOOD MULCH RING UNLESS OTHERWISE SPECIFIED. MULCH RINGS TO BE SIZED PER PLANTING DETAILS.
- SOIL SHALL BE KENTUCKY BLUEGRASS BLEND.
- ALL PLANTS AND TREES TO BE SEPARATED BY SOLID STEEL EDGING. ALL SHRUB BEDS TO BE ENCLOSED BY STEEL EDGING. SEPARATION BETWEEN SOIL AND NATIVE SEED, AND BETWEEN ALTERNATIVE TURF AND NATIVE SEED SHALL BE A NEEDED STRIP, WITH APPLICABLE SUPPORT MATERIAL. MAY BE SUBMITTED AT DISCRETION OF ARCHITECT. ALL PLANTS AND TREES TO BE SEPARATED BY SOLID STEEL EDGING. SEPARATION BETWEEN SOIL AND NATIVE SEED, AND BETWEEN ALTERNATIVE TURF AND NATIVE SEED SHALL BE A NEEDED STRIP, WITH APPLICABLE SUPPORT MATERIAL. MAY BE SUBMITTED AT DISCRETION OF ARCHITECT.
- A FINAL LANDSCAPE PLAN AND AN IRRIGATION PLAN, WITH APPLICABLE SUPPORT MATERIAL, MAY BE SUBMITTED AT DISCRETION OF ARCHITECT. ALL PLANTS AND TREES TO BE SEPARATED BY SOLID STEEL EDGING. SEPARATION BETWEEN SOIL AND NATIVE SEED, AND BETWEEN ALTERNATIVE TURF AND NATIVE SEED SHALL BE A NEEDED STRIP, WITH APPLICABLE SUPPORT MATERIAL. MAY BE SUBMITTED AT DISCRETION OF ARCHITECT.
- INSPECTION AND APPROVAL: NOTIFICATION FOR IRRIGATION INSPECTION AFFIDAVIT SHALL BE GIVEN DURING CONSTRUCTION WHILE TRENCH IS OPEN AND AFTER COMPLETION OF SYSTEM INSTALLATION PRIOR TO SEEDING OR SODDING. THE LANDSCAPE ARCHITECT SHALL BE NOTIFIED AT LEAST 48 HOURS PRIOR TO CLIENT SEEKING INSPECTION AND APPROVAL. ANY FIELD CHANGES OR DEVIATIONS TO THESE PLANS WITHOUT PRIOR CITY APPROVAL OF AN AMENDED DEVELOPMENT PLAN MAY RESULT IN A DELAY OF FINAL APPROVAL AND ISSUANCE OF A CERTIFICATE OF OCCUPANCY.
- THESE PLANS ARE FOR CITY APPROVALS ONLY AND ARE NOT TO BE UTILIZED FOR CONSTRUCTION.
- ALL FIRE DEPARTMENT CONNECTIONS (FDC) SHALL NOT BE VISUALLY OR PHYSICALLY OBSTRUCTED BY LANDSCAPING.
- ALL TREES TO BE STAKED FOR A MINIMUM OF 18 MONTHS. REMOVE STAKING MATERIALS ONCE TREE IS ESTABLISHED, WHICH MAY DEPEND ON TREE SPECIES, MATURITY AND SITE CONDITIONS.

PRELIMINARY PLANT SCHEDULE

QTY, SYM., Scientific Name	Common Name	Size	Appendix Key	Mature Width	Notes
DECIDUOUS TREES					
-- AF	Acer x freemanii 'Jefferson'	2.5" cal. S	30-40'	8" B&B	
-- AM	Amelanchier laevis 'Spiring Flurry'	2.5" cal. 45A	30-40'	8" B&B	
-- GW	Gleditsia triacanthos inermis 'Impatiens'	2.5" cal. 45A	30-40'	8" B&B	
-- PM	Populus x albertiana	2.5" cal. 479A	30-40'	8" B&B	
-- QR	Quercus rubra	2.5" cal. 45	40-60'	8" B&B	
-- QR	Koeleria paniculata	2.5" cal. S	30-40'	8" B&B	
-- TA	Tilia americana	2.5" cal. 4S	30'	8" B&B	
ORNAMENTAL TREES					
-- AA	Acer ginnala 'Flame'	2" cal. 457A	20'	8" B&B	
-- AS	Amelanchier laevis 'Spiring Flurry'	2.5" cal. 479S	20'	8" B&B	
-- CI	Crataegus crus-galli 'Tremis'	2" cal. 235AD	15-20'	8" B&B	
-- MI	Malus sp. 'Indian Summer'	2.5" cal. 467S	20'	8" B&B	
EVERGREEN TREES					
-- AC	Abies concolor	8" Ht.	45/78SA	20-30'	8" B&B
-- PE	Pinus edulis	8" Ht.	1258D	10-20'	8" B&B
-- PF	Pinus flexilis	8" Ht.	568DA	10-20'	8" B&B
-- PP	Pinus ponderosa	8" Ht.	2678D	30-40'	8" B&B
-- PPG	Picea pungens glauca	8" Ht.	678S	20-30'	8" B&B
-- JSG	Juniperus scopulorum 'Skyrocket'	6" Ht.	125878D	2-3'	8" B&B
-- PON	Picea glauca 'North Star'	6" Ht.	W	3-4'	8" B&B
Signature Trees: -- -- -- % Signature Trees Total No. of Trees: (60% minimum - Policy 311.1x)					
EVERGREEN SHRUBS					
-- ACP	Acrostaphylos x coloradensis 'Panchito'	5 GAL.	5678DA	4-5'	CONT.
-- JBC	Juniperus horizontalis 'Blue Chip'	5 GAL.	2568A	8'	CONT.
-- JBR	Juniperus sibirica 'Broadmoor'	5 GAL.	568A	8'	CONT.
-- JSG	Juniperus scopulorum 'Gray Gleam'	5 GAL.	125878D	6'	CONT.
-- PMH	Pinus mugo 'Mops'	5 GAL.	1258D	3'	CONT.
DECIDUOUS SHRUBS					
-- BR	Berberis thunbergii 'Rose Glow'	5 GAL.	45A	6'	CONT.
-- CC	Corydalis x eldoradoensis	5 GAL.	1235A	5'	CONT.
-- CSI	Conium maculatum 'Isanti'	5 GAL.	457S	6'	CONT.
-- DB	Daphne x burkwoodii 'Carol Mackie'	5 GAL.	5	5'	CONT.
-- EAC	Eucyrtus albus 'Compactus'	5 GAL.	45S	6-8'	CONT.
-- FAD	Forsythia 'Arnold Dwarf'	5 GAL.	D	3-4'	CONT.
-- PG	Potentilla fruticosa 'Goldfinger'	5 GAL.	4567S	3-4'	CONT.
-- RTS	Rhus trilobata	5 GAL.	23456DA	4-6'	CONT.
-- SNF	Spiraea japonica 'Neon Flash'	5 GAL.	5A	4'	CONT.
-- SK	Syringa patula 'Miss Kim'	5 GAL.	568A	5'	CONT.
-- VTC	Viburnum triflorum 'Compactum'	5 GAL.	47A	5'	CONT.
Percent Signature Trees: -- -- -- % Signature Trees Total No. of Trees: (60% minimum - Policy 311.1x)					
PERENNIALS/ORNAMENTAL GRASSES					
-- CAB	Calamagrostis brachytricha	1 GAL.	A	2-3'	3" o.c.
-- PEF	Pennisetum exaltatum	1 GAL.	12345678D	18"	6" o.c.
-- PVS	Panicum virgatum 'Shenandoah'	1 GAL.	12346D	18-24"	2-3" o.c.

CONCEPT_PLANT_SCHEDULE

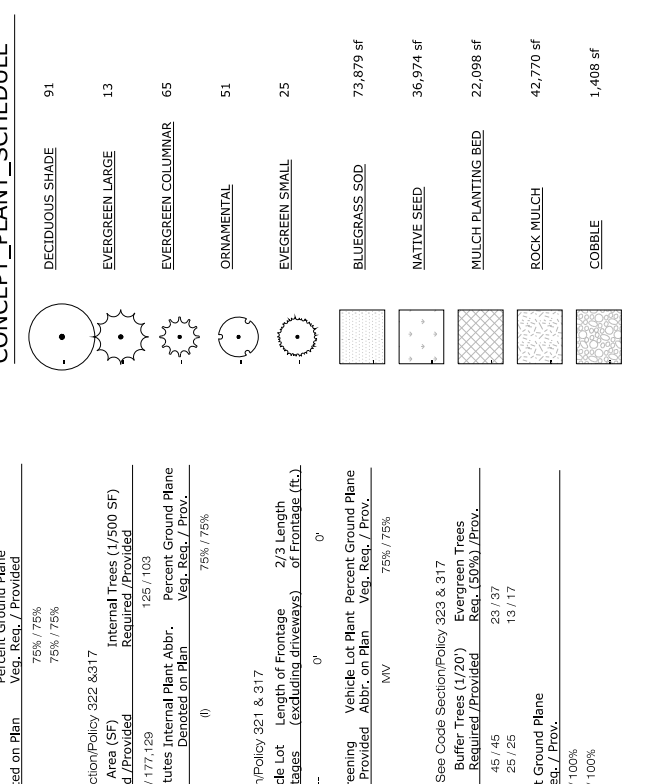





LANDSCAPE SETBACKS

Street Name or Zone Boundary	Street Classification	Width (in Ft.) Req./Prov.	Linear Footage Req./Prov.	Tree/feet Required	No. of Trees Provided
Murray Blvd.	Minor Arterial	1,007	1,250	1/25'	41/41
Pulsar Dr.	Residential	207/20'	388	1/30'	13/13
Shrub Substitutes	Ornamental Grass Substitutes	Req./Provided	Req./Provided	75%/75%	75%/75%
Internal Landscaping	See Code Section/Policy 322 & 317	Internal Area (SF) 62,158/177,129	Internal Area (SF) 125/103	Req./Provided	Req./Provided
Shrub Substitutes	Ornamental Grass Substitutes	Req./Provided	Req./Provided	75%/75%	75%/75%
Motor Vehicle Lots	See Code Section/Policy 321 & 317	Shade Trees (1715 spaces) 18/18 (MV)	Length of Frontage 0'	2/3 Length	2/3 Length
Min. 3' Screening	Evergreen Plants	Length of Screening 0/0	Vehicle Lot Plant 0/0	Percent Ground Plane	Percent Ground Plane
Plants Req./Prov.	Req. (50%) / Prov. (50%)	Req. (50%) / Prov. (50%)	Req. (50%) / Prov. (50%)	Req. (50%) / Prov. (50%)	Req. (50%) / Prov. (50%)


LANDSCAPE BUFFER & SCREENS

Street Name or Property Line	Width (in Ft.)	Linear Footage	See Code Section/Policy 323 & 317	Buffer Trees (1/20')	Evergreen Trees
West Boundary	157/15'	684	45/45	23/37	13/17
North Boundary	157/15'	491	45/45	23/37	13/17
Length of 6' Opaque Buffer Tree Abbr.	Req./Prov.	Req./Prov.	Req./Prov.	Req./Prov.	Req./Prov.
Structure Req./Prov.	Req./Prov.	Req./Prov.	Req./Prov.	Req./Prov.	Req./Prov.

SCHEMATIC LANDSCAPE DIAGRAM

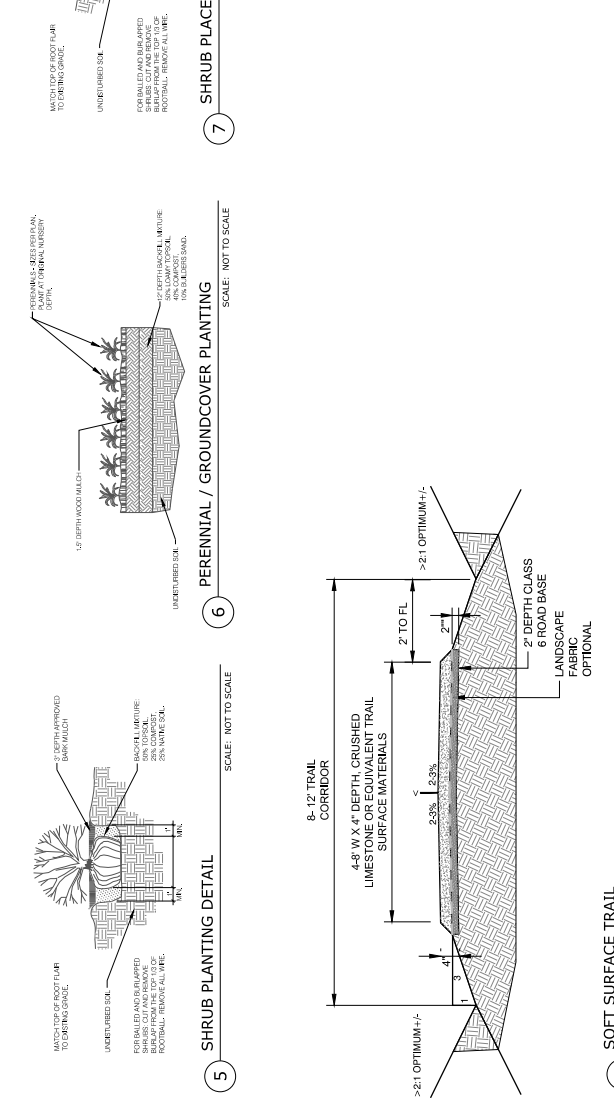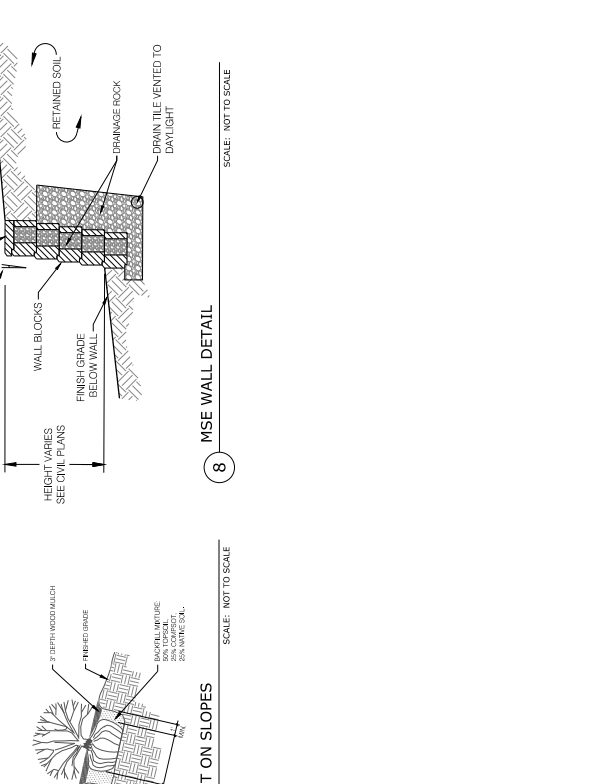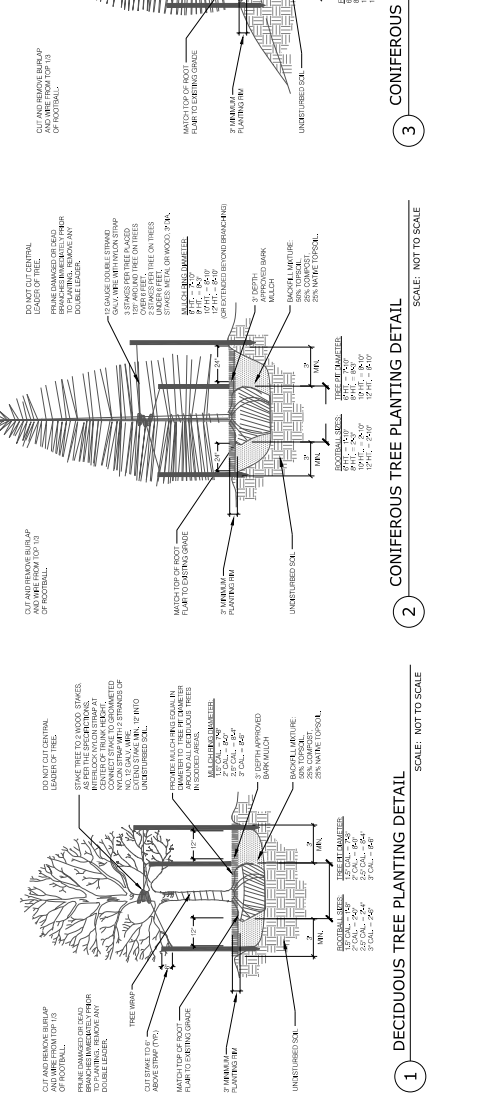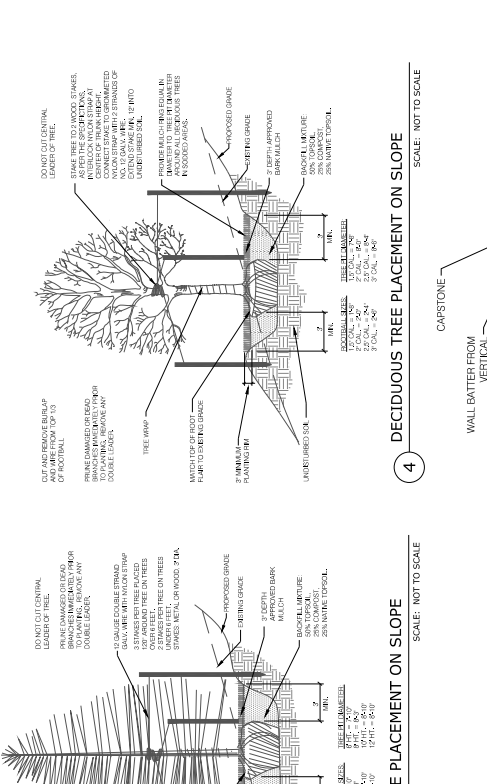

DEVELOPMENT PLAN

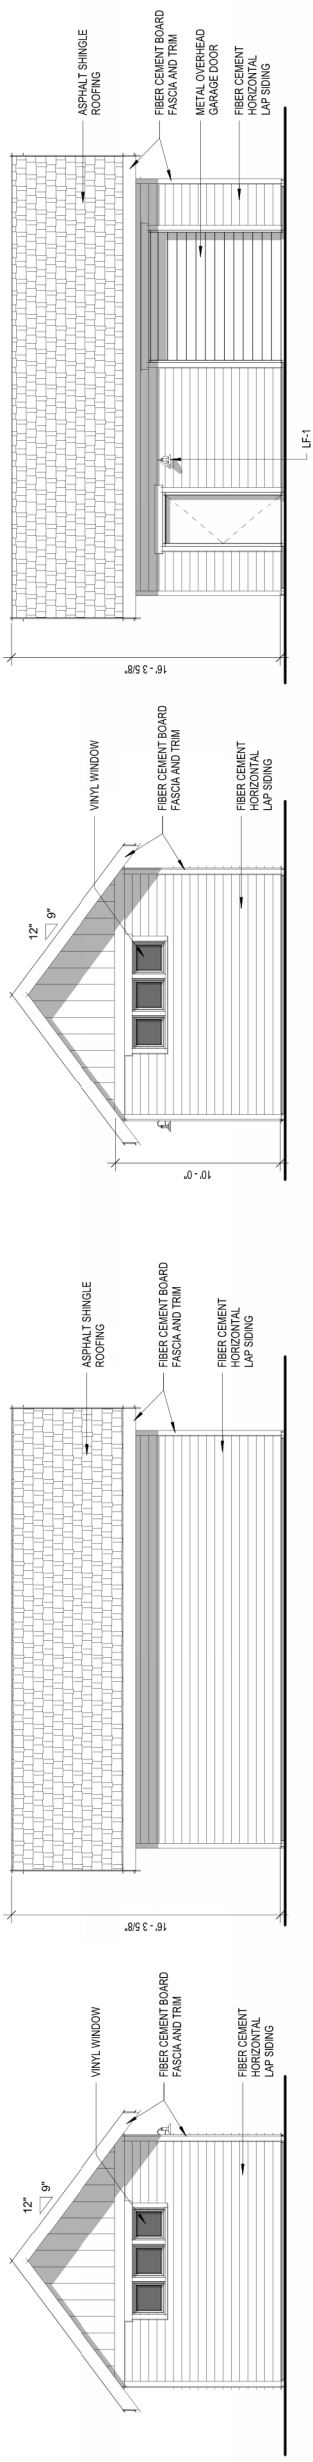


4 MAINTENANCE BUILDING - WEST
DP-206/ 3/16" = 1'-0"


3 MAINTENANCE BUILDING - NORTH
DP-206/ 3/16" = 1'-0"

2 MAINTENANCE BUILDING - EAST
DP-206/ 3/16" = 1'-0"


1 MAINTENANCE BUILDING - SOUTH
DP-206/ 3/16" = 1'-0"

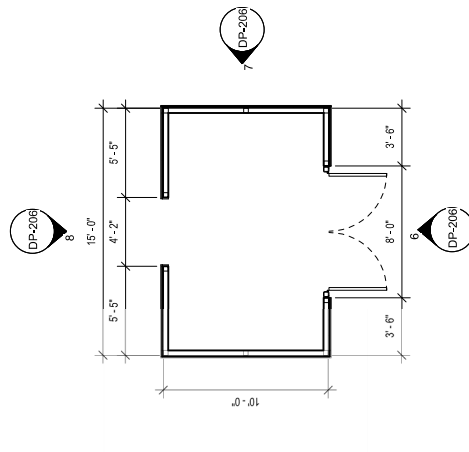


5 TRASH ENCLOSURE PLAN
DP-206/ 3/16" = 1'-0"

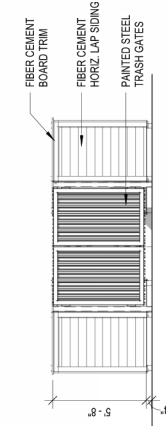

6 TRASH ENCLOSURE - ELEVATION
DP-206/ 3/16" = 1'-0"

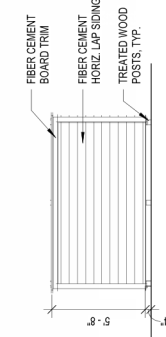

7 TRASH ENCLOSURE - ELEVATION
DP-206/ 3/16" = 1'-0"

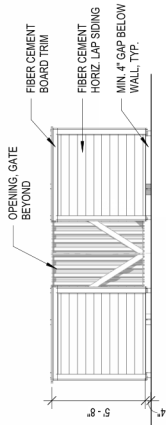

8 TRASH ENCLOSURE - ELEVATION
DP-206/ 3/16" = 1'-0"



LF-1
Bellevue 10" Tall Outdoor Wall Sconce
with Metal Shade - Oil Rubbed Bronze

LF-2
Trans Globe Lighting 1 Light 9" Outdoor
Wall Sconce Pale Light with Textured
Fronted Glass Shade - Rubbed Oil Bronze

LF-3
Westinghouse Clarissa Outdoor Wall
Sconce - Oil Rubbed Bronze

Outdoor Lighting Legend

