
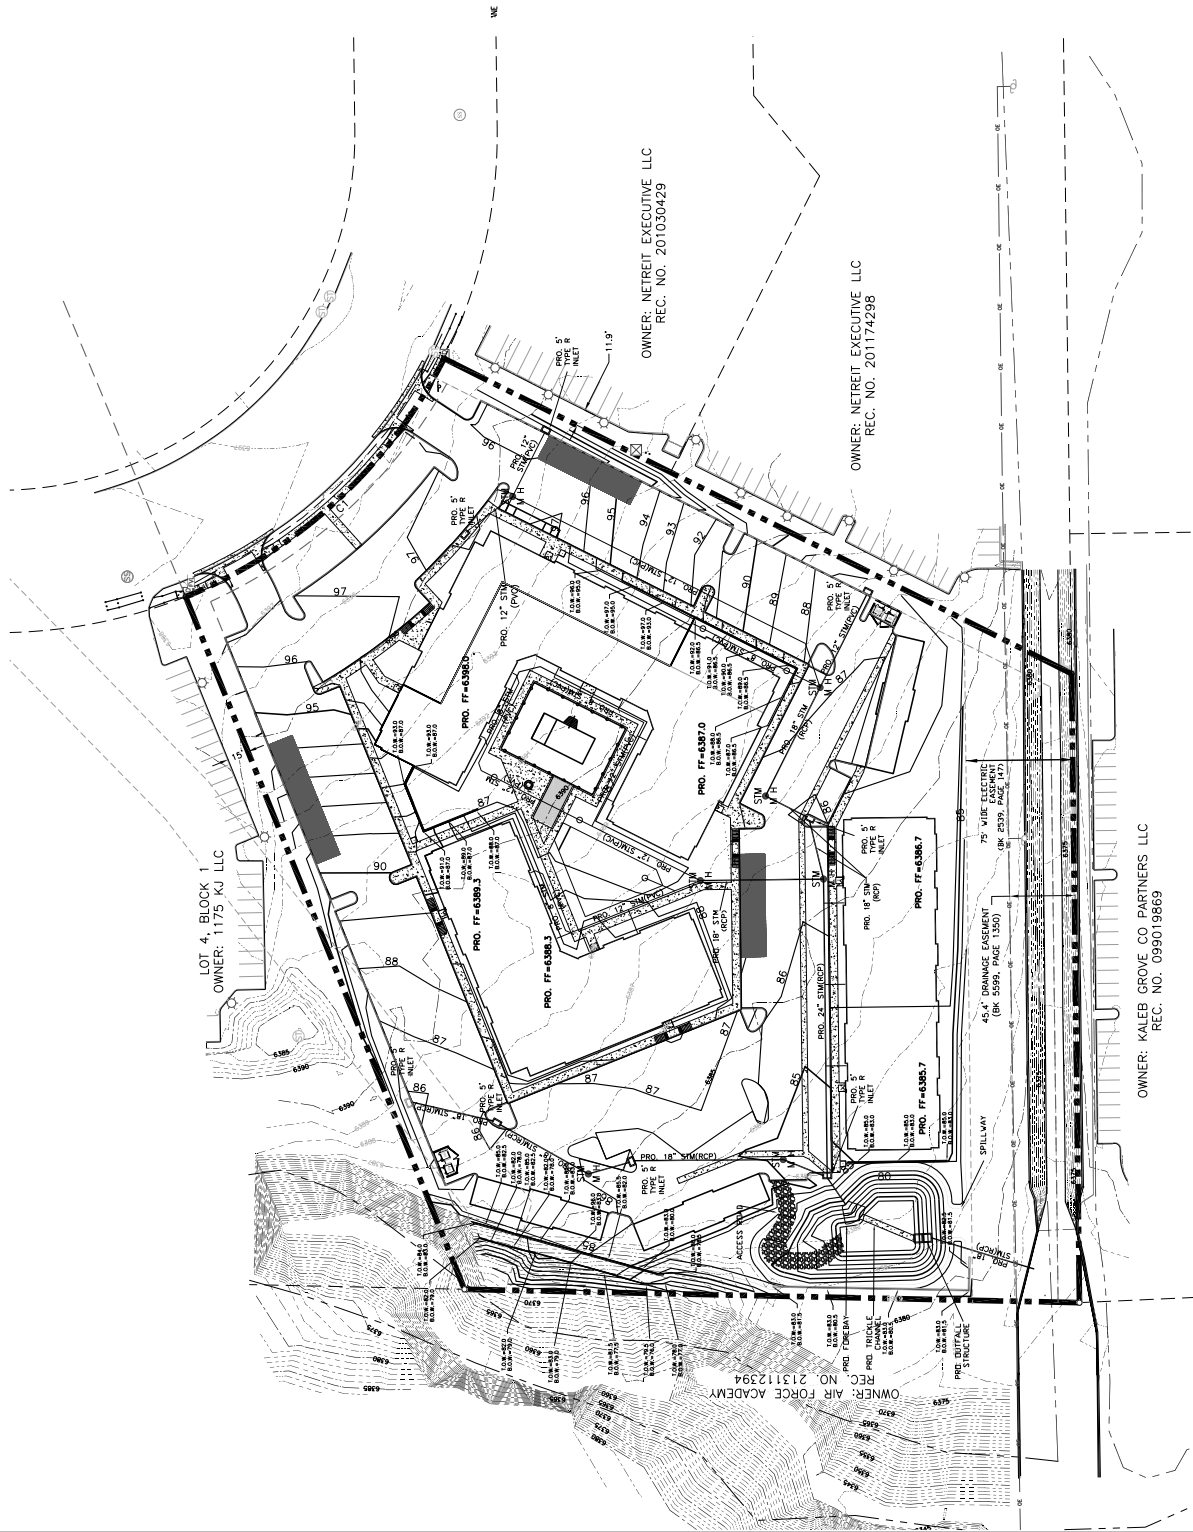


I.O.W.#80.0 - FINISH GRADE AT TOP OF WALL  
 B.O.W.#79.00 - FINISH GRADE AT BOTTOM OF WALL  
 ELEVATIONS DO NOT REFLECT ACTUAL  
 STRUCTURAL WALL CLEARINGS.

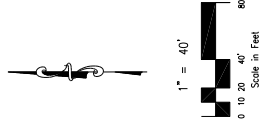

CPC CU 19-00176 SHEET 3 OF 25  
 TEL: 402.633.2222

**ROCKWELL CONSULTING, Inc.**  
 ENGINEERING ARCHITECTURE  
 1000 W. WYOMING ST. SUITE 100  
 LINCOLN, NE 68502-3202  
 (402) 426-2222 FAX (402) 426-2221

THE EDSON AT CAMPE WILLS APARTMENTS  
 PRELIMINARY GRADINGS PLAN  
 SCALE: 1"=40'  
 DRAWN BY: KRP  
 DATE: 3/25/20  
 CHECKED BY: KRP  
 19-022  
 658 806







NOTE: REFER TO SHEET A4.1 FOR PRELIMINARY COLOR SCHEME AND MATERIALS. FINAL MATERIALS AND COLORS TO BE CONFIRMED UPON CONSTRUCTION ON-SITE MOCKUP WALL AND FINAL REVIEW BY OWNER & ARCHITECT



BUILDING #1 ELEVATION - NORTH  
Scale 3/8\"/>



BUILDING #1 ELEVATION - EAST  
Scale 3/8\"/>

**DESIGN GROUP**  
 3000 W. WASHINGTON AVENUE, SUITE 200  
 DENVER, CO 80202  
 PHONE: 303.733.1111  
 WWW.DESIGNGROUP.COM

THE EDISON AT CHAPEL HILLS  
 1000 CHAPEL HILLS BLVD  
 COLORADO SPRINGS, CO 80920

NO.	REVISIONS	DATE
1	ISSUED FOR PERMITS	08/08/19
2	ISSUED FOR CONSTRUCTION	08/08/19

PROJECT NO. 19-00776  
 DRAWING NO. 19-00776-01  
 SHEET NO. 6 OF 25

DATE: 12/05/19  
 D.P. SUBMITTAL  
 SHEET 6 OF 25

CITY REVIEW NO. CRC CU 19-00776

NOTE: REFER TO SHEET A4.1 FOR PRELIMINARY COLOR SCHEME. ALL FINISHES AND MATERIALS TO BE CONFIRMED UPON CONSTRUCTION OF ON-SITE MOCKUP. WALL AND FINAL REVIEW BY OWNER & ARCHITECT.



BUILDING #1 ELEVATION - SOUTH  
Scale 3/32" = 1'-0"



BUILDING #1 ELEVATION - WEST  
Scale 3/32" = 1'-0"

**DESIGN GROUP**  
 1000 W. 10TH AVENUE, SUITE 200  
 DENVER, CO 80202  
 PHONE: 303.733.1111  
 WWW.DESIGNGROUP.COM  
 ARCHITECTS OF RECORD FOR THE PROJECT

THE EDISON AT CHAPEL HILLS  
 1000 W. 10TH AVENUE, SUITE 200  
 COLORADO SPRINGS, CO 80920


NO.	DESCRIPTION	DATE
1	ISSUED FOR PERMITS	08/08/19
2	ISSUED FOR CONSTRUCTION	08/08/19

PROJECT NO. 19-00776  
 SHEET NO. A1.22  
 DATE 12/05/19  
 D.P. SUBMITTAL

NOTE: REFER TO SHEET A4.1 FOR PRELIMINARY COLOR SCHEME  
 AND FINISHES. ALL FINISHES MUST BE CONFIRMED UPON CONSTRUCTION ON-SITE MOCKUP.  
 WALL AND FINAL REVIEW BY OWNER & ARCHITECT



BUILDING #1 ELEVATION - NORTH AND SOUTH COURTYARD  
 Scale 3/32" = 1'-0"

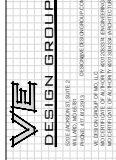

**THE EDISON AT CHAPEL HILLS**  
 1000 W. 10TH AVENUE, SUITE 100  
 COLORADO SPRINGS, CO 80920

NO.	REVISIONS	DATE
1	PRELIMINARY COMMUNITY COMMENTS	08/20/20
PROJECT NO. 19-00776		
BUILDING #1 - ELEVATIONS		
DRAWING NUMBER		
PROJECT NO.	973	A 1.23
DATE	12/05/19	D.P. SUBMITTAL

City Review No. GRCCU 19-00776















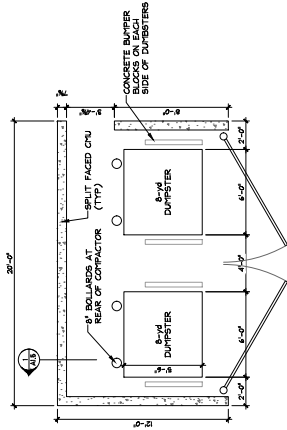


GC #1 SUPPLIER TO COORDINATE FINAL DESIGN OF GATES & SUPPORTS TO MATCH TRASH ENCLOSURE ORIENTATION, AND LOCATIONS)


TRASH ENCLOSURE - FLOOR PLAN  
Scale: 1/4" = 1'-0"

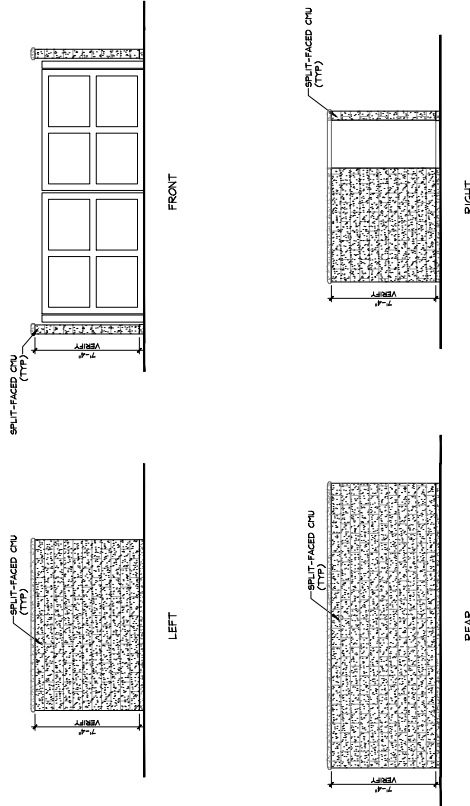

TRASH ENCLOSURE - ELEVATIONS  
Scale: 1/4" = 1'-0"

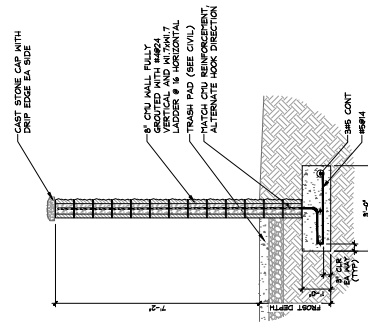

TRASH ENCLOSURE SECTION  
Scale: 1/2" = 1'-0"



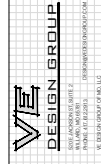


THE EDISON AT CHAPEL HILLS  
TRASH ENCLOSURE  
COLORADO SPRINGS, CO 80920

NO.	DESCRIPTION	DATE

PROJECT #	973
DATE	12/05/19
PROJECT NAME	TRASH ENCLOSURE
SCALE	AS SHOWN
DESIGNER	AG.11
CHECKER	D.P. SUBMITAL



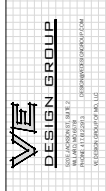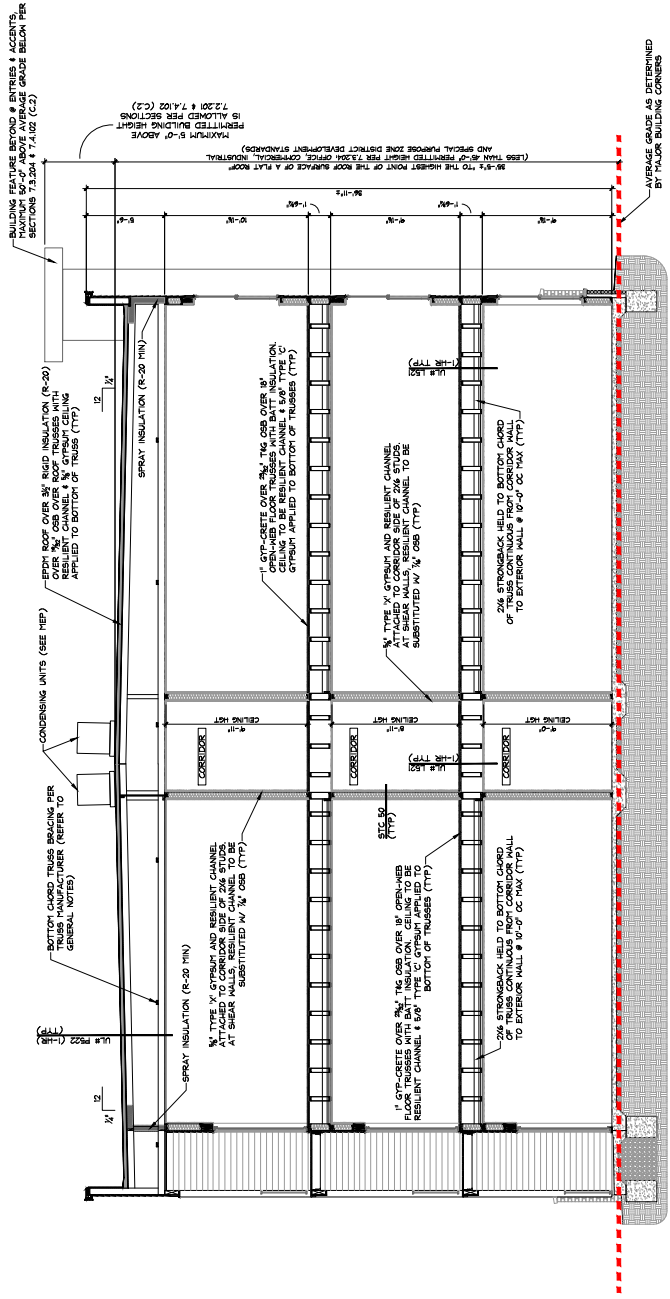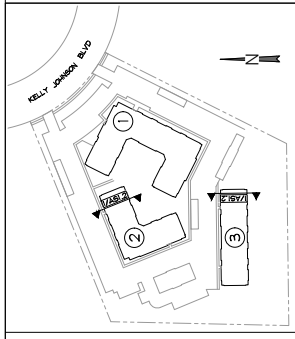

**THE EDISON AT CHAPEL HILLS**  
 10000 CHAPEL HILLS BLVD  
 COLORADO SPRINGS, CO 80920

PROJECT NO: 973  
 DATE: 12/05/19  
 AS1.2  
 D.P. SUBMITTAL

CITY REVIEW NO. CPC 2019-00778

**BUILDING SECTION**  
 Scale: 1/4" = 1'-0"

12/05/19


AS1.2

D.P. SUBMITTAL

SHEET 16 OF 25

# SHEET 17

# SHEET 18

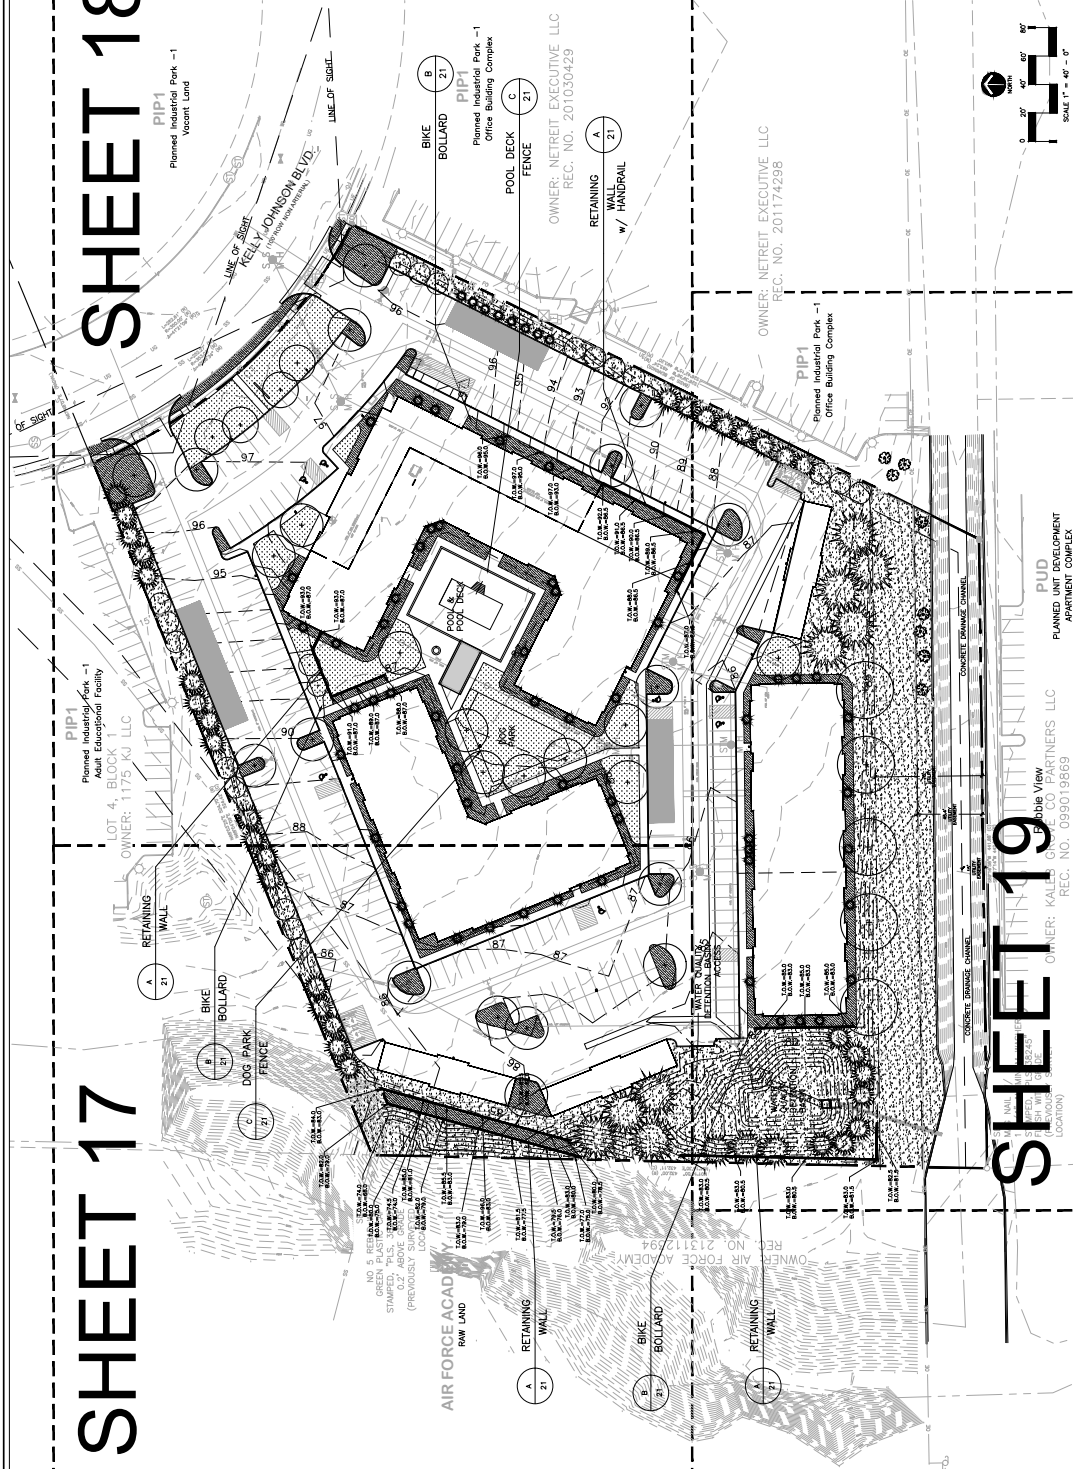

**COVERAGE SUMMARY:**

PROPOSED BUILDING FOOTPRINT AREA	60,058 S.F.	1.38 ACRES
PROPOSED PARKING AREA INCL. GARPORTS	93,426 S.F.	2.14 ACRES
SIDEWALK/POOL DECK AREA	17,859 S.F.	0.41 ACRES
LANDSCAPING/OPEN SPACE	101,064 S.F.	2.32 ACRES
EXISTING DRAINAGE CHANNEL	15,682 S.F.	0.36 ACRES
TOTAL AREA		6.77 ACRES

**PARKING:**  
PARKING SPACES PROVIDED: 270 (includes 4 HC Spaces)

# SHEET 19

THIS DOCUMENT IS FOR CITY REVIEW AND DEVELOPMENT PLAN APPROVAL ONLY. THE DESIGNER SHALL NOT BE RESPONSIBLE FOR THE ACCURACY OF ANY INFORMATION CONTAINED HEREIN THAT IS NOT THE PROPERTY OF THE LANDSCAPE ARCHITECT OF RECORD. AN IRREVOCATION MAY BE SUBMITTED FOR REVIEW WITHIN 30 DAYS SUBSEQUENT TO RECEIVING BUILDING PERMIT. THE PLAN MUST BE APPROVED BY THE CITY OF CHAPEL HILLS IN ORDER TO OBTAIN COMPONENTS AND/OR ISSUANCE OF A CERTIFICATE OF OCCUPANCY.

**DISCLAIMER:**  
RESPECTIVE OF ANY OTHER TERM IN THIS DOCUMENT, DESIGNER SHALL NOT CONTROL OR BE RESPONSIBLE FOR THE ACCURACY OF ANY INFORMATION CONTAINED HEREIN THAT IS NOT THE PROPERTY OF THE LANDSCAPE ARCHITECT OF RECORD. AN IRREVOCATION MAY BE SUBMITTED FOR REVIEW WITHIN 30 DAYS SUBSEQUENT TO RECEIVING BUILDING PERMIT. THE PLAN MUST BE APPROVED BY THE CITY OF CHAPEL HILLS IN ORDER TO OBTAIN COMPONENTS AND/OR ISSUANCE OF A CERTIFICATE OF OCCUPANCY.

Drawn By:	DM
Checked By:	DM
Date:	December 2019
Scale:	1" = 40'-0"
Job No.:	19021
17	17 of 25 sheets

CITY FILE NO.: CPC CU 19-00076

FINAL LANDSCAPE DEVELOPMENT PLAN DOCUMENTS  
for  
**The Edison at Chapel Hills**  
xxxxx  
1265 Kelly Johnson Blvd.  
Colorado Springs, CO

Sheet Title:  
**Landscape Plan**


Review of Document  
This document is for City Review and Development Plan Approval Only. The Designer shall not be responsible for the accuracy of any information contained herein that is not the property of the Landscape Architect of Record. An irrevocation may be submitted for review within 30 days subsequent to receiving building permit. The plan must be approved by the City of Chapel Hills in order to obtain components and/or issuance of a certificate of occupancy.

Revisions	By




Land Patterns, Inc.  
Landscape Architecture  
1265 Kelly Johnson Blvd.  
Colorado Springs, CO 80906  
303.425.1234  
www.landpatterns.com

Revisions	By

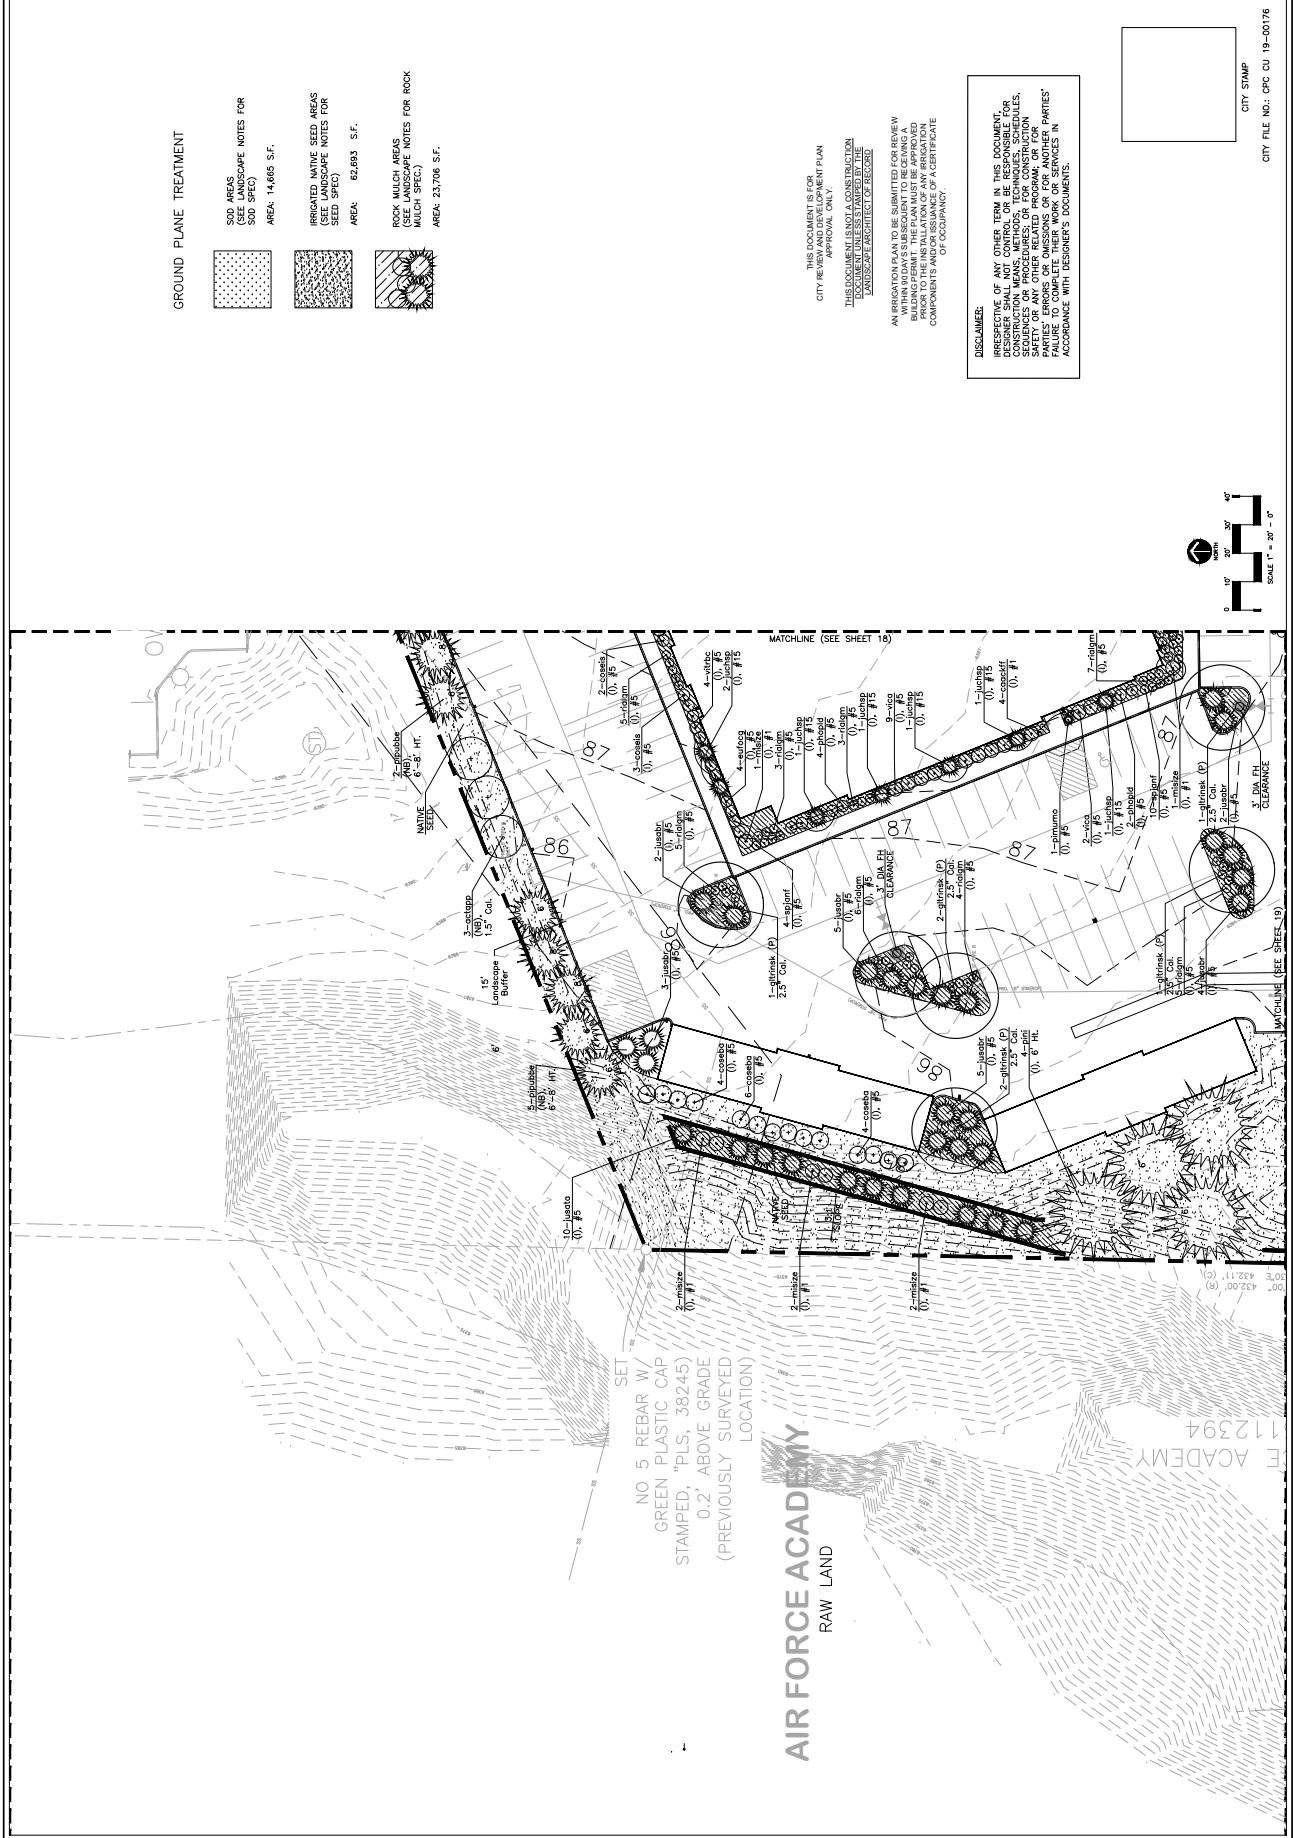Drawn By:	DTM
Checked By:	DTM
Date:	December 2019
Scale:	1" = 20'-0"
Job No.:	19021
<b>18</b>	18 of 25 sheets



**GROUND PLANE TREATMENT**


-  **SOD AREAS**  
(SEE LANDSCAPE NOTES FOR SOD SPEC)  
AREA: 14,685 S.F.
-  **IRRIGATED NATIVE SEED AREAS**  
(SEE LANDSCAPE NOTES FOR SEED SPEC)  
AREA: 62,893 S.F.
-  **ROCK MULCH AREAS**  
(SEE LANDSCAPE NOTES FOR ROCK MULCH SPEC)  
AREA: 23,706 S.F.

THIS DOCUMENT IS FOR CITY REVIEW AND DEVELOPMENT PLAN APPROVAL ONLY.


THIS DOCUMENT IS NOT A CONSTRUCTION DOCUMENT AND SHALL NOT BE USED FOR CONSTRUCTION.

AN IRRIGATION PLAN TO BE SUBMITTED FOR REVIEW BY THE CITY ENGINEER, AND THE IRRIGATION PLAN MUST BE APPROVED BY THE CITY ENGINEER AND THE IRRIGATION CONTRACTOR AND AN INSURANCE CO. A CERTIFICATE OF OCCUPANCY.

**DISCLAIMER:**  
IRRESPECTIVE OF ANY OTHER TERM IN THIS DOCUMENT, DESIGNER SHALL NOT BE RESPONSIBLE FOR THE DESIGN, CONSTRUCTION, MAINTENANCE, SEQUENCES OR PROCEDURES; OR FOR CONSTRUCTION DEFECTS OR OMISSIONS; OR FOR ANY OTHER PARTIES' FAILURE TO COMPLETE THEIR WORK OR SERVICES IN ACCORDANCE WITH DESIGNER'S DOCUMENTS.

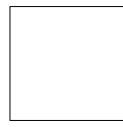

CITY FILE NO.: CPC CU 19-00076

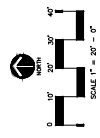

SET  
NO 5 REBAR W/  
GREEN PLASTIC CAP  
STAMPED, "PLS. 38245)  
0.2' ABOVE GRADE  
(PREVIOUSLY SURVEYED  
LOCATION)

**AIR FORCE ACADEMY**  
RAW LAND

112394  
E ACADEMY















THIS DRAWING IS THE PROPERTY OF MEP ENGINEERING, LLC AND IS NOT TO BE REPRODUCED OR TRANSMITTED IN ANY FORM OR BY ANY MEANS, ELECTRONIC OR MECHANICAL, INCLUDING PHOTOCOPYING, RECORDING, OR BY ANY INFORMATION STORAGE AND RETRIEVAL SYSTEM, WITHOUT THE WRITTEN PERMISSION OF MEP ENGINEERING, LLC.

DATE	02/20/20
PROJECT TITLE	PROPOSED APARTMENT PROJECT
OWNER	208 KELLY J. JOHNSON, LLC
PROJECT ADDRESS	10000 SPRING CREEK DRIVE, COLORADO SPRINGS, CO

MEP ENGINEERING, LLC  
 10000 SPRING CREEK DRIVE, SUITE 100  
 COLORADO SPRINGS, CO 80901  
 TEL: 719.575.5555  
 WWW.MEPENGINEERING.COM

PRELIMINARY  
 NOT INTENDED FOR  
 CONSTRUCTION

**m e p**  
 ENGINEERING, LLC

PROPOSED APARTMENT PROJECT  
 208 KELLY JOHNSON, LLC  
 COLORADO SPRINGS, CO


SHEET TITLE  
 SITE PHOTOMETRICS PLAN

SHEET NUMBER  
**MEP3**

CITY REVIEW NO. CPC 0119-00178  
 SHEET 24 OF 25

MARK	CITY	MANUFACTURER	MODEL NO.	CLASS	WATT	LUMENS	ECT (%)	CH	LAMP TYPE	INDICATING	REMARKS
AA		EATON	GEON AF 02-ED-51-518-H55	TYPE V POLE MOUNT	120	116	113	1000	70	LED	POLE
BB		EATON	GEON AF 02-ED-51-518-H55	TYPE V POLE MOUNT	120	116	113	1000	70	LED	POLE
CC		EATON	GEON AF 02-ED-51-518-H55	TYPE V POLE MOUNT	120	116	113	1000	70	LED	POLE
DD		EATON	GEON AF 02-ED-51-518-H55	TYPE V POLE MOUNT	120	116	113	1000	70	LED	POLE
EE		EATON	GEON AF 02-ED-51-518-H55	TYPE V POLE MOUNT	120	116	113	1000	70	LED	POLE
FF		EATON	GEON AF 02-ED-51-518-H55	TYPE V POLE MOUNT	120	116	113	1000	70	LED	POLE
GG		EATON	GEON AF 02-ED-51-518-H55	TYPE V POLE MOUNT	120	116	113	1000	70	LED	POLE
HH		EATON	GEON AF 02-ED-51-518-H55	TYPE V POLE MOUNT	120	116	113	1000	70	LED	POLE
II		EATON	GEON AF 02-ED-51-518-H55	TYPE V POLE MOUNT	120	116	113	1000	70	LED	POLE
JJ		EATON	GEON AF 02-ED-51-518-H55	TYPE V POLE MOUNT	120	116	113	1000	70	LED	POLE
KK		EATON	GEON AF 02-ED-51-518-H55	TYPE V POLE MOUNT	120	116	113	1000	70	LED	POLE
LL		EATON	GEON AF 02-ED-51-518-H55	TYPE V POLE MOUNT	120	116	113	1000	70	LED	POLE
MM		EATON	GEON AF 02-ED-51-518-H55	TYPE V POLE MOUNT	120	116	113	1000	70	LED	POLE
NN		EATON	GEON AF 02-ED-51-518-H55	TYPE V POLE MOUNT	120	116	113	1000	70	LED	POLE
OO		EATON	GEON AF 02-ED-51-518-H55	TYPE V POLE MOUNT	120	116	113	1000	70	LED	POLE
PP		EATON	GEON AF 02-ED-51-518-H55	TYPE V POLE MOUNT	120	116	113	1000	70	LED	POLE
QQ		EATON	GEON AF 02-ED-51-518-H55	TYPE V POLE MOUNT	120	116	113	1000	70	LED	POLE
RR		EATON	GEON AF 02-ED-51-518-H55	TYPE V POLE MOUNT	120	116	113	1000	70	LED	POLE
SS		EATON	GEON AF 02-ED-51-518-H55	TYPE V POLE MOUNT	120	116	113	1000	70	LED	POLE
TT		EATON	GEON AF 02-ED-51-518-H55	TYPE V POLE MOUNT	120	116	113	1000	70	LED	POLE
UU		EATON	GEON AF 02-ED-51-518-H55	TYPE V POLE MOUNT	120	116	113	1000	70	LED	POLE
VV		EATON	GEON AF 02-ED-51-518-H55	TYPE V POLE MOUNT	120	116	113	1000	70	LED	POLE
WW		EATON	GEON AF 02-ED-51-518-H55	TYPE V POLE MOUNT	120	116	113	1000	70	LED	POLE
XX		EATON	GEON AF 02-ED-51-518-H55	TYPE V POLE MOUNT	120	116	113	1000	70	LED	POLE
YY		EATON	GEON AF 02-ED-51-518-H55	TYPE V POLE MOUNT	120	116	113	1000	70	LED	POLE
ZZ		EATON	GEON AF 02-ED-51-518-H55	TYPE V POLE MOUNT	120	116	113	1000	70	LED	POLE

LABEL	UNIT	AVG	MAX	MIN	AVG/MIN	MAX/AVG
MAX FOOTCANDLES	FC	1.67	2.70	0.00	2.78	4.5:1
UNIFORMITY	FC	0.02	0.40	0.00	---	---

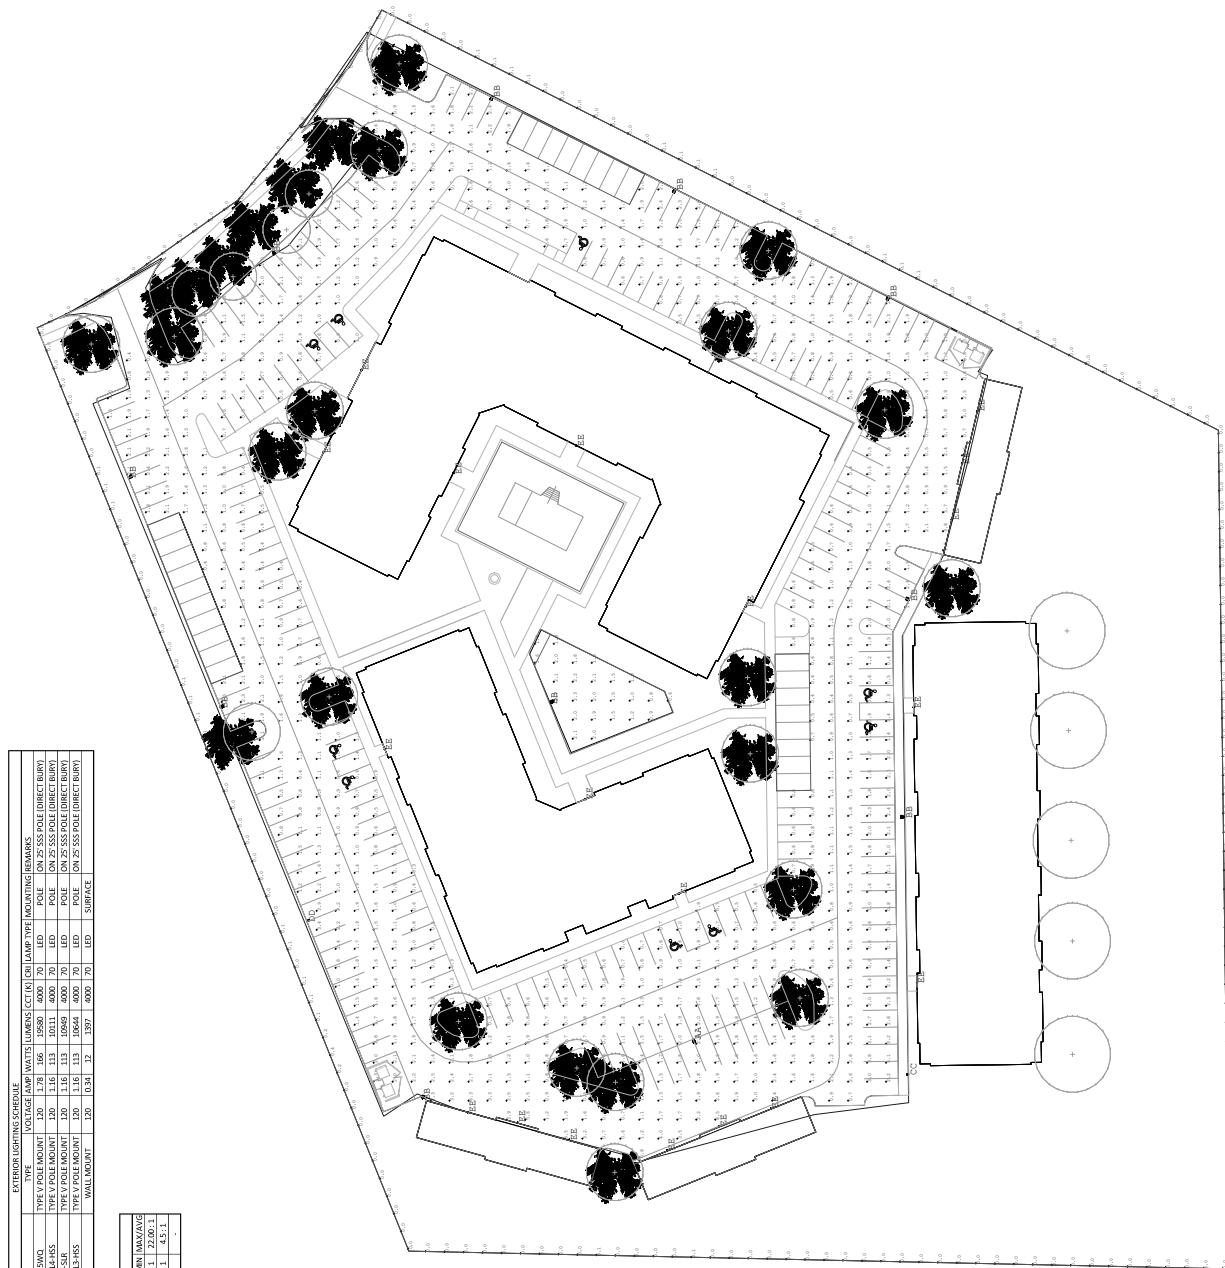

SITE PHOTOMETRICS PLAN  
 SCALE: 1" = 30'

