




# ABBA EYE CARE CENTER

LOT 1 of COLORADO COUNTRY FILING NO 15

SHEET	DESCRIPTION
C-1	COVER SHEET & SITE PLAN
C-2	GRADING PLAN
C-3	UTILITY & PUBLIC IMPROVEMENT PLAN
C-4	EROSION CONTROL PLAN
C-5	DETAILS & SECTIONS
C-6	PHOTOMETRIC PLAN
LP-01 THROUGH LP-02	LANDSCAPING PLAN
DP-A-1	DEVELOPMENT PLAN FLOOR PLAN
DP-A-2	DEVELOPMENT PLAN ELEVATIONS

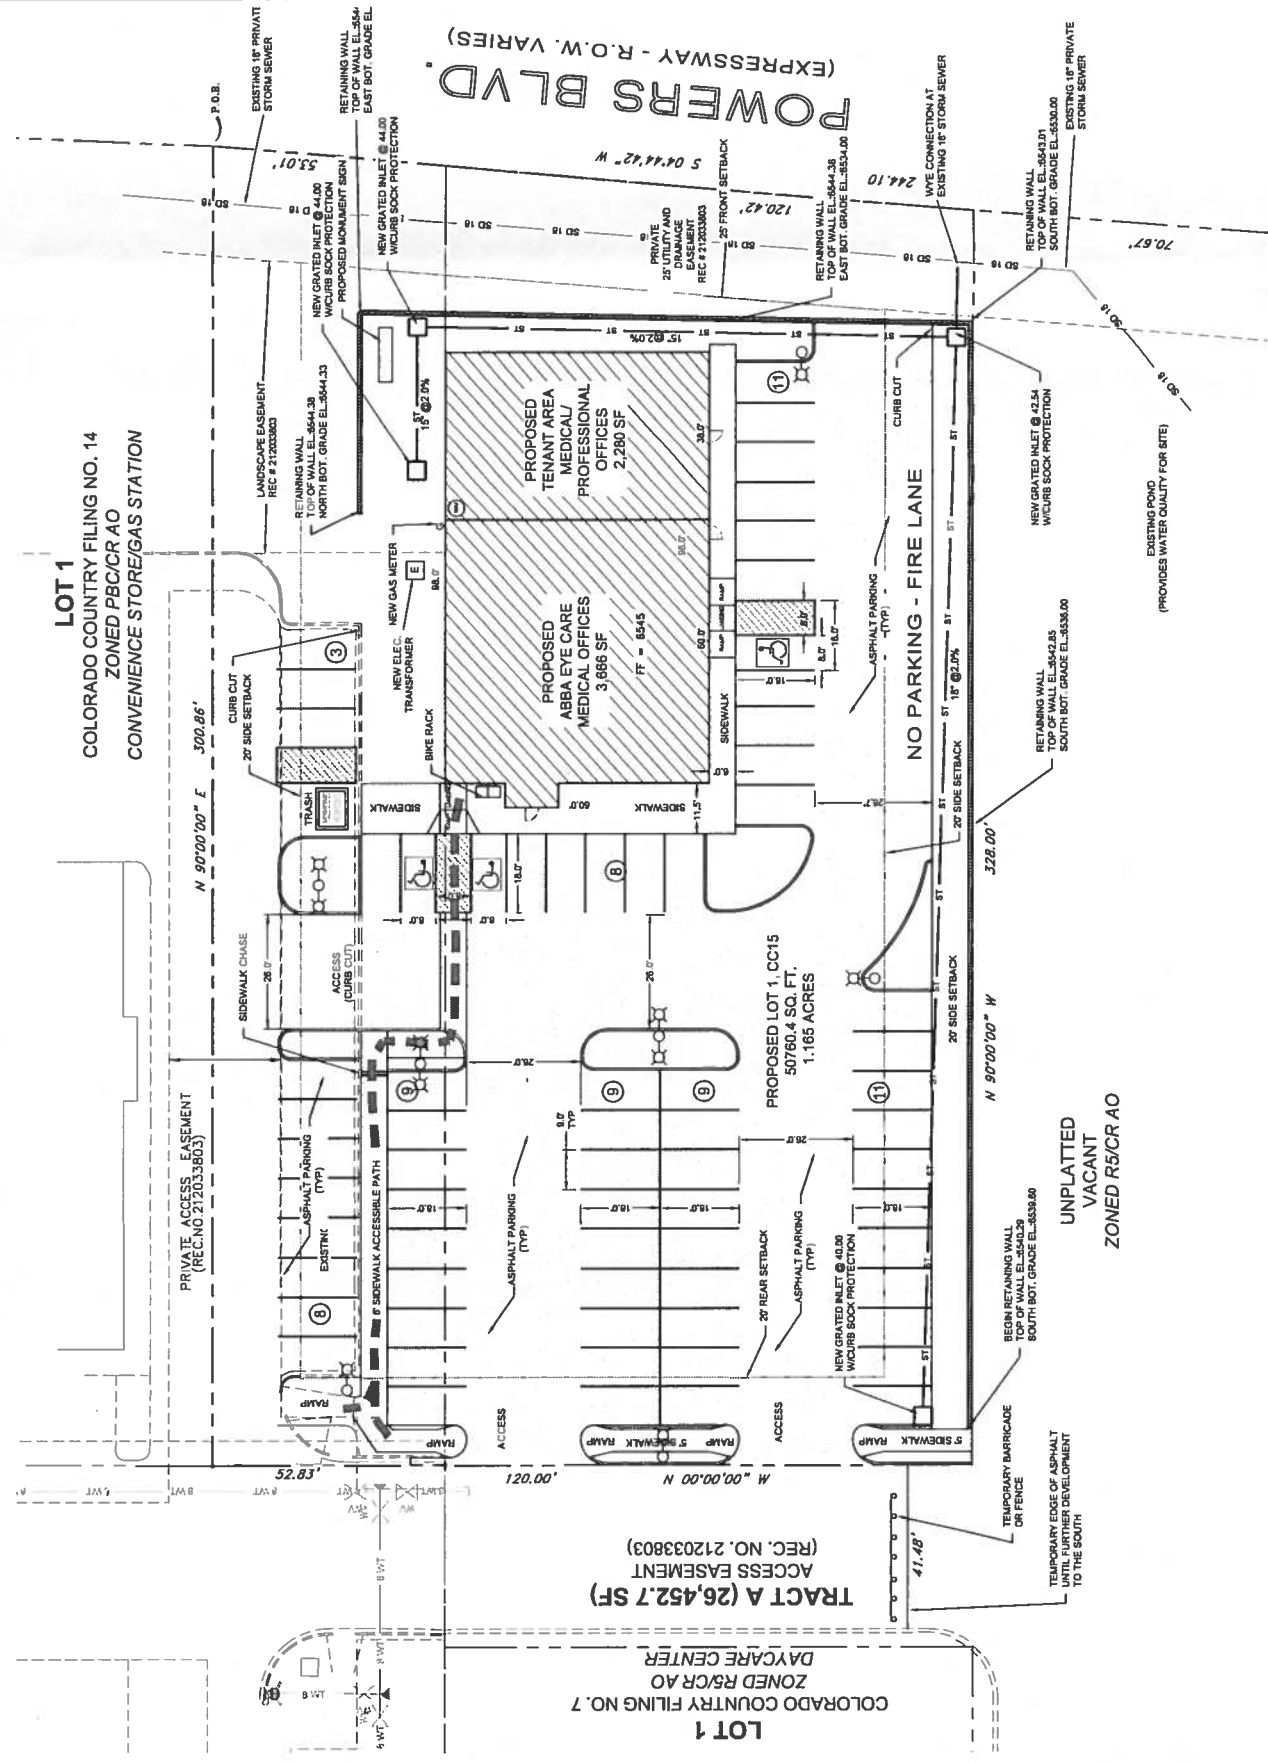

- HANDICAPPED PARKING SPACE DESIGN CRITERIA**
- Ramps shall not be placed in handicapped access aisle, but shall be placed within the adjoining sidewalk.
  - Handicapped ramps may be placed in any direction.
  - The minimum width for handicapped ramps is 36 inches clear.
  - The sides of ramps shall not exceed a grade of 10% unless protected with a handrail.
  - Handicapped parking shall meet all other applicable City, ADA, and ANSI standards.

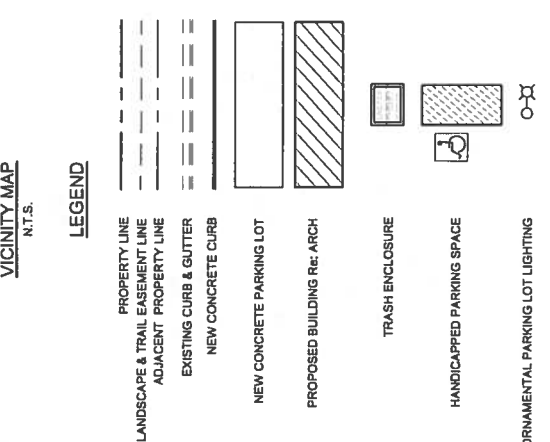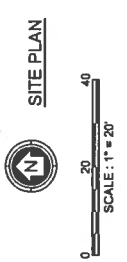

**LEGAL DESCRIPTION**

THAT PORTION OF SECTION 23, TOWNSHIP 13 SOUTH RANGES WEST OF THE 6TH P.M., EL PASO COUNTY, COLORADO, MORE PARTICULARLY DESCRIBED AS FOLLOWS:

BASIS OF BEARING: ALL BEARINGS USED IN THESE DESCRIPTIONS ARE RELATIVE TO THOSE SHOWN ON "COLORADO COUNTRY FILING NO. 14", AS RECORDED AT RECEPTION NUMBER 21717402 OF THE RECORDS OF EL PASO COUNTY, COLORADO.

BEGINNING AT THE MOST NORTHEASTLY CORNER OF LOT 2 OF SAID "COLORADO COUNTRY FILING NO. 14", POINT ALSO BEING ON THE WESTERLY RIGHT OF WAY OF "POWERS BOULEVARD" AS RECORDED AT RECEPTION NUMBER 21701012 OF SAID RECORDS;

TRENCHE ALONG SAID WESTERLY RIGHT OF WAY FOR THE FOLLOWING TWO (2) COURSES;

COURSE "14":

- S. 64°42'37" W. 33.81 FEET TO THE SOUTHWEST CORNER OF SAID LOT 2 ON SAID "COLORADO COUNTRY "14";
- S. 64°42'37" W. 128.42 FEET;

TRENCHE N. 90°00'00" W. 328.00 FEET TO THE SOUTHWEST CORNER OF "COLORADO COUNTRY NO. 7";

TRENCHE N. 00°00'00" E. 128.88 FEET TO THE NORTHEAST CORNER OF SAID "COLORADO COUNTRY NO. 7";

TRENCHE N. 90°00'00" E. 41.48 FEET;

TRENCHE N. 00°00'00" E. 51.81 FEET TO THE NORTHWEST CORNER OF SAID LOT 2 OF "COLORADO COUNTRY NO. 14";

TRENCHE N. 90°00'00" E. 308.88 FEET TO THE POINT OF BEGINNING, CONTAINING 51.78 ± 90.71 (1.16 ± ACRES) MORE OR LESS.

**DEVELOPMENT PLAN INFORMATION**

Existing Zoning: R5/CR AO (Ordinance No. 80-288)

Conditions of Approval:

- 1) Avigation easement to be filed with plat.
- 2) Noise attenuation construction methods, as approved by FAA, required to mitigate noise impacts.

and PBC/CR AO (Ordinance No. 80-287)

Conditions of Approval:

- 1) Only one access to North Carlinee Circle.
- 2) No access to be allowed to Powers Blvd.
- 3) Avigation easement to be filed with plat.
- 4) Noise attenuation construction methods, as approved by FAA, required to mitigate noise impacts.

- Proposed Zoning: OCCR AO (Ordinance No. \_\_\_\_\_)
- Conditions of Record:
1. Only one access to North Carlinee Circle.
  2. No access to be allowed to Powers Blvd.
  3. All permitted uses under the OCCR AO district are allowed except the following:
- Denatification Center
  - Automotive Rentals
  - Specialty Food Sales
  - Neighborhood Serving Retail
  - Drive-In or Fast Food
  - Quick-Serve Restaurant
  - Sit-Down restaurant
- Concept Plan: Southwest Powers & North Carlinee AR CP 11-00482-AM114
- Master Plan: Colorado Country Master Plan
- Associated Districts: Powers Metropolitan District
- Use: Medical office/lab or clinic / General Office
- Public Facilities Required: Water, Wastewater, Electric, Natural Gas, Phone/Data
- Building Height: Allowed 45'; Proposed 21'-6"

**Setbacks:**

Front (East) Setback: 25' Required

Side (North) Setback: 20' Required

Side (South) Setback: 20' Required

Rear (West) Setback: 20' Required

**Landscaping Setbacks:**

Powers Blvd.: 25' Required

**Owner Name and Address:**

SW Carlinee & Powers, Inc.

c/o Dielme Management

P.O. Box 75004

Colorado Springs, CO 80970

**Parcel Number:** 6325400021 (Part) & 6325418005

**Assessors Parcel:** 50,737 SF (1.16 acres more-or-less)

**Current Use:** Vacant

**Gross Existing Building Area:** 0 SF

**Proposed Principal Uses:** Medical Offices, Lab, Clinic and/or General Office

**Percentage of Site Covered with Structures:** Approx. 12%

**Percentage of Site Covered with Pavement:** Approx. 55%

**Flood Plain:** According to the national Flood Insurance Program Flood Insurance Rate map for El Paso County, Colorado and incorporated areas panel 538 of 1300 map #88041C0538 the site is not located in a flood plain.

**Required Parking Spaces:**

Medical Offices, Labs & Clinics - 1 per 200 S.F.; 6,946 SF/200 = 30

T.C.-1 Spaces/25 Required: 1 per 25 = 2

Total Parking Spaces Required: 30+2 HC

Total Parking Spaces Provided: 66+3 HC

Approximate Schedule for Development: October 2016

**Development Applicant:**

Company:

Abba Eye Care Center

1130 Lake Plaza Dr, Colorado Springs CO, CO 80906

**AR DP 16-00066**

Gagliano Engineering, Inc. - (719) 547-7073  
 1740 Englebridge Blvd, Suite #150  
 Pueblo, CO 81008

**COVER SHEET & SITE PLAN**

ABBA ADDRESS  
 ABBA, SUB. COLORADO SPRINGS CO 80901


PROJECT NO.: 2016-006

DRAWN BY: JG      DATE: 9/22/16      SCALE: as shown

CHECKED BY: JG      DATE: 08/16/16      DRAWING NO.: 2016-006-basemap.dwg

SHEET NO.: C-1

FIGURE 4

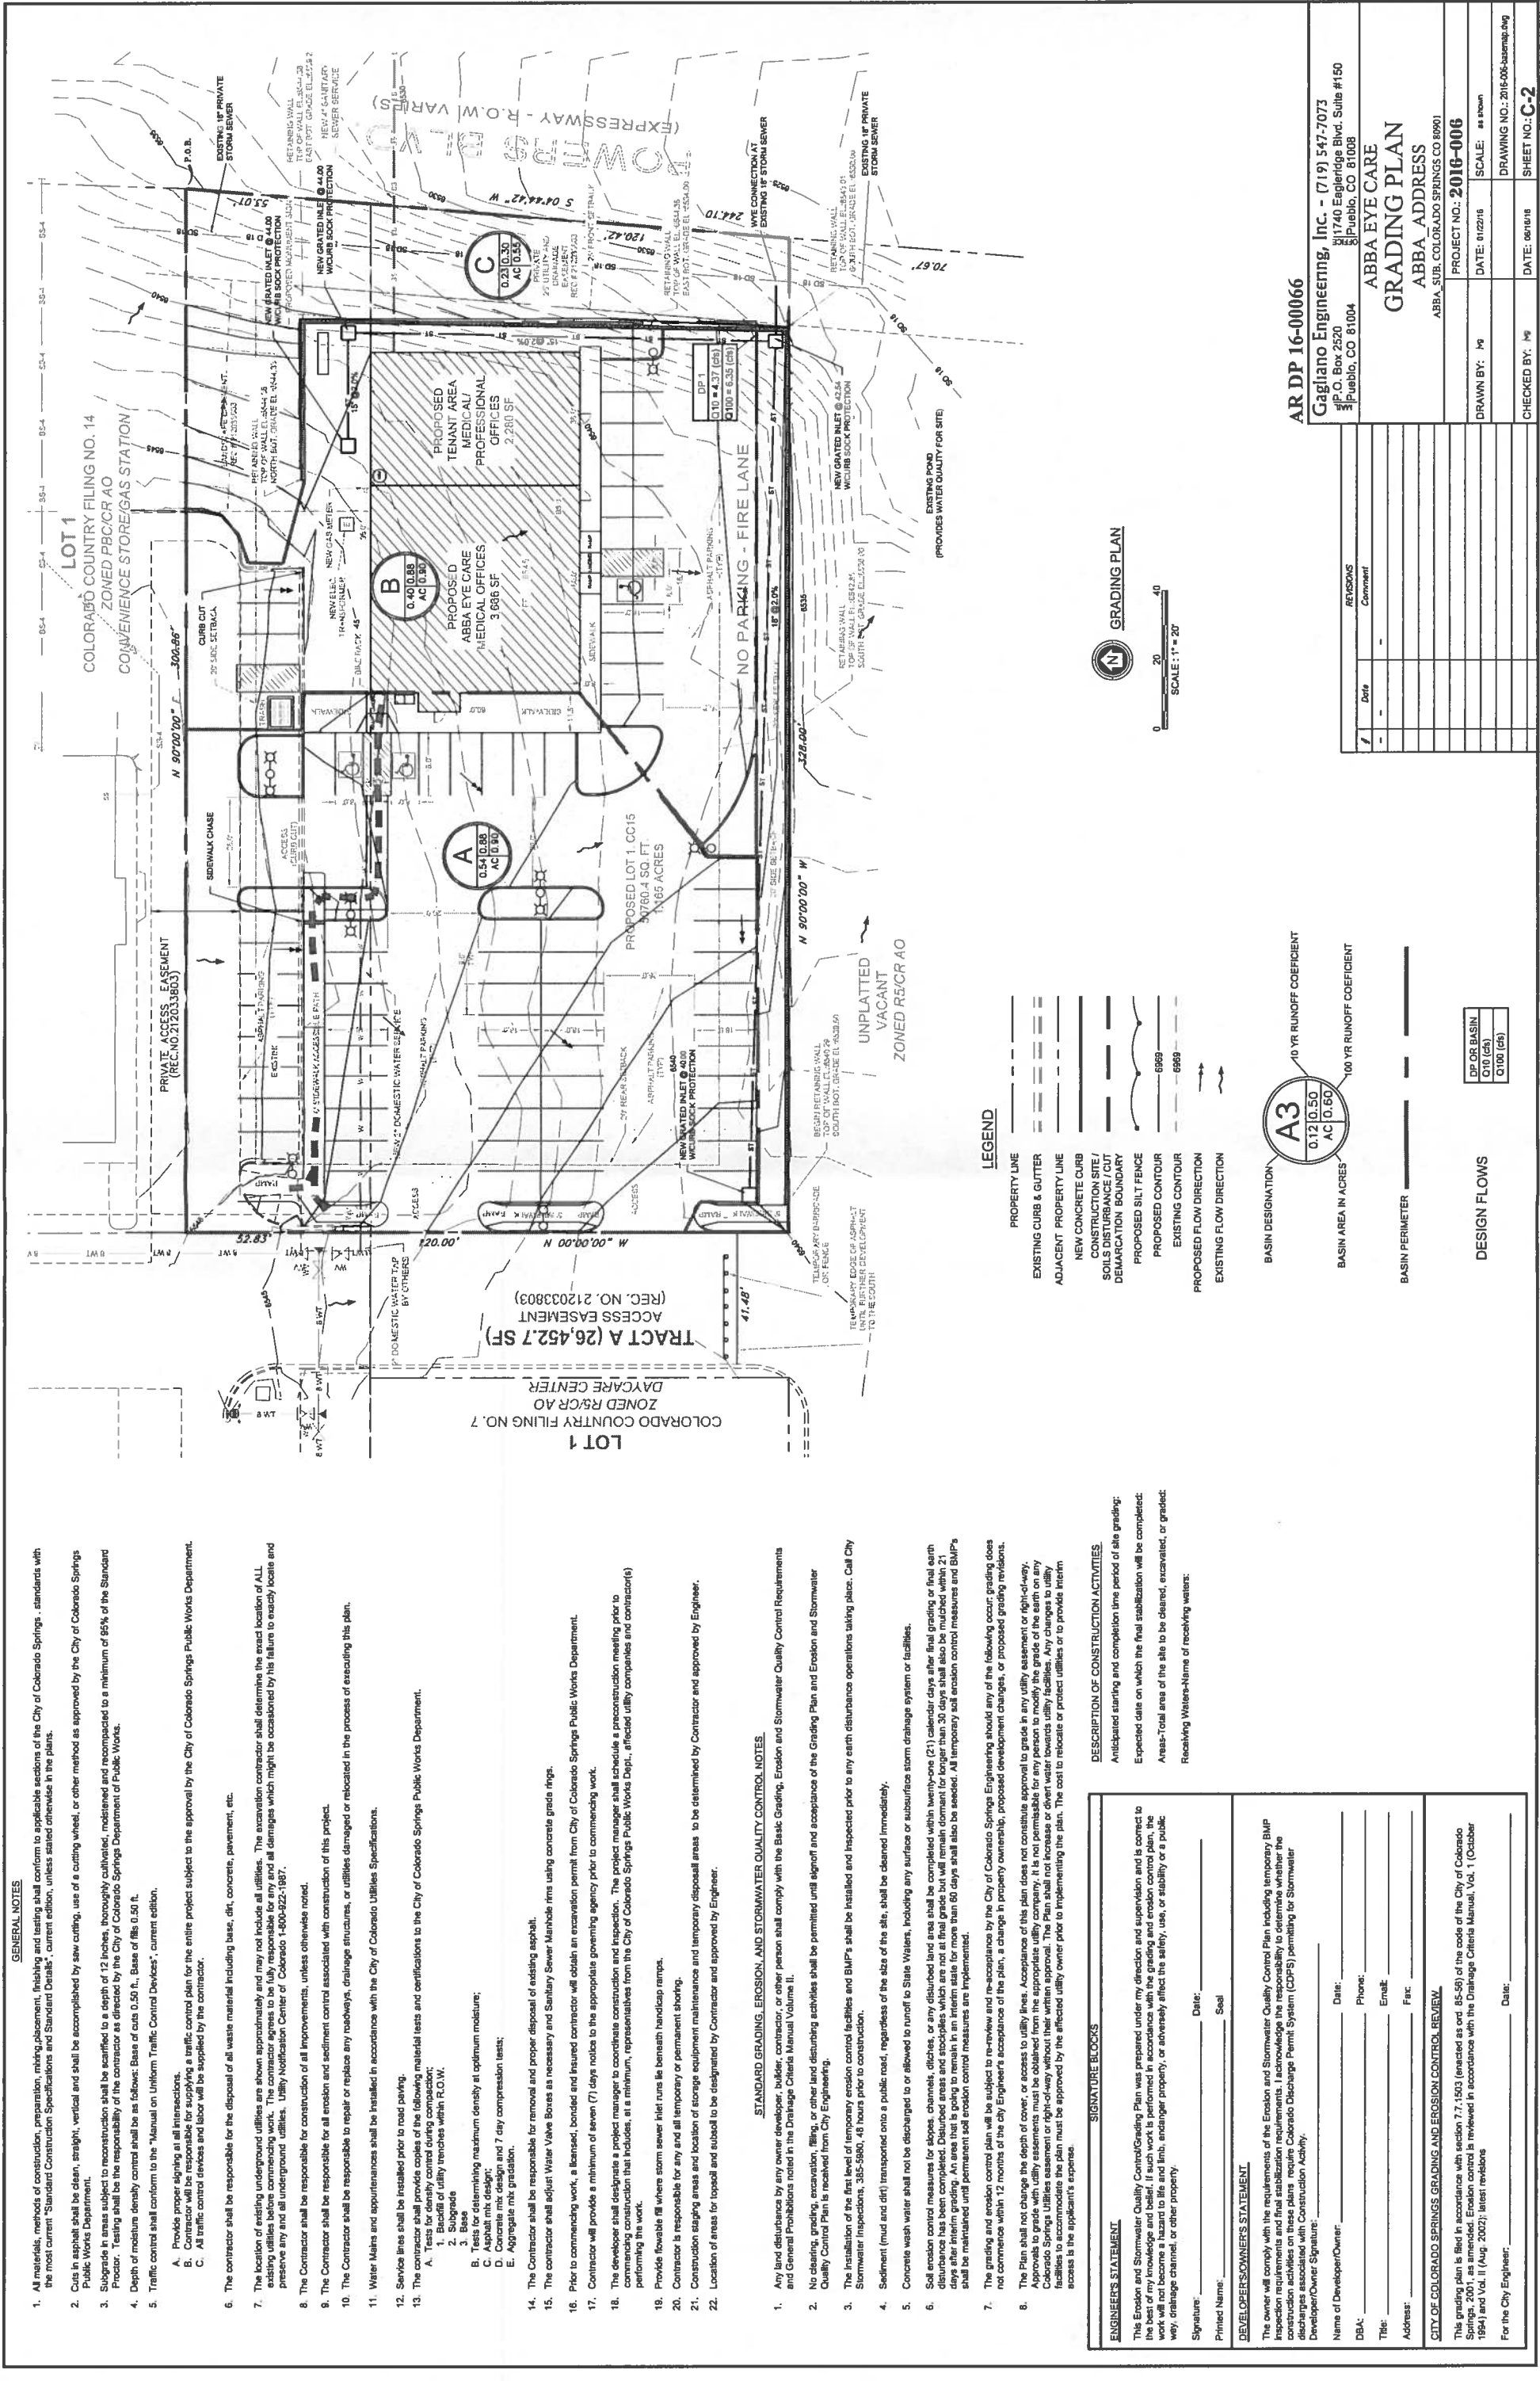

**GENERAL NOTES**

- All materials, methods of construction, preparation, mixing, placement, finishing and testing shall conform to applicable sections of the City of Colorado Springs, standards with the most current "Standard Construction Specifications and Standard Details", current edition, unless stated otherwise in the plans.
- Cuts in asphalt shall be clean, straight, vertical and shall be accomplished by saw cutting, use of a cutting wheel, or other method as approved by the City of Colorado Springs Public Works Department.
- Subgrade in areas subject to reconstruction shall be scarified to a depth of 12 inches, thoroughly cultivated, moistened and recompacted to a minimum of 95% of the Standard Proctor. Testing shall be the responsibility of the contractor as directed by the City of Colorado Springs Department of Public Works.
- Depth of moisture density control shall be as follows: Base of cuts 0.50 ft., Base of fills 0.50 ft.
- Traffic control shall conform to the "Manual on Uniform Traffic Control Devices", current edition.
- Provide proper signing at all intersections.
- Contractor will be responsible for supplying a traffic control plan for the entire project subject to the approval by the City of Colorado Springs Public Works Department.
- All traffic control devices and labor will be supplied by the contractor.
- The contractor shall be responsible for the disposal of all waste materials including base, dirt, concrete, pavement, etc.
- The location of existing underground utilities are shown approximately and may not include all utilities. The excavation contractor shall determine the exact location of ALL existing utilities and shall be responsible for any and all damages which might be occasioned by the failure to exactly locate and preserve any and all underground utilities. Utility Notification Center of Colorado 1-800-822-1987.
- The Contractor shall be responsible for construction of all improvements, unless otherwise noted.
- The Contractor shall be responsible for all erosion and sediment control associated with construction of this project.
- The Contractor shall be responsible to repair or replace any roadways, drainage structures, or utilities damaged or relocated in the process of executing this plan.
- Water mains and appurtenances shall be installed in accordance with the City of Colorado Utilities Specifications.
- Service lines shall be installed prior to road paving.
- The contractor shall provide copies of the following material tests and certifications to the City of Colorado Springs Public Works Department.
  - Tests for density control during construction.
  - Subgrade
  - Base
  - Tests for determining maximum density at optimum moisture;
  - Asphalt mix design;
  - Concrete mix design and 7 day compression tests;
  - Aggregate mix gradation.
- The contractor shall adjust Water Valve Boxes as necessary and Sanitary Sewer Manhole rims using concrete grade rings.
- Prior to commencing work, a bonded, bonded and insured contractor will obtain an excavation permit from City of Colorado Springs Public Works Department.
- Contractor will provide a minimum of seven (7) days notice to the appropriate governing agency prior to commencing work.
- The developer shall designate a project manager to coordinate construction and inspection. The project manager shall schedule a reconstruction meeting prior to commencing construction that includes, at a minimum, representatives from the City of Colorado Springs Public Works Dept., affected utility companies and contractor(s) performing the work.
- Provide flowable fill where storm sewer inlet runs lie beneath handicap ramps.
- Contractor is responsible for any and all temporary or permanent shoring.
- Construction staging areas and location of storage equipment maintenance and temporary disposal areas to be determined by Contractor and approved by Engineer.
- Location of areas for topsoil and subsoil to be designated by Contractor and approved by Engineer.

**STANDARD GRADING, EROSION, AND STORMWATER QUALITY CONTROL NOTES**

- Any land disturbance by any owner/developer, builder, contractor, or other person shall comply with the Basic Grading, Erosion and Stormwater Quality Control Requirements and General Provisions noted in the Drainage Criteria Manual Volume II.
- No clearing, grading, excavation, filling, or other land disturbing activities shall be permitted until sign-off and acceptance of the Grading Plan and Erosion and Stormwater Quality Control Plan is received from City Engineering.
- The installation of the first level of temporary erosion control facilities and BMP's shall be installed and inspected prior to any earth disturbance operations taking place. Call City Stormwater Inspections, 385-5980, 48 hours prior to construction.
- Sediment (mud and dirt) transported onto a public road, regardless of the size of the site, shall be cleaned immediately.
- Concrete wash water shall not be discharged to or allowed to runoff to State Waters, including any surface or subsurface storm drainage system or facilities.
- Soil erosion control measures for slopes, channels, ditches, or any disturbed land area shall be completed within twenty-one (21) calendar days after final grading or final earth disturbance has been completed. Disturbed areas and stockpiles which are not at final grade but will remain dormant for longer than 30 days shall also be mulched within 21 days after interim grading. An area that is going to remain in an interim state for more than 60 days shall also be seeded. All temporary soil erosion control measures and BMP's shall be maintained until permanent soil erosion control measures are implemented.
- The grading and erosion control plan will be subject to re-review and re-acceptance by the City of Colorado Springs Engineering should any of the following occur: grading does not commence within 12 months of the City Engineer's acceptance of the plan, a change in property ownership, proposed development changes, or proposed grading revisions.
- The Plan shall not change the depth of cover, or access to utility lines. Acceptance of this plan does not constitute approval to grade in any utility easement or right-of-way. Approvals to grade with utility easements must be obtained from the appropriate utility company. It is not permissible for any person to modify the grade of the earth on any Colorado Springs Utilities easement or right-of-way without their written approval. The Plan shall not increase or divert water towards utility facilities. Any changes to utility facilities to accommodate the plan must be approved by the affected utility owner prior to implementing the plan. The cost to relocate or protect utilities or to provide interim access is the applicant's expense.

**DESCRIPTION OF CONSTRUCTION ACTIVITIES**

Anticipated starting and completion time period of site grading:

Expected date on which the final stabilization will be completed:

Area-Total area of the site to be cleared, excavated, or graded:

Receiving Water-Name of receiving water:

**SIGNATURE BLOCKS**

**ENGINEER'S STATEMENT**

This Erosion and Stormwater Quality Control/Grading Plan was prepared under my direction and supervision and is correct to the best of my knowledge and belief. If such work is performed in accordance with the grading and erosion control plan, the work will not become a hazard to life and limb, endanger property, or adversely affect the safety, use, or stability of a public way, drainage channel, or other property.

Signature: \_\_\_\_\_ Date: \_\_\_\_\_  
 Printed Name: \_\_\_\_\_ Seal \_\_\_\_\_

**DEVELOPER'S STATEMENT**

The owner hereby certifies that the Erosion and Stormwater Quality Control Plan including temporary BMP construction requirements and final stabilization requirements, I acknowledge the responsibility to determine whether the construction activities on these plans require Colorado Discharge Permit System (CDPS) permitting for Stormwater.

Developer/Owner Signature: \_\_\_\_\_  
 Name of Developer/Owner: \_\_\_\_\_ Date: \_\_\_\_\_  
 DBA: \_\_\_\_\_ Phone: \_\_\_\_\_  
 Title: \_\_\_\_\_ Email: \_\_\_\_\_  
 Address: \_\_\_\_\_ Fax: \_\_\_\_\_

**CITY OF COLORADO SPRINGS GRADING AND EROSION CONTROL REVIEW**

This grading plan is filed in accordance with section 7.7-1503 (enacted as ord. 85-56) of the code of the City of Colorado Springs, 2001, as amended. Erosion control is reviewed in accordance with the Drainage Criteria Manual, Vol. 1 (October 1994) and Vol. II (Aug. 2002); latest revisions.

For the City Engineer: \_\_\_\_\_ Date: \_\_\_\_\_

**FIGURE 4**


**General Notes for all Preliminary Utility Plans**

**Property Owner(s) acknowledge and agree to the following upon approval of Preliminary Utility Plan:**

- This drawing is a Preliminary Utility Plan and therefore, Colorado Springs Utilities shall make the final determination of the location of all water, wastewater, electric, and gas facilities, which may not be the same location as shown on this Preliminary Utility Plan.
- Property Owner(s) ("Owner") acknowledge that the connection and/or extension of utility services to the proposed building in this Preliminary Utility Plan ("Proposed") shall be in accordance with all applicable codes and regulations, Colorado Springs Utilities' Rules Extension and Service Standards ("Standards"), tariffs, rules, regulations and policies, City ordinances, resolutions, and policies, and Pikes Peak Regional Building Department codes, in effect at the time of utility service connection and/or extension.
- Owner acknowledges responsibility for the costs of extensions or utility system improvements that Springs Utilities determines necessary to provide utility services to the Property or to ensure timely development of integrated utility systems serving the Property and areas outside the Property including the costs to design, install, and maintain all underground utility lines, manholes, vaults, and appurtenances, and to provide the collection system facilities and appurtenances, and any water or wastewater services, in and within the Property. Owner may be eligible for a cost Recovery Agreement as provided in Utilities' Rules and Regulations.
- Colorado Springs Utilities' utility services are available on a "first-come, first-served" basis, and therefore no specific allocations or amounts of utility services, facilities, capacities or supplies are reserved for the Owner, and Springs Utilities makes no commitment as to the availability of any utility service until such time as permanent service is initiated.
- Only with the prior written approval by Springs Utilities, Owner may cause the relocation or alteration of any existing utility facilities within the Property at the Owner's sole cost and expense. If Springs Utilities determines that Owner's relocation or alteration requires new or updated assessments, Owner shall convey those assessments prior to relocating or altering the existing utility facilities.
- Owner, at its sole cost and expense, shall dedicate by plan and/or convey by recorded document, all property and easements that Springs Utilities determines are required for all utility system facilities necessary to serve the Property and areas outside the Property, including but not limited to easements granted by separate deed or recorded instrument, and Springs Utilities' cost Recovery Agreement form (or Executive Agreement form) without modification unless approved by Springs Utilities.
- The water distribution system facilities must meet Springs Utilities' criteria for water quality, reliability and pressure, including looping requirements (see Section 4.08 of Springs Utilities' Water Standards).
- Owner recognizes that the extension of water system facilities may affect the quality of water in Springs Utilities' water system. When water quality is affected, Owner acknowledges responsibility for any costs that Springs Utilities may incur to maintain or improve the water quality of the water system. Owner shall reimburse Springs Utilities for such Water-quality Maintenance Costs within thirty (30) days of receipt of an invoice for such costs.
- Owner must contact Springs Utilities Field Engineering to secure approval of gas-service-line pressures in excess of Springs Utilities' standard gas-system pressure, and the location of all meters and transformers. (Contact North Work Center 688-1985 or South Work Center 688-5584).
- It shall not be permissible for any person to modify the grade of the earth on any Springs Utilities easement or rights of way without the written approval of Springs Utilities (City Code 122.540).
- Colorado Springs Utilities' approval of this Preliminary Utility Plan shall not be construed as a limitation upon the authority of Springs Utilities to apply its Standards, and if there are any conflicts between any approved drawings and any provision of Standards or the City Code, then the Standards shall apply. Springs Utilities' approval of this Preliminary Utility Plan shall not be construed as a limitation upon the authority of the City or the Springs Utilities to adopt different ordinances, rules, regulations, resolutions, policies or codes which change any of the provisions of the Standards so long as these apply to the City generally and are in accord with the then-current tariffs, rules, regulations and policies of Springs Utilities.

**LEGEND**

- PROPERTY LINE
- EXISTING CURB & GUTTER
- ADJACENT PROPERTY LINE
- NEW CONCRETE CURB
- EXISTING WATERLINE
- EXISTING SANITARY SEWER LINE
- EXISTING STORM SEWER LINE
- PROPOSED SANITARY SEWER LINE
- PROPOSED WATER LINE

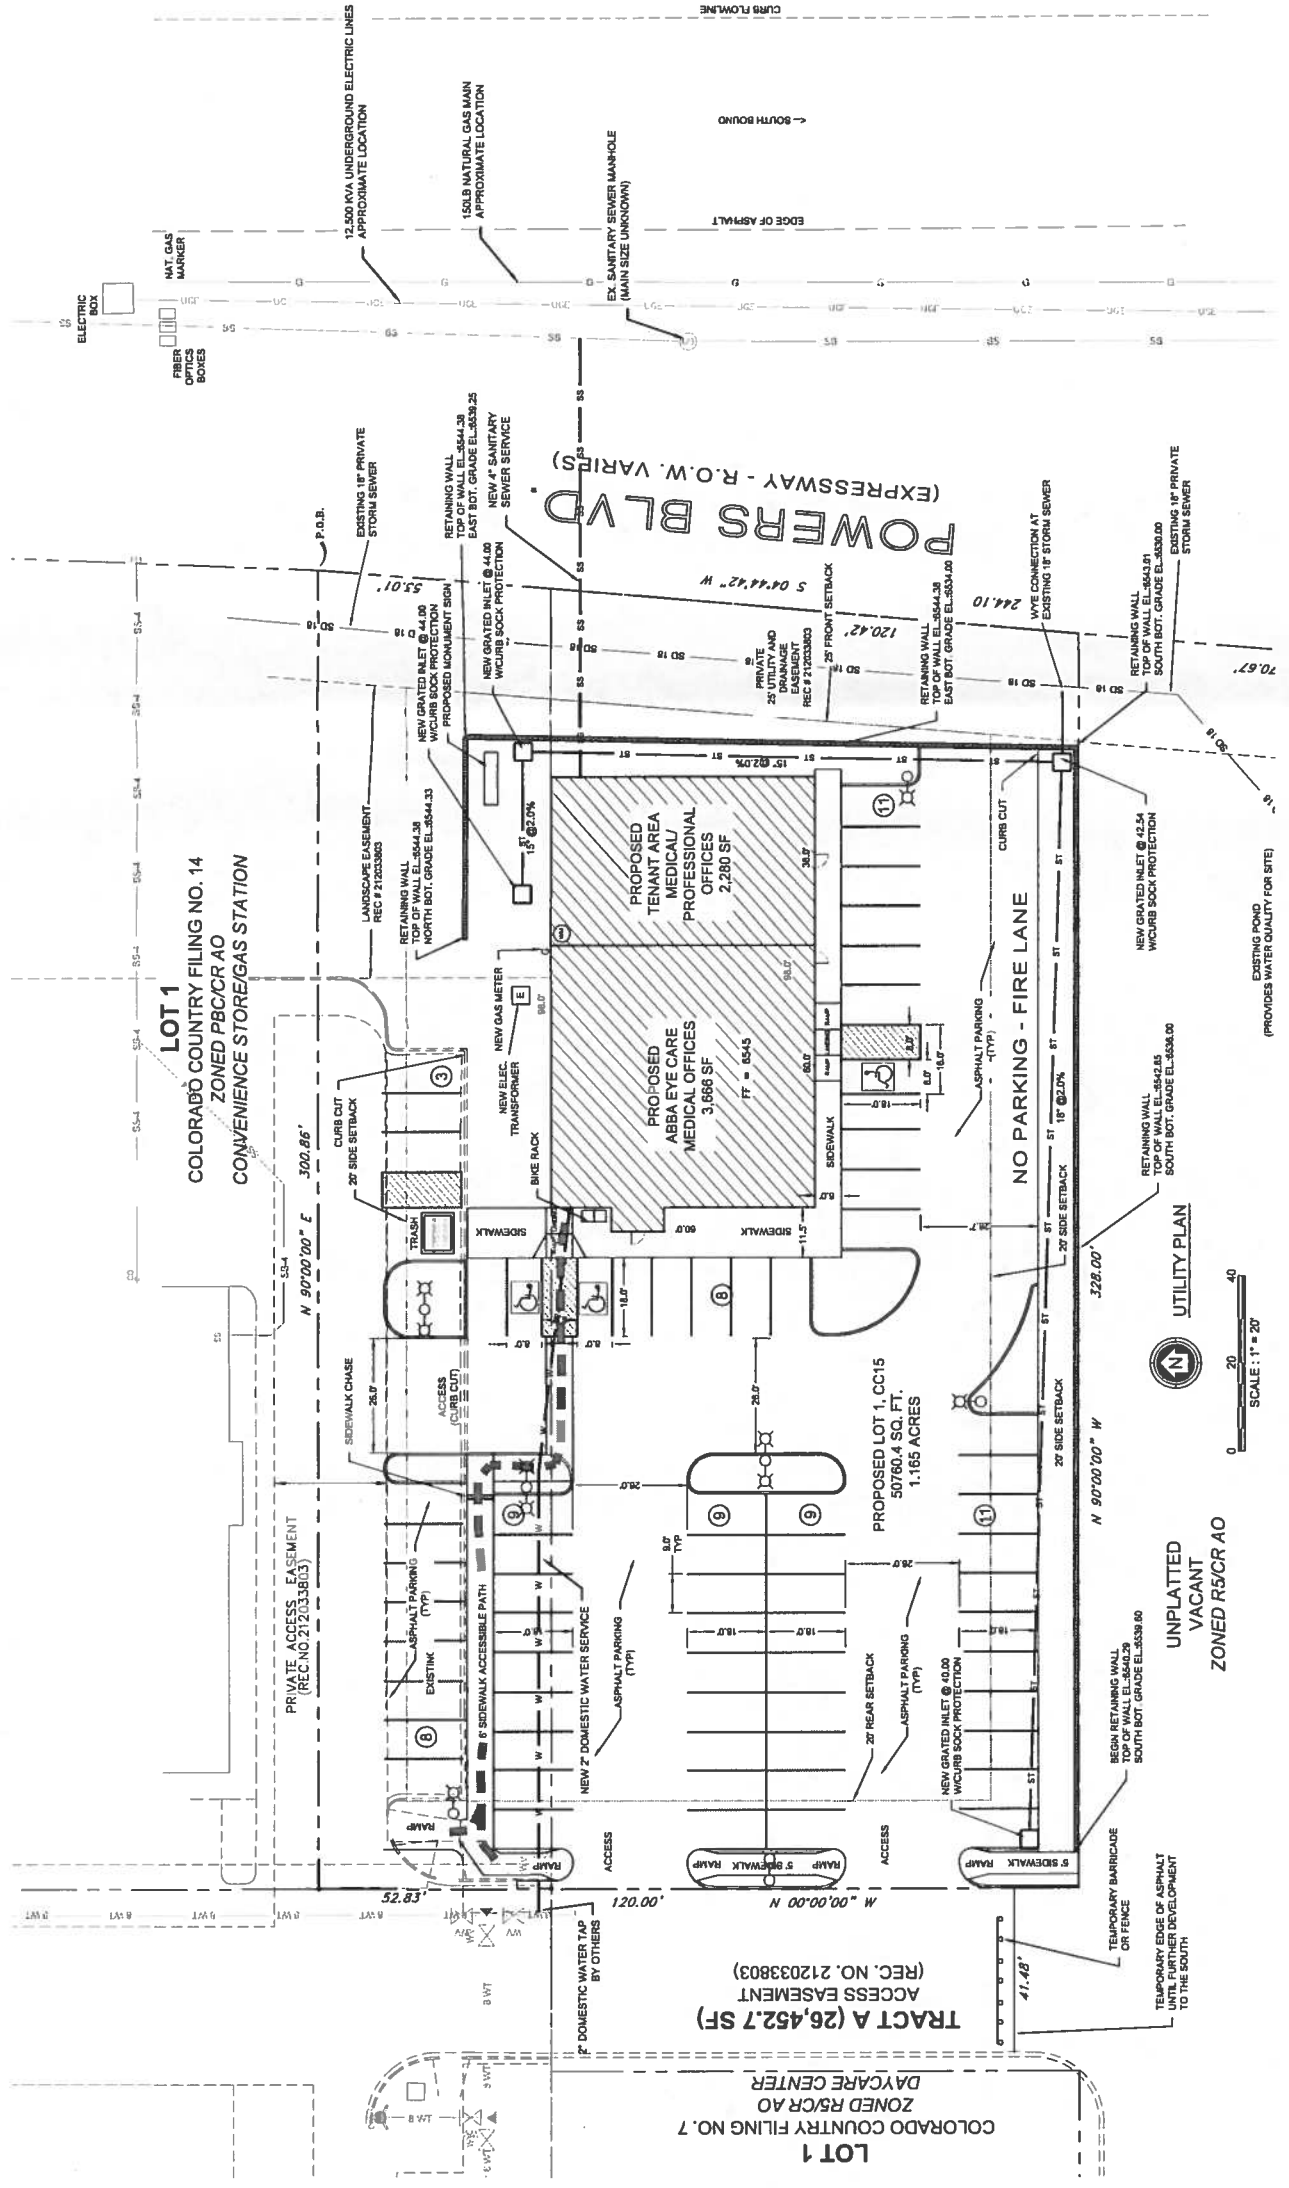

**GENERAL UTILITY NOTES:**

- All materials methods of construction, preparation, mixing, placement, finishing and testing shall conform to applicable sections of the City of Colorado Springs Utilities' Standard Construction Specifications and Standard Details. Latest edition in effect on the date of the invitation for bids, unless stated otherwise in the plans specification.
- Cuts in asphalt shall be clean, straight, vertical and shall be accomplished by saw cutting, use of a cutting wheel, or other method as approved by the City of Colorado Springs Utilities.
- The contractor shall be responsible for the disposal of all waste material including base, dirt, concrete, pavement, etc.
- The location of existing underground utilities are shown approximately and may not include all utilities. The excavation contractor shall determine the exact location of ALL existing utilities before commencing work. The contractor agrees to be fully responsible for any and all damages which might be occasioned by his failure to exactly locate and excavate any and all underground utilities. Utility Verification Center of Colorado 1-800-828-8887.
- Contractor shall provide a minimum of seven (7) days notice to the appropriate governing agency prior to commencing work.
- Water Mains and appurtenances shall be installed in accordance with Colorado Springs Utilities.
- The contractor shall adjust Water Valve Boxes as necessary and Sanitary Sewer Manhole rims using concrete grade rings.
- Dimensions are to face of curb unless otherwise specified.
- Elevations shown are finished grade unless otherwise specified.
- Clearcuts to be installed per current Plumbing Code as enforced by Colorado Springs Utilities.
- All Sanitary Sewer services and Fire Lines to be stubbed to within 5.00 feet of the building.
- Contractor shall coordinate the service line construction for the following utilities with the agencies listed below:

**SANITARY SEWER:**

- Contractor shall insure a minimum of 10' separation between water and sanitary sewer lines is maintained.
- The Contractor shall uncover the location of connections prior to beginning installation, to insure conformance with sizes, lines and grades shown on the plans. Any discrepancies shall be brought to the attention of the City Engineer, The Regional Building Department and the Engineer of Record as well, prior to proceeding.
- Sewer main connections made by the Contractor shall conform to applicable State Health Department separation and material requirements.
- All sewer mains shall have a minimum of four (4) feet of cover the top of the pipe, unless stated otherwise in the plans.
- All sanitary sewer/watermain crossings shall comply with the applicable State Health Department separation and material requirements.
- All work done without jurisdictional inspections shall be subject to removal and reinstallation at the Contractor's expense.
- All proposed manholes require Planter, Lock Down Rings and Covers, unless otherwise authorized by City of Colorado Springs Utilities.
- All proposed manholes are to be epoxy coated as required by City of Colorado Springs Utilities.

OTHER UTILITIES:  
 Colorado Springs Utilities  
 121 S TELON BLVD, Suite # 200  
 COLORADO SPRINGS, CO 80903-2187  
 (719) 448-4800

CABLE TV/DATA:  
 COMCAST  
 13 PULMONO BLVD  
 COLORADO SPRINGS, CO 80909  
 Vickroy Dr. Mesa 719-442-4137



**FIGURE 4**

**AR DP 16-00066**  
 Gagliano Engineering, Inc. - (719) 547-7073  
 P.O. Box 2520  
 Pueblo, CO 81008

**UTILITY & PUBLIC IMPROVEMENT PLAN**  
 ABBA, SUBJ. COLORADO SPRINGS CO 80901  
 ABBA EYE CARE  
 ABBA, ADDRESS

PROJECT NO.: 2016-006  
 DATE: 01/22/16  
 SCALE: as shown  
 DRAWN BY: JH  
 DATE: 06/16/16  
 CHECKED BY: JH  
 SHEET NO.: C-3

REV	Date	Comment

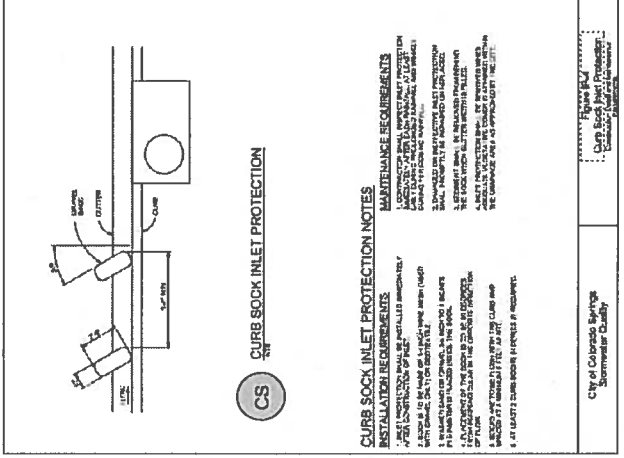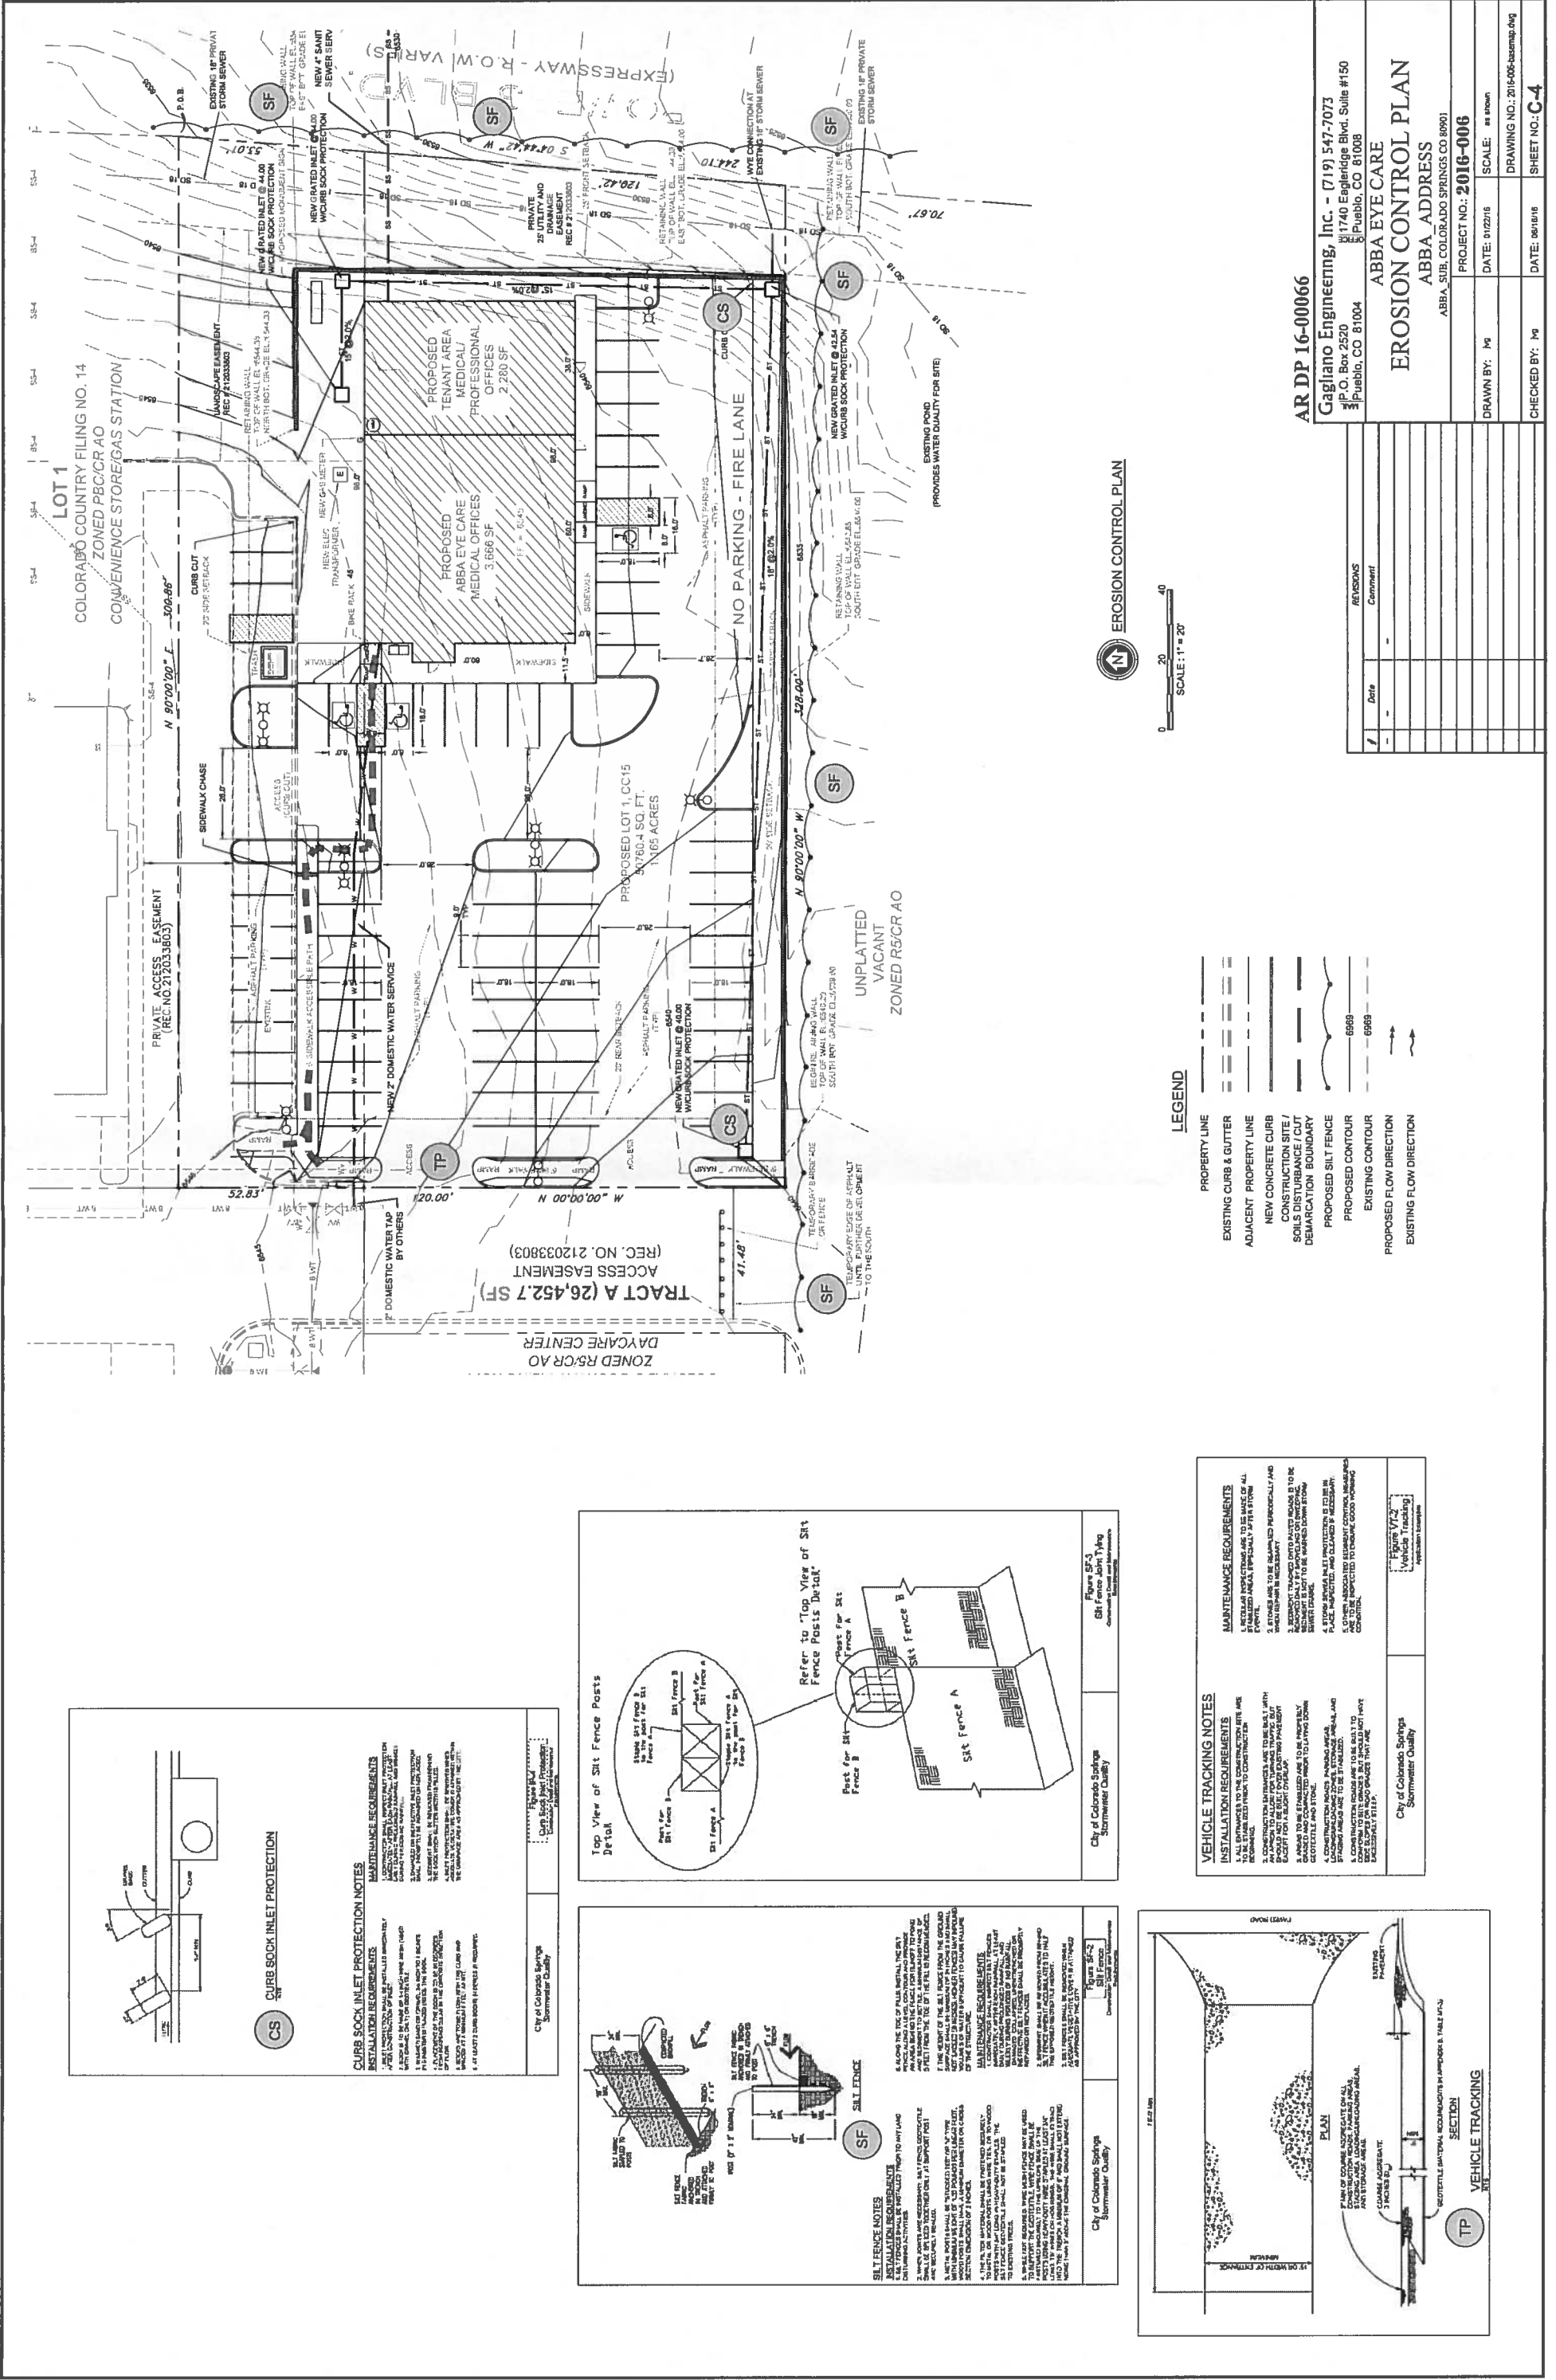





**CURB SOCK INLET PROTECTION NOTES**

**INSTALLATION REQUIREMENTS**


1. CURB SOCK SHALL BE INSTALLED AT THE POINT OF ENTRY TO THE CURB AND GUTTER.
2. CURB SOCK SHALL BE INSTALLED AT THE POINT OF ENTRY TO THE CURB AND GUTTER.
3. CURB SOCK SHALL BE INSTALLED AT THE POINT OF ENTRY TO THE CURB AND GUTTER.
4. CURB SOCK SHALL BE INSTALLED AT THE POINT OF ENTRY TO THE CURB AND GUTTER.
5. CURB SOCK SHALL BE INSTALLED AT THE POINT OF ENTRY TO THE CURB AND GUTTER.

**MAINTENANCE REQUIREMENTS**

1. CURB SOCK SHALL BE MAINTAINED AT ALL TIMES.
2. CURB SOCK SHALL BE MAINTAINED AT ALL TIMES.
3. CURB SOCK SHALL BE MAINTAINED AT ALL TIMES.
4. CURB SOCK SHALL BE MAINTAINED AT ALL TIMES.
5. CURB SOCK SHALL BE MAINTAINED AT ALL TIMES.

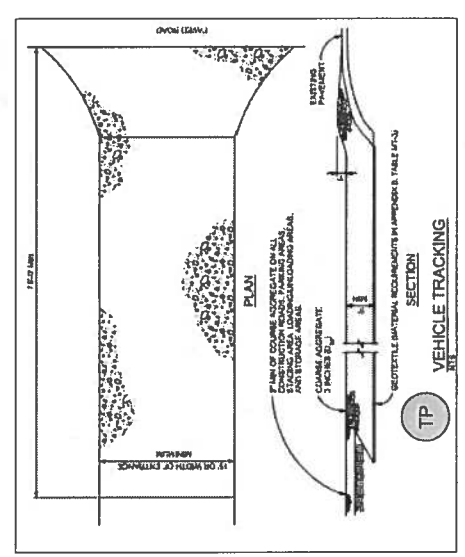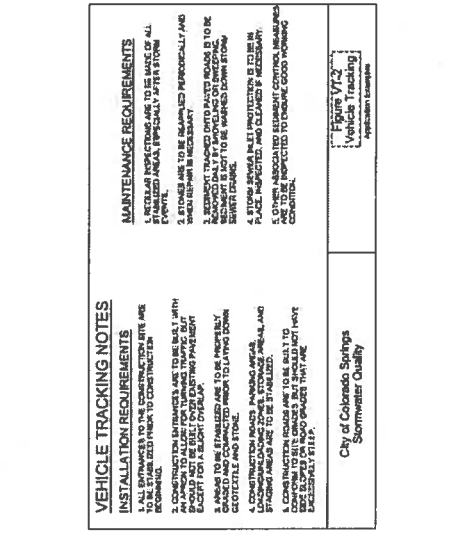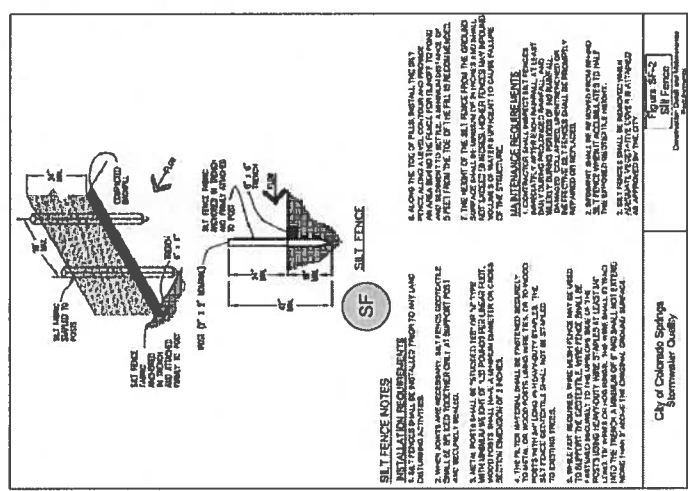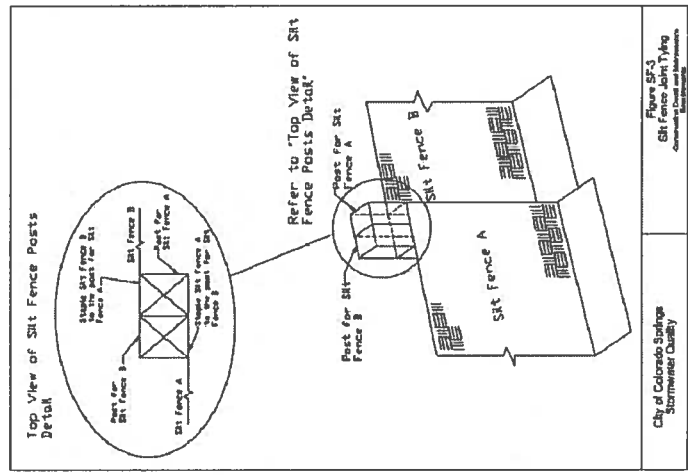

**FIGURE 4**

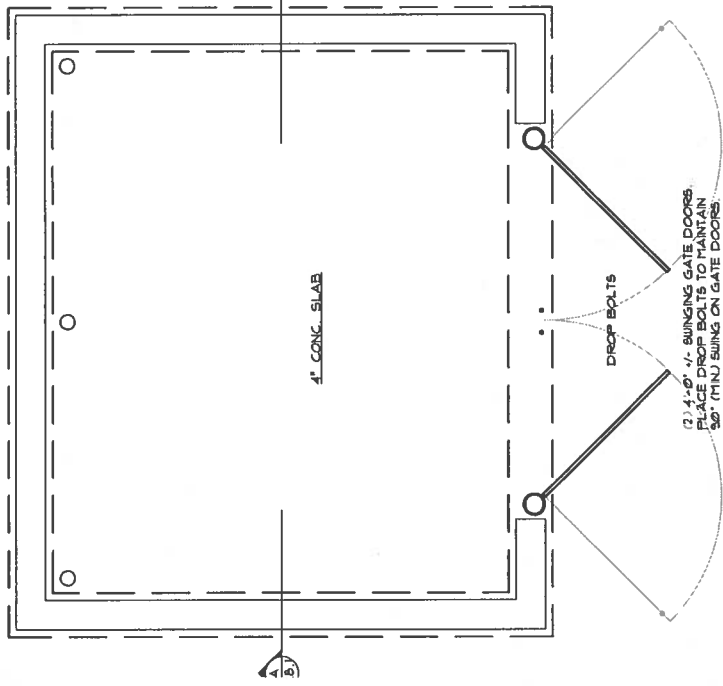


**1 TRASH ENCLOSURE**  
SCALE: 1/2" = 1'-0"

8" THICK CONCRETE  
BASE STUCCO TO MATCH  
MAIN BUILDING

(3) 4" \* CONCRETE  
FILLED STEEL  
BOLLARDS


FOUNDATION  
BELOW

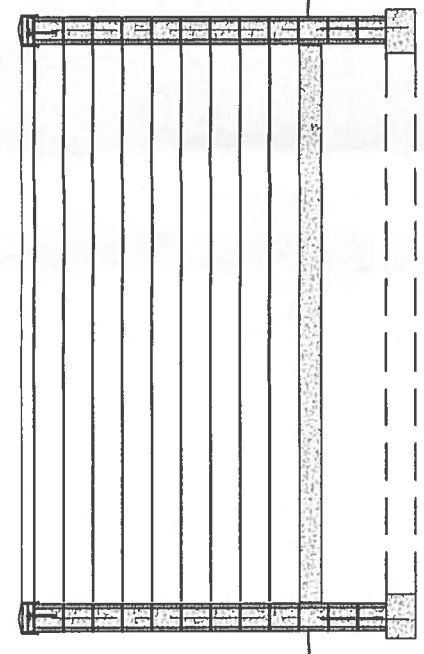

**2 SECTION 'A'**  
SCALE: 1/2" = 1'-0"

PRE-FABRICATED  
GALV. MTL. CAP


WOOD NAILER

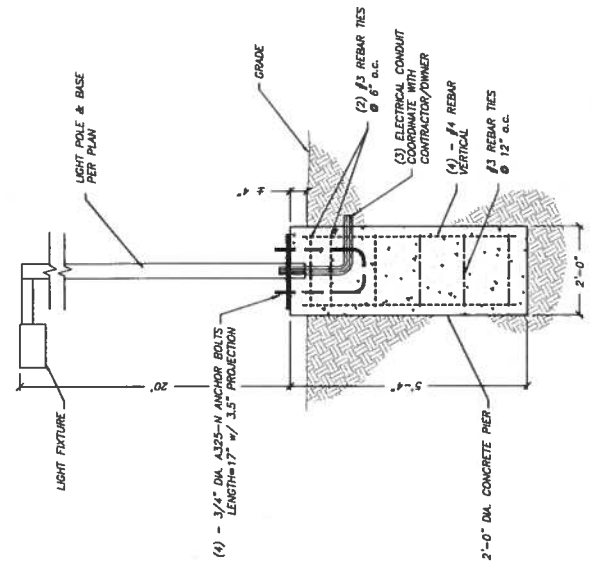


**LIGHT POLE FOUNDATION - SECTION VIEW**  
SCALE: 1/2" = 1'-0"

STUCCO COLOR #A  
PAINT CAP FLASHING  
TO MATCH STUCCO


LIGHT GAGE TUBE  
STEEL FRAME SHAPED  
AS SHOWN IN  
TEXTURED #20 T-11  
EXTERIOR GRADE  
SIDING SHAPED TO FIT  
FRONT OF ENCLOSURE  
BACK SIDE IN  
SELF-TAPPING SHEET  
METAL SCREWS +  
WASHERS  
PAINT METAL FRAME  
& BOLLARDS COLOR  
#E  
PAINT T-11  
SIDING COLOR  
#E

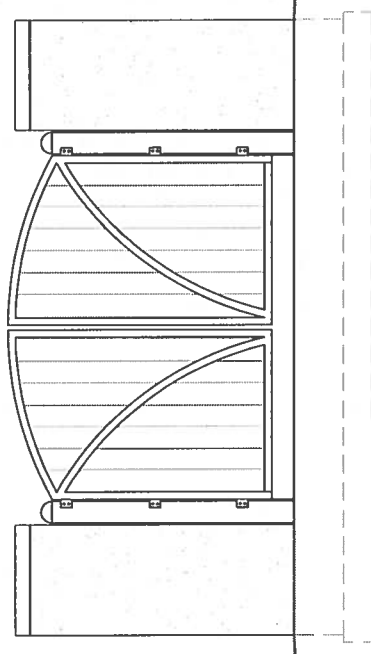


**3 FRONT ELEVATION**  
SCALE: 1/2" = 1'-0"

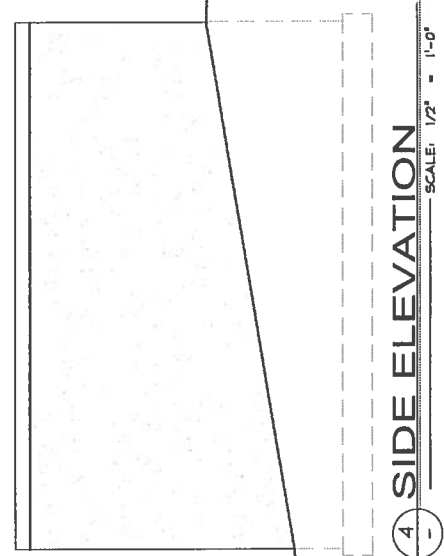

**4 SIDE ELEVATION**  
SCALE: 1/2" = 1'-0"

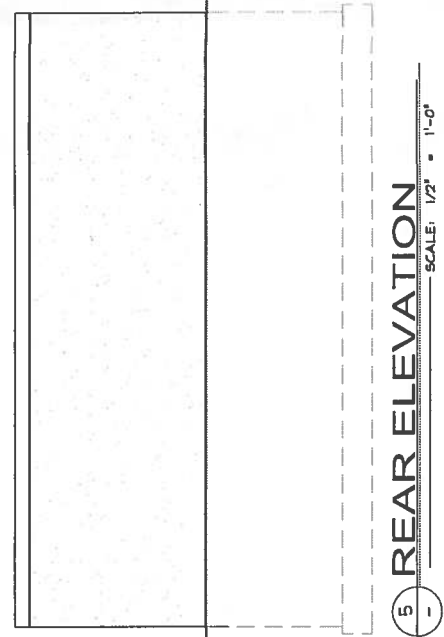


**5 REAR ELEVATION**  
SCALE: 1/2" = 1'-0"

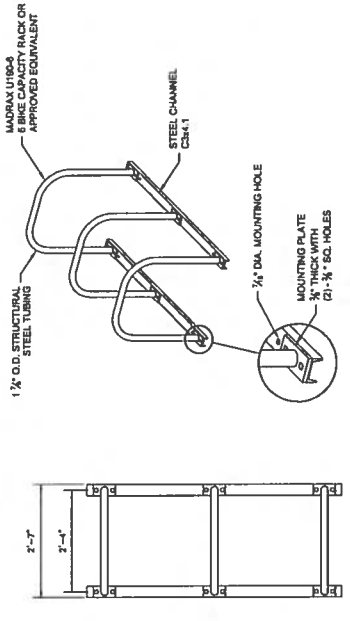

**BIKE RACK**  
(NOT TO SCALE)

NOTE:  
1. ALL BIKE RACKS ACCORDING TO MANUFACTURER SPECIFICATIONS.  
2. OWNER TO SELECT COLORFINISH. SEE MANUFACTURER'S SPECIFICATIONS.  
3. SEE SITE PLAN FOR LOCATION.

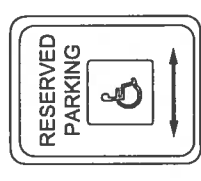

\* SIGN IS TO BE CENTERED  
BETWEEN 3.0' AND 5.0'  
ABOVE THE GROUND AT  
THE HEAD OF THE SPACE

\* SIGNS MAY BE MOUNTED  
ON A POLE OR  
A STRUCTURE

AR DP 16-00066

Gagliano Engineering, Inc. - (719) 547-7073  
81740 Engleidge Blvd. Suite #150  
P.O. Box 2520  
Pueblo, CO 81008

ABBA EYE CARE  
ABBA ADDRESS  
ABBA, SUB. COLORADO SPRINGS CO 80901

COVER SHEET & SITE PLAN

PROJECT NO.: 2016-006

DRAWN BY: JG SCALE: as shown

DATE: 01/22/16 DRAWING NO.: 2016-006-000

CHECKED BY: JG DATE: 06/16/16 SHEET NO.: C-5

Revisions	Date	Comment

**FIGURE 4**

**ALED4178**

**RAR**

Project:	Type:
Prepared By:	Date:

**Drive Info**

Type:	LED
Power:	100W
Beam Angle:	30°
Color Temp:	5000K
Life Span:	50,000 hrs
Efficiency:	100 lm/w

**Technical Specifications**

**Lighting:**  
 Suitable for use in a commercial building.  
 IESNA LM-79 & LM-80 Testing:  
 The LED luminaire has been tested by an IESNA member laboratory and is listed on the IESNA LM-79 & LM-80 and has received the Department of Energy's "Lighting Facts" label.

**Beam Spread:**  
 The beam spread is 30°.

**Color Rendering Index (CRI):**  
 The CRI is 90.

**Color Temperature:**  
 The color temperature is 5000K.

**Power Factor:**  
 The power factor is 0.95.

**Dimming:**  
 The luminaire is dimmable.

**Warranty:**  
 The luminaire is warranted for 5 years.

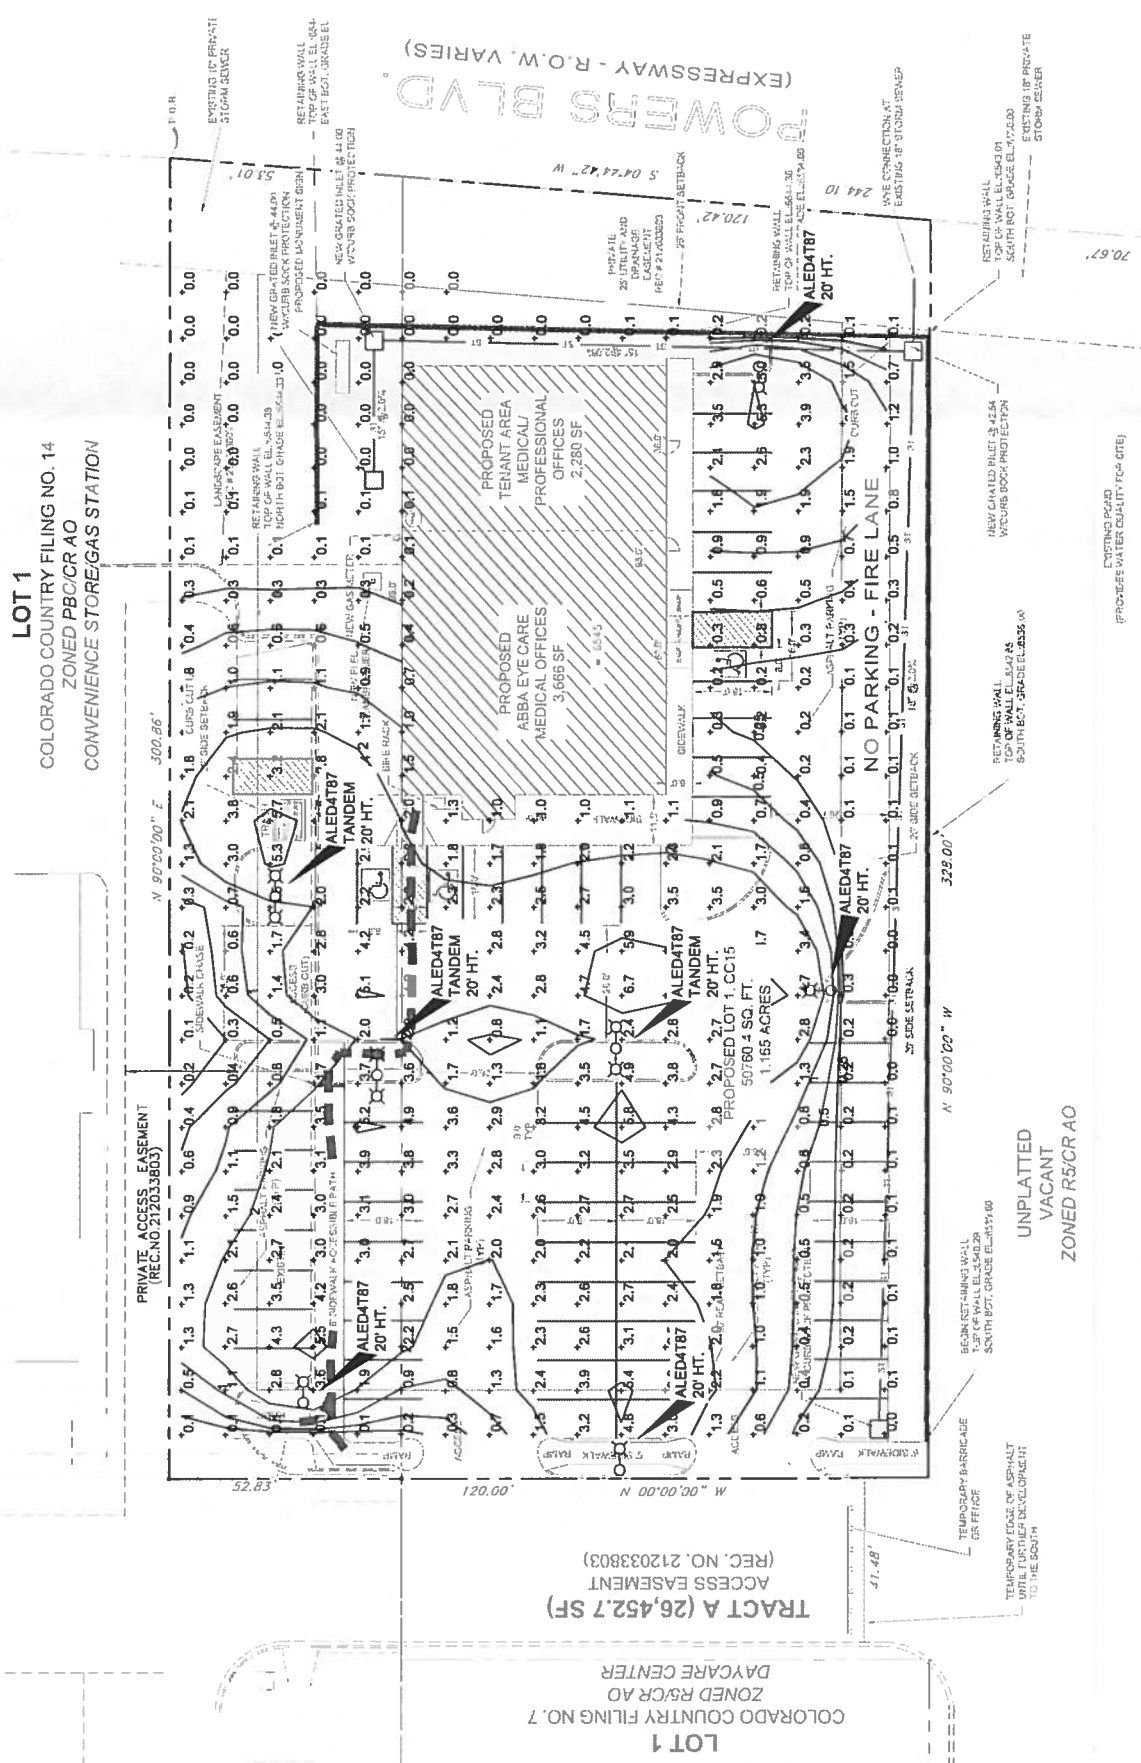



FIGURE 4

**AR DP 16-00066**

Gagliano Engineering, Inc. - (719) 547-7073  
 1740 Eagle Ridge Blvd., Suite #150  
 Pueblo, CO 81008

**ABBA EYE CARE**  
**PHOTOMETRIC PLAN**  
 ABBA ADDRESS  
 ABBA, SUB. COLORADO SPRINGS CO 80901

PROJECT NO.: 2016-006  
 DRAWN BY: Me  
 DATE: 01/22/16  
 SCALE: as shown  
 DRAWING NO.: 2016-006-photom.pwg  
 CHECKED BY: Jg  
 DATE: 06/18/16  
 SHEET NO.: C-6

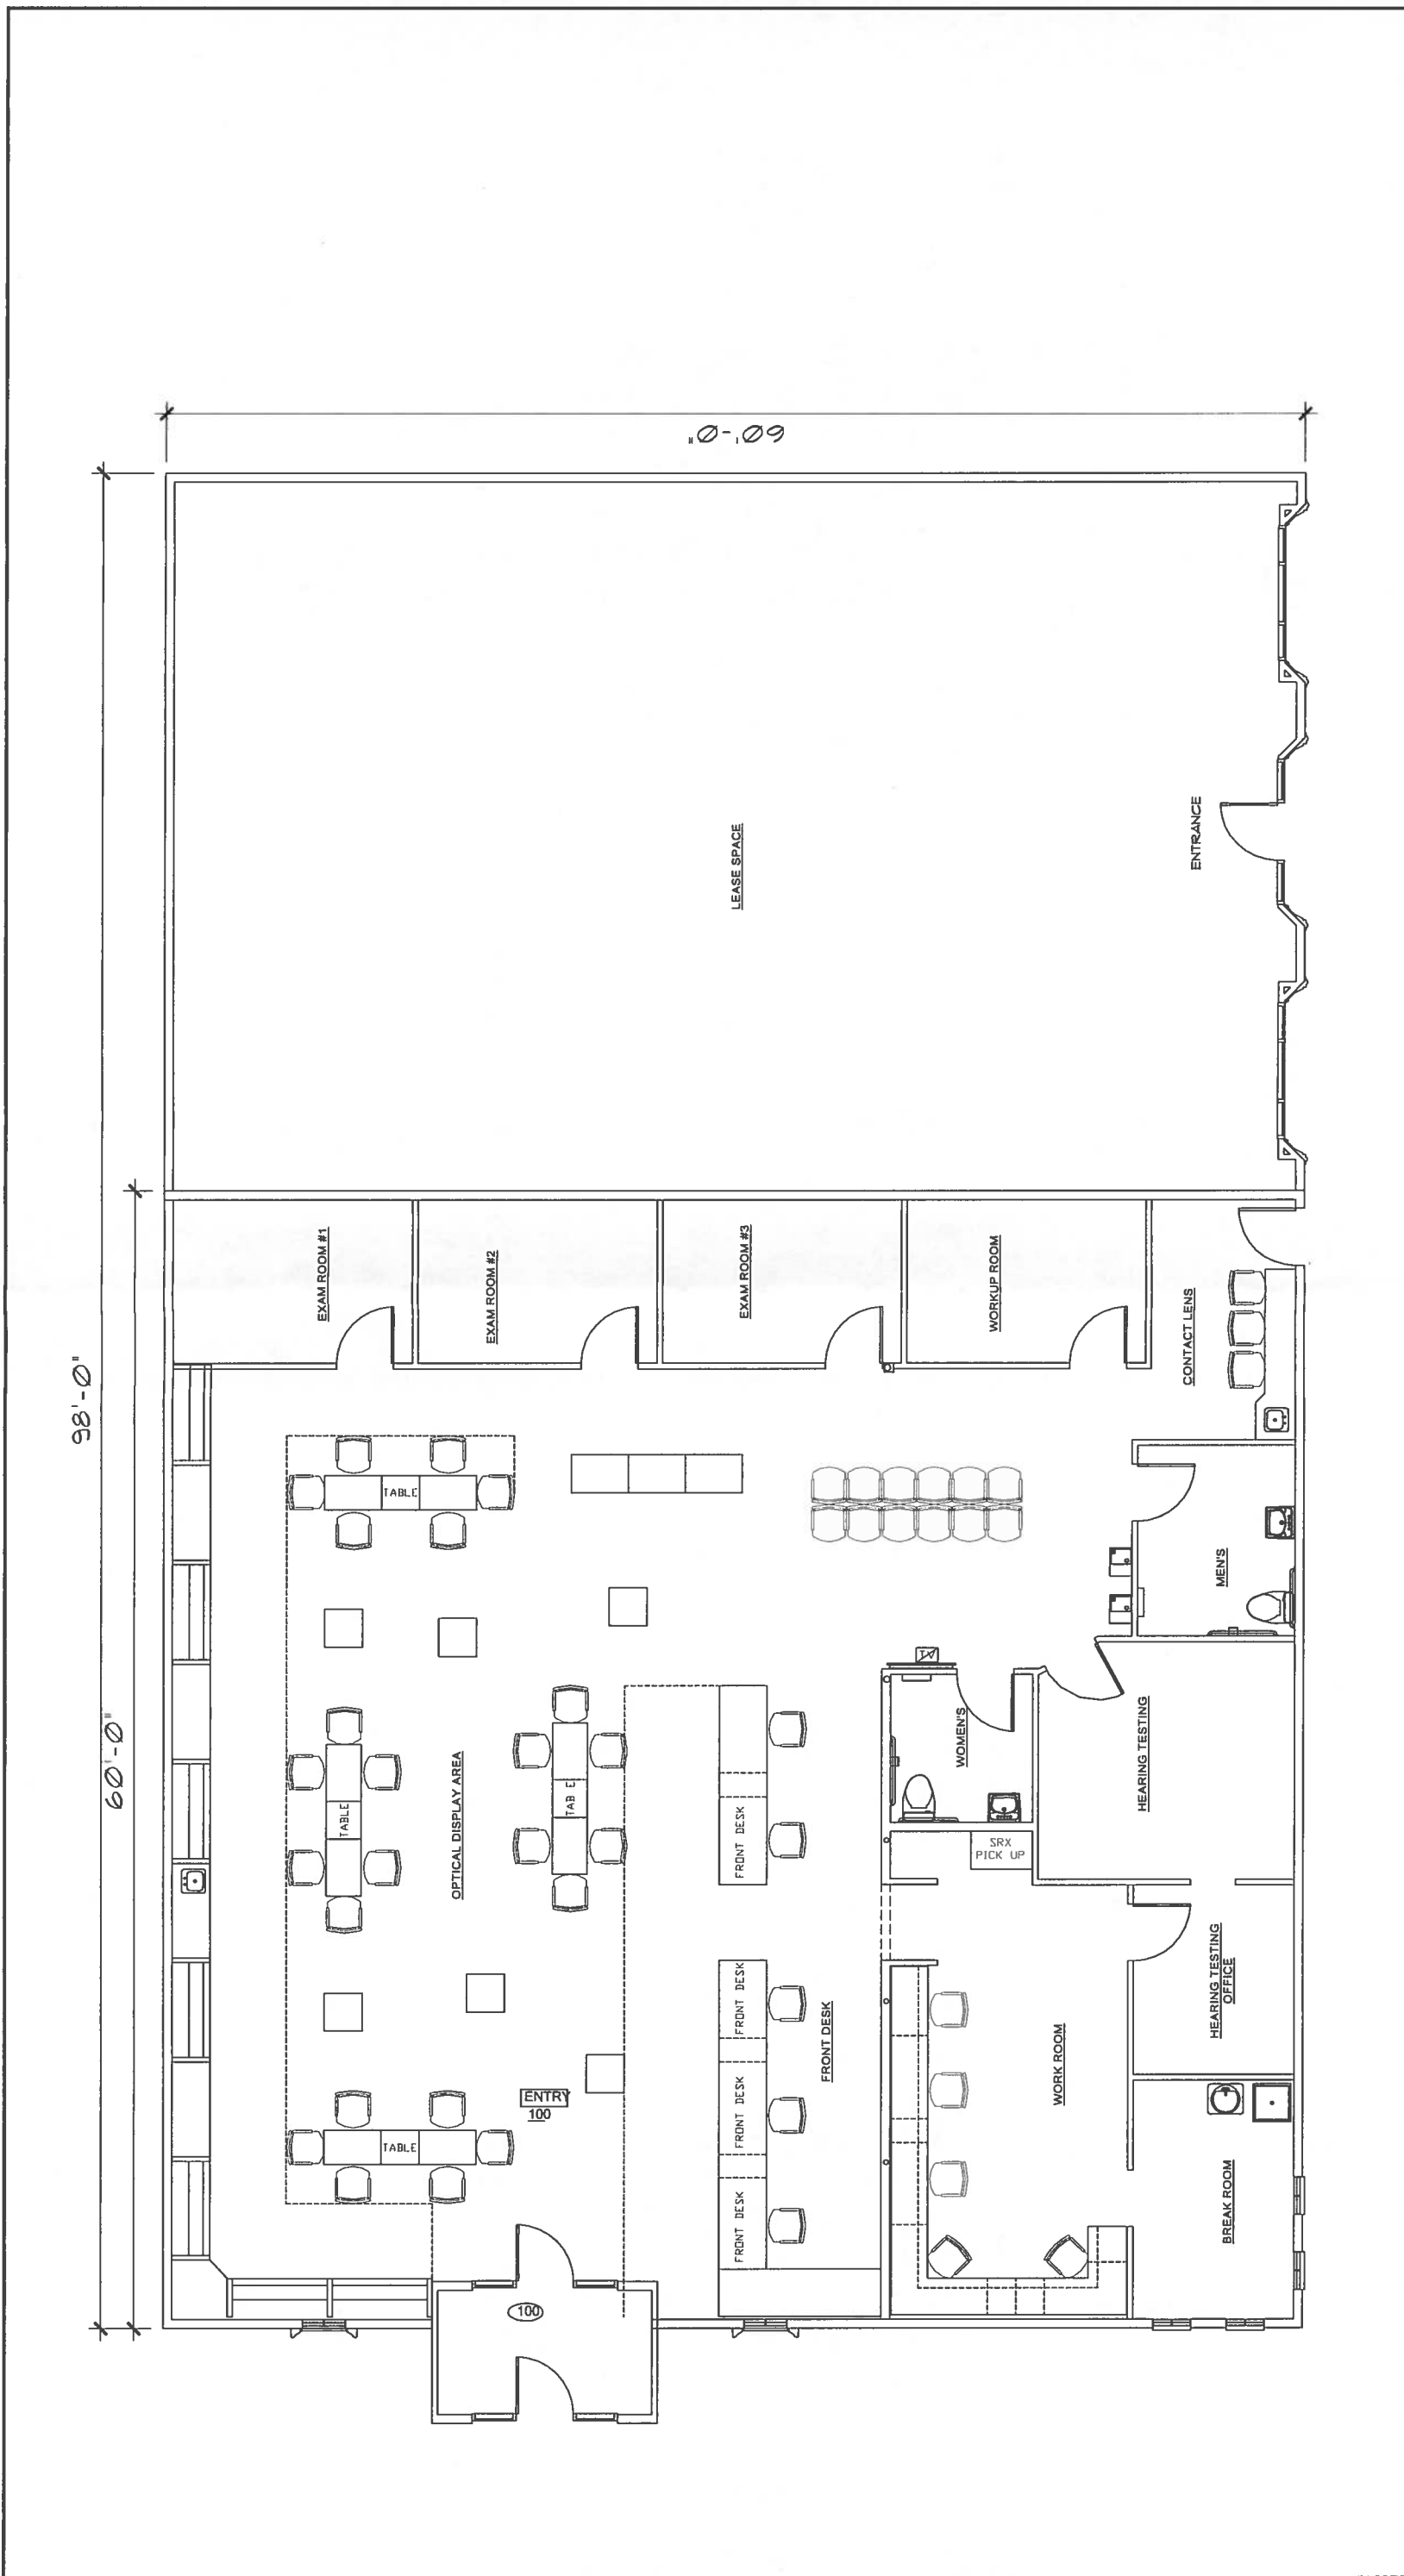

AR DP 16-00066

Gagliano Engineering, Inc. - (719) 547-7073  
 P.O. Box 2520  
 Pueblo, CO 81008

ABBA EYE CARE  
 DP FLOOR PLAN  
 ABBA ADDRESS  
 ABBA, SUBJ. COLORADO SPRINGS CO 80901

PROJECT NO.: 2016-006	DATE: 01/22/16	SCALE: as shown
DRAWN BY: JG	DATE: 08/18/15	DRAWING NO.: 2016-006-1600066.dwg
CHECKED BY: JG	DATE: 08/18/15	SHEET NO.: DP-A-1

FLOOR PLAN  
 SCALE: 1/4" = 1'-0"



FIGURE 4

