

FIGURE 1

STANDARD GRADING AND EROSION CONTROL PLAN NOTES

1. ALL GRADING SHALL BE IN ACCORDANCE WITH THE CITY OF COLORADO SPRINGS STANDARD SPECIFICATIONS FOR PUBLIC WORKS, LATEST EDITION, AND THE COLORADO DEPARTMENT OF TRANSPORTATION STANDARD SPECIFICATIONS FOR PUBLIC WORKS, LATEST EDITION.

2. ALL GRADING SHALL BE IN ACCORDANCE WITH THE CITY OF COLORADO SPRINGS STANDARD SPECIFICATIONS FOR PUBLIC WORKS, LATEST EDITION, AND THE COLORADO DEPARTMENT OF TRANSPORTATION STANDARD SPECIFICATIONS FOR PUBLIC WORKS, LATEST EDITION.

3. ALL GRADING SHALL BE IN ACCORDANCE WITH THE CITY OF COLORADO SPRINGS STANDARD SPECIFICATIONS FOR PUBLIC WORKS, LATEST EDITION, AND THE COLORADO DEPARTMENT OF TRANSPORTATION STANDARD SPECIFICATIONS FOR PUBLIC WORKS, LATEST EDITION.

4. ALL GRADING SHALL BE IN ACCORDANCE WITH THE CITY OF COLORADO SPRINGS STANDARD SPECIFICATIONS FOR PUBLIC WORKS, LATEST EDITION, AND THE COLORADO DEPARTMENT OF TRANSPORTATION STANDARD SPECIFICATIONS FOR PUBLIC WORKS, LATEST EDITION.

5. ALL GRADING SHALL BE IN ACCORDANCE WITH THE CITY OF COLORADO SPRINGS STANDARD SPECIFICATIONS FOR PUBLIC WORKS, LATEST EDITION, AND THE COLORADO DEPARTMENT OF TRANSPORTATION STANDARD SPECIFICATIONS FOR PUBLIC WORKS, LATEST EDITION.

EROSION CONTROL CRITERIA:

1. ALL GRADING SHALL BE IN ACCORDANCE WITH THE CITY OF COLORADO SPRINGS STANDARD SPECIFICATIONS FOR PUBLIC WORKS, LATEST EDITION, AND THE COLORADO DEPARTMENT OF TRANSPORTATION STANDARD SPECIFICATIONS FOR PUBLIC WORKS, LATEST EDITION.

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DEVELOPMENT PLAN NOTE:

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ADA STATEMENT:

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LEGEND:

- EXISTING CONTOUR (6770)
- PROPOSED CONTOUR (6770)
- BOUNDARY/FILING LINE
- EXISTING FLOW DIRECTION
- PROPOSED DRAINAGE FLOW DIRECTION
- PROPOSED INLET
- PROPOSED STORM PIPE
- EXISTING STORM PIPE
- PROPOSED LOW POINT
- EXISTING VEGETATION

SCALE: 1" = 30'

0 15 30 60

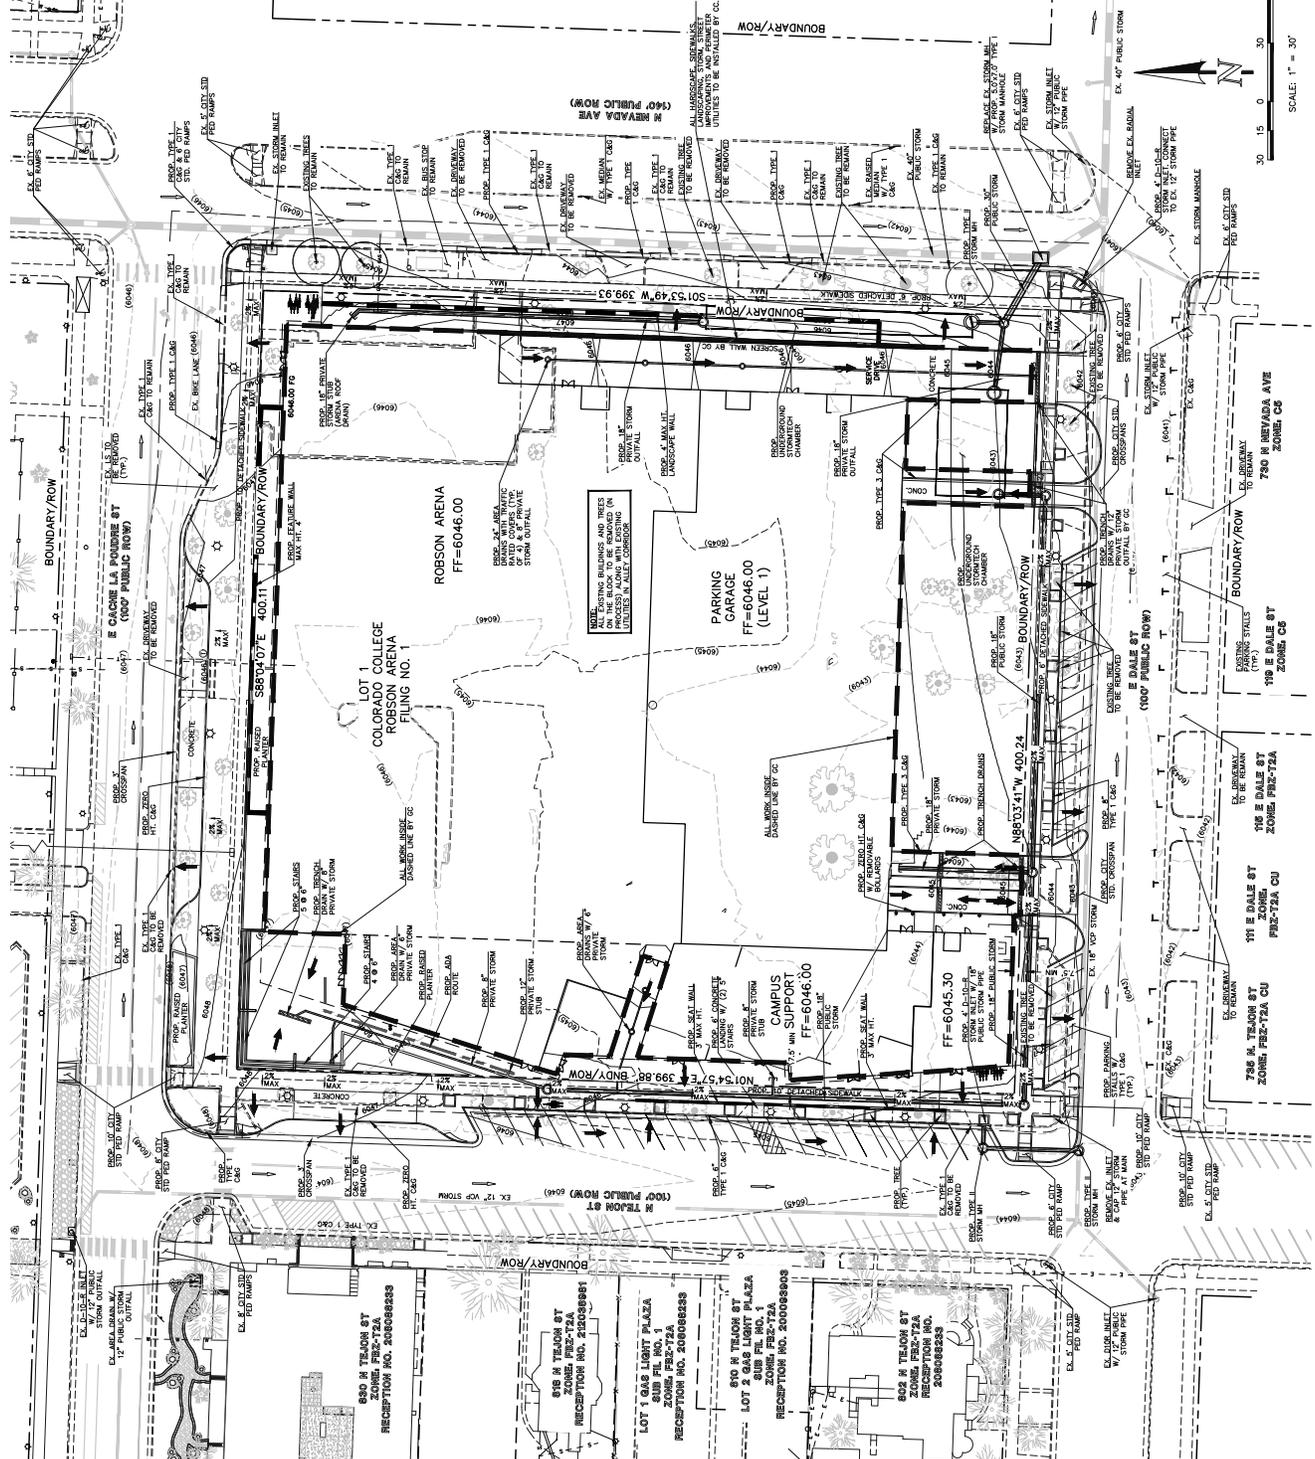


FIGURE 1

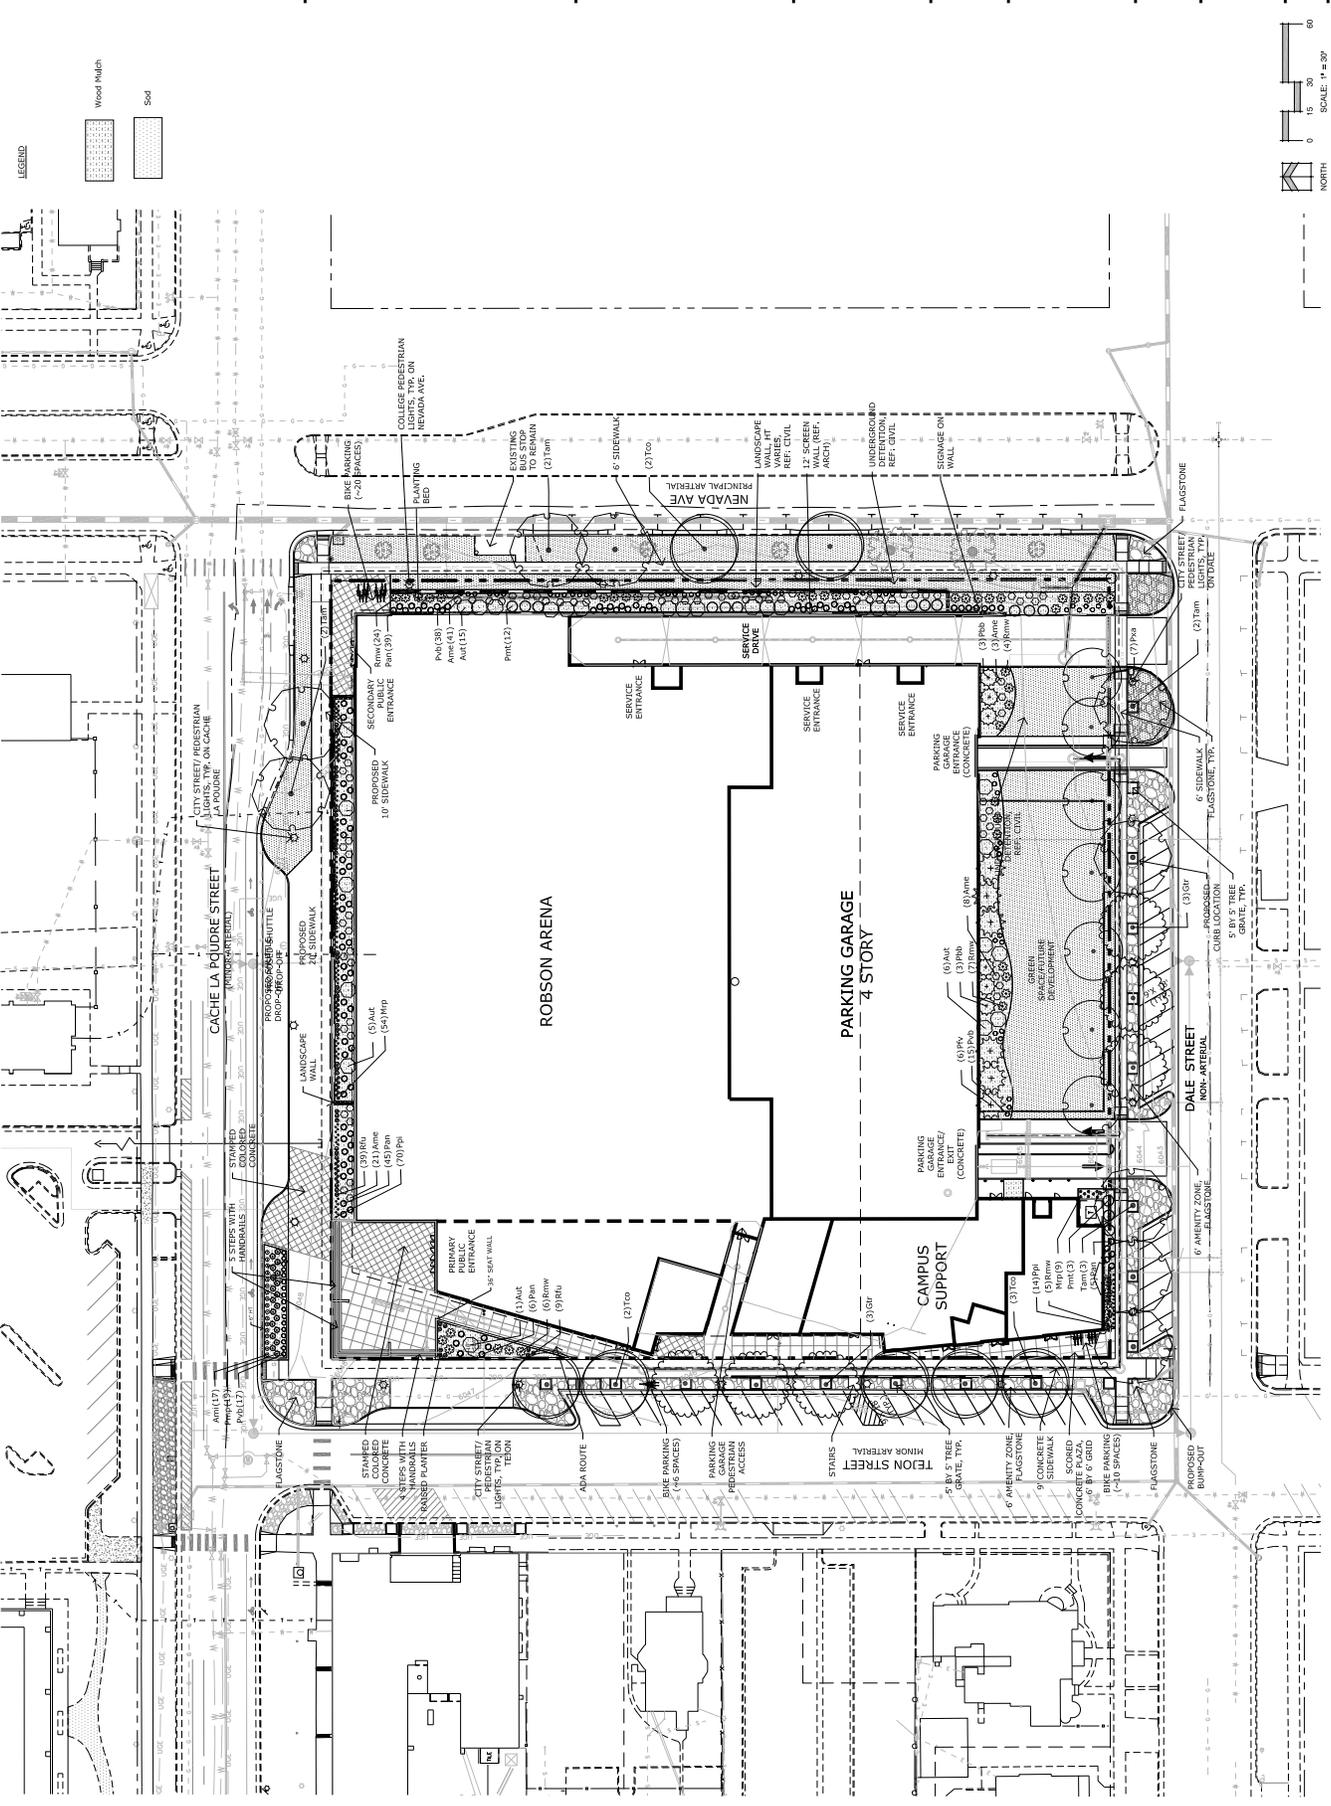


FIGURE 1



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 Fax 719-471-0267
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EDWARD J.
 ROBSON
 ARENA
 COLORADO COLLEGE
 PROJECT ADDRESS

DATE: 10.1.10
 PROJECT NO.: 100219
 DRAWING NO.: 100219-01

Development
 Plan

| DATE | BY | DESIGNER |
|---------|----|-------------------|
| 10.1.10 | BR | PER CITY COMMENTS |

TREE
 PRESERVATION
 PLAN

6 OF 15

CPC CU 19-00111


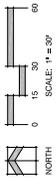




FIGURE 1

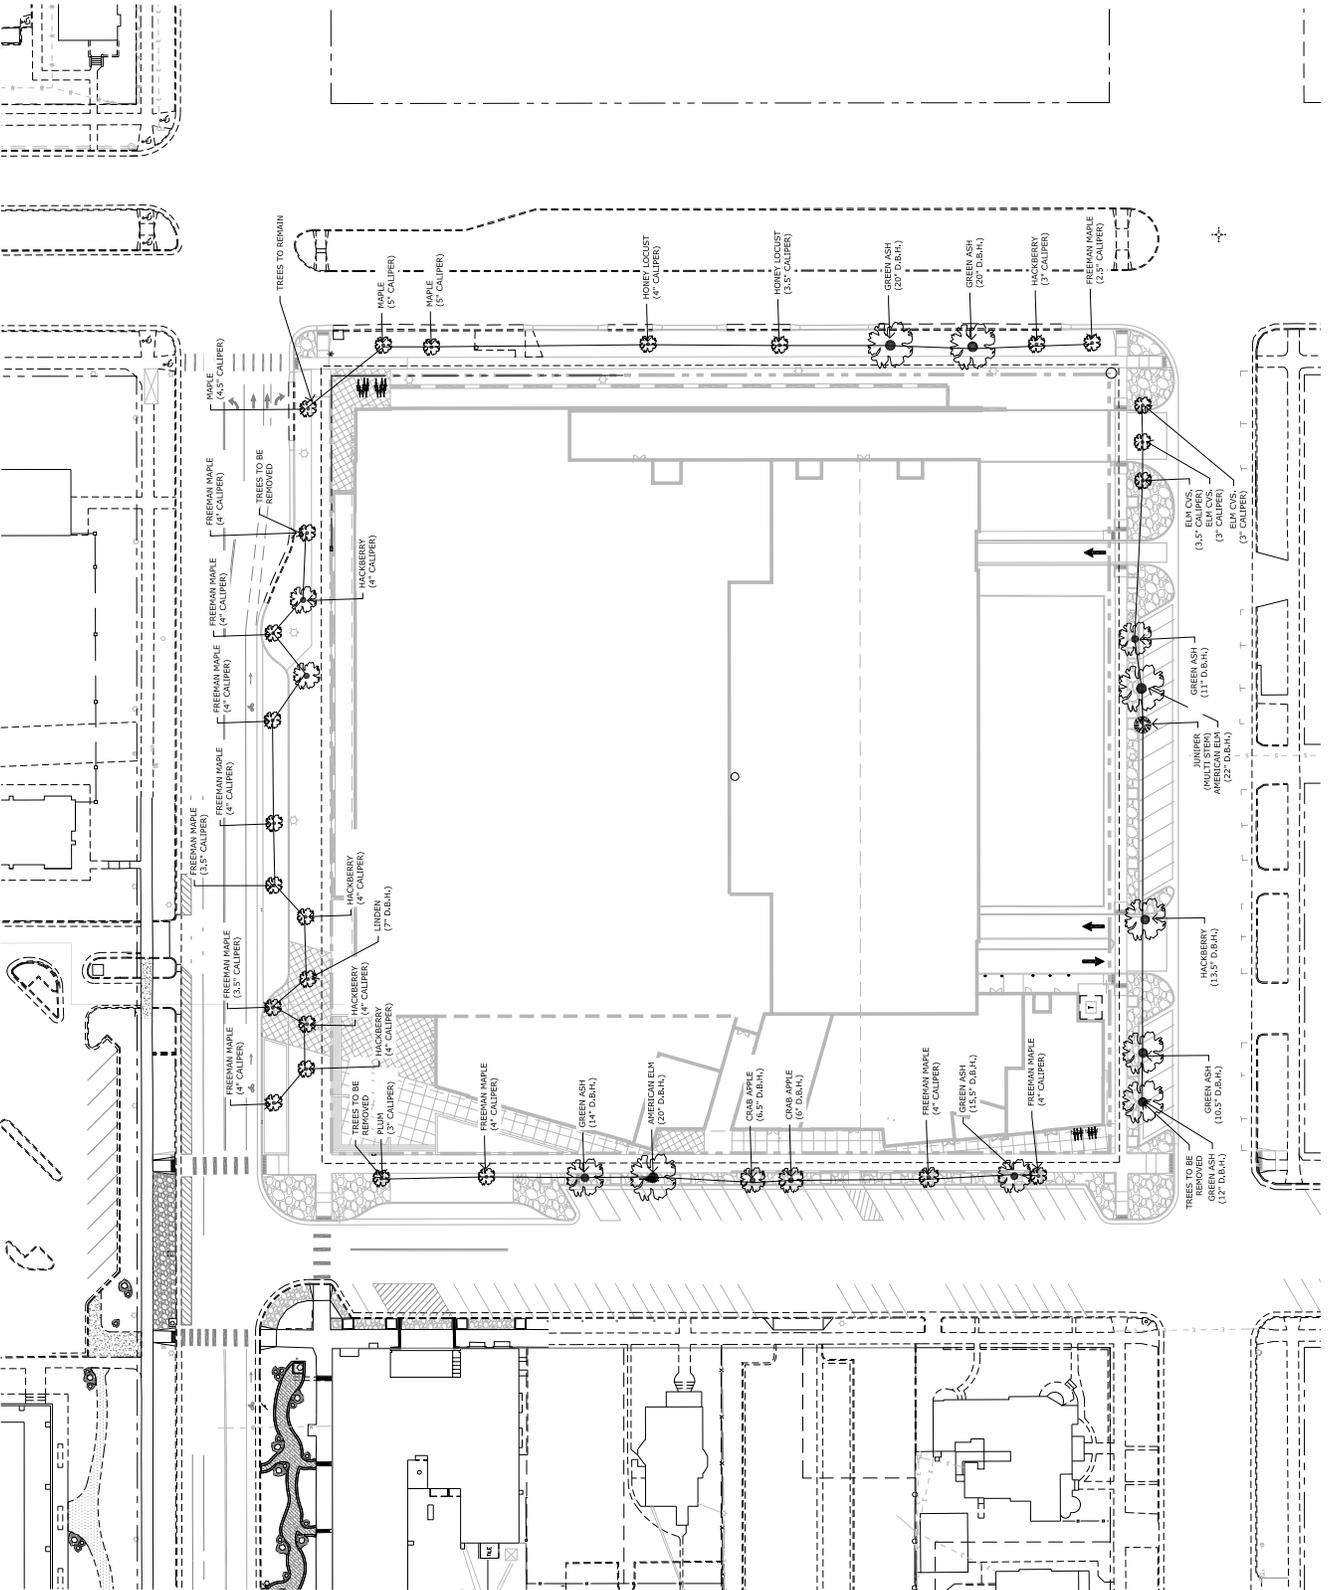Project: Colorado Springs Arena/Robson Arena/Colorado College/Edward J. Robson Arena/Tree Preservation Plan/10/2010 6/15/2010 10/2010



| EXTERIOR AREA COLORS | |
|----------------------|------------|
| 1 | CONCRETE |
| 2 | PAVING |
| 3 | WOOD |
| 4 | GLASS |
| 5 | STEEL |
| 6 | BRICK |
| 7 | STONE |
| 8 | ROOF |
| 9 | LANDSCAPE |
| 10 | VEGETATION |
| 11 | WATER |
| 12 | SKY |

| ELEVATION GLAZING PERCENTAGES | |
|-------------------------------|--------------------|
| 1 | GLAZING PERCENTAGE |
| 2 | GLAZING PERCENTAGE |
| 3 | GLAZING PERCENTAGE |
| 4 | GLAZING PERCENTAGE |
| 5 | GLAZING PERCENTAGE |
| 6 | GLAZING PERCENTAGE |
| 7 | GLAZING PERCENTAGE |
| 8 | GLAZING PERCENTAGE |
| 9 | GLAZING PERCENTAGE |
| 10 | GLAZING PERCENTAGE |
| 11 | GLAZING PERCENTAGE |
| 12 | GLAZING PERCENTAGE |

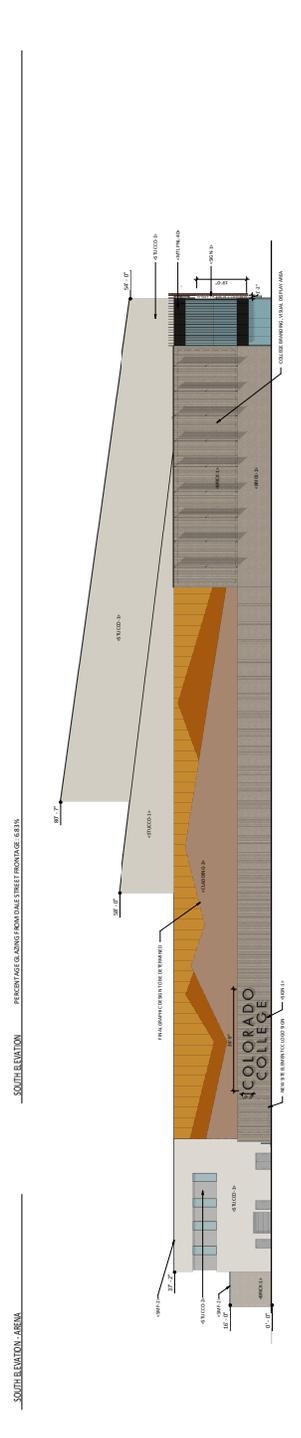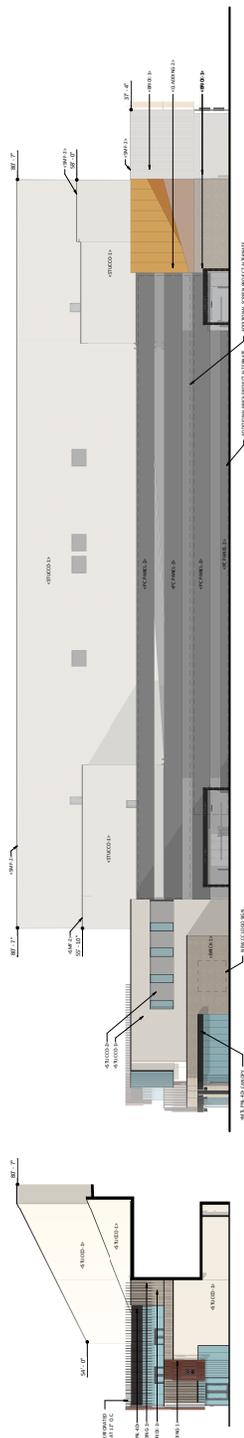

EDWARD J. ROBSON ARENA
 EXTERIOR ELEVATIONS
 10/07/19 | JLG-A425 | © 2019 JLG ARCHITECTS



FIGURE 1

**EDWARD J.
 ROBSON
 ARENA**
 COLORADO COLLEGE

DATE: 10/07/19
 PROJECT NO: 19-0001
 DRAWING NO: 19-0001-01

CITY SUBMITTAL
 (NOT FOR
 CONSTRUCTION)

DATE: 10/07/19
 BY: JLG

**BUILDING
 ELEVATIONS**

CPC #



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www.nescolorado.com
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EDWARD J.
ROBSON
ARENA
COLORADO COLLEGE

DATE: 10/07/19
PROJECT NO: 19-0001
PROJECT NAME: EDWARD J. ROBSON ARENA

CITY SUBMITTAL
(NOT FOR
CONSTRUCTION)


DATE: 10/07/19
BY: JLC/PR/ML

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ELEVATIONS


CPC #

| EXISTING BUILDING | |
|-------------------|-------------------|
| NO. 1 | EXISTING BUILDING |
| NO. 2 | EXISTING BUILDING |
| NO. 3 | EXISTING BUILDING |
| NO. 4 | EXISTING BUILDING |
| NO. 5 | EXISTING BUILDING |
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| NO. 47 | EXISTING BUILDING |
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| NO. 49 | EXISTING BUILDING |
| NO. 50 | EXISTING BUILDING |

| EXISTING FINISH ELEVATIONS | |
|----------------------------|---------------------------|
| NO. 1 | EXISTING FINISH ELEVATION |
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| NO. 3 | EXISTING FINISH ELEVATION |
| NO. 4 | EXISTING FINISH ELEVATION |
| NO. 5 | EXISTING FINISH ELEVATION |
| NO. 6 | EXISTING FINISH ELEVATION |
| NO. 7 | EXISTING FINISH ELEVATION |
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| NO. 28 | EXISTING FINISH ELEVATION |
| NO. 29 | EXISTING FINISH ELEVATION |
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| NO. 31 | EXISTING FINISH ELEVATION |
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| NO. 43 | EXISTING FINISH ELEVATION |
| NO. 44 | EXISTING FINISH ELEVATION |
| NO. 45 | EXISTING FINISH ELEVATION |
| NO. 46 | EXISTING FINISH ELEVATION |
| NO. 47 | EXISTING FINISH ELEVATION |
| NO. 48 | EXISTING FINISH ELEVATION |
| NO. 49 | EXISTING FINISH ELEVATION |
| NO. 50 | EXISTING FINISH ELEVATION |

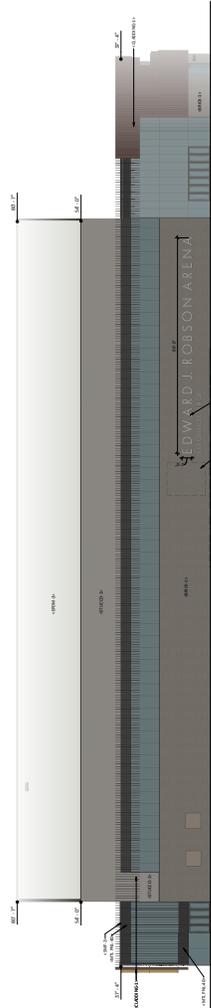

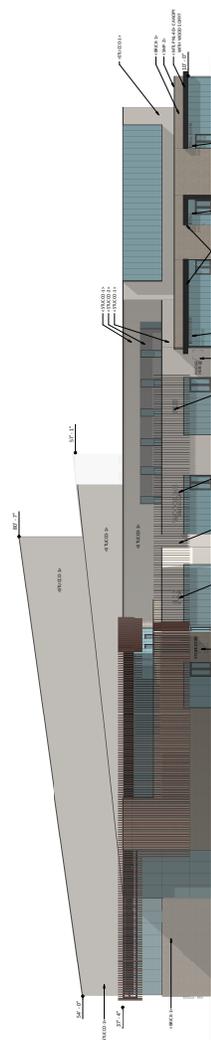NORTH ELEVATION - PERSPECTIVE DRAWING FROM GARDEN LA. HEIGHT LINE AT FRONTAGE. 48 BY 124.



WEST ELEVATION - PERSPECTIVE DRAWING FROM TOWN STREET FRONTAGE. 48 BY 124.

EDWARD J. ROBSON ARENA
EXTERIOR ELEVATIONS
10/07/19 | JLG-A425 | © 2019 JLG ARCHITECTS



FIGURE 1

| ENTITLEMENT SERVICE PLAN NOTES | |
|--------------------------------|---|
| 1. | THIS SERVICE PLAN IS A PRELIMINARY DESIGN AND IS SUBJECT TO CHANGE WITHOUT NOTICE. |
| 2. | THE DESIGNER HAS CONDUCTED VISUAL ANALYSIS AND HAS DETERMINED THAT THE PROPOSED PROJECT IS VISUALLY COMPATIBLE WITH THE SURROUNDING AREA. |
| 3. | THE DESIGNER HAS CONDUCTED VISUAL ANALYSIS AND HAS DETERMINED THAT THE PROPOSED PROJECT IS VISUALLY COMPATIBLE WITH THE SURROUNDING AREA. |
| 4. | THE DESIGNER HAS CONDUCTED VISUAL ANALYSIS AND HAS DETERMINED THAT THE PROPOSED PROJECT IS VISUALLY COMPATIBLE WITH THE SURROUNDING AREA. |
| 5. | THE DESIGNER HAS CONDUCTED VISUAL ANALYSIS AND HAS DETERMINED THAT THE PROPOSED PROJECT IS VISUALLY COMPATIBLE WITH THE SURROUNDING AREA. |
| 6. | THE DESIGNER HAS CONDUCTED VISUAL ANALYSIS AND HAS DETERMINED THAT THE PROPOSED PROJECT IS VISUALLY COMPATIBLE WITH THE SURROUNDING AREA. |
| 7. | THE DESIGNER HAS CONDUCTED VISUAL ANALYSIS AND HAS DETERMINED THAT THE PROPOSED PROJECT IS VISUALLY COMPATIBLE WITH THE SURROUNDING AREA. |
| 8. | THE DESIGNER HAS CONDUCTED VISUAL ANALYSIS AND HAS DETERMINED THAT THE PROPOSED PROJECT IS VISUALLY COMPATIBLE WITH THE SURROUNDING AREA. |
| 9. | THE DESIGNER HAS CONDUCTED VISUAL ANALYSIS AND HAS DETERMINED THAT THE PROPOSED PROJECT IS VISUALLY COMPATIBLE WITH THE SURROUNDING AREA. |
| 10. | THE DESIGNER HAS CONDUCTED VISUAL ANALYSIS AND HAS DETERMINED THAT THE PROPOSED PROJECT IS VISUALLY COMPATIBLE WITH THE SURROUNDING AREA. |

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EDWARD J. ROBSON ARENA
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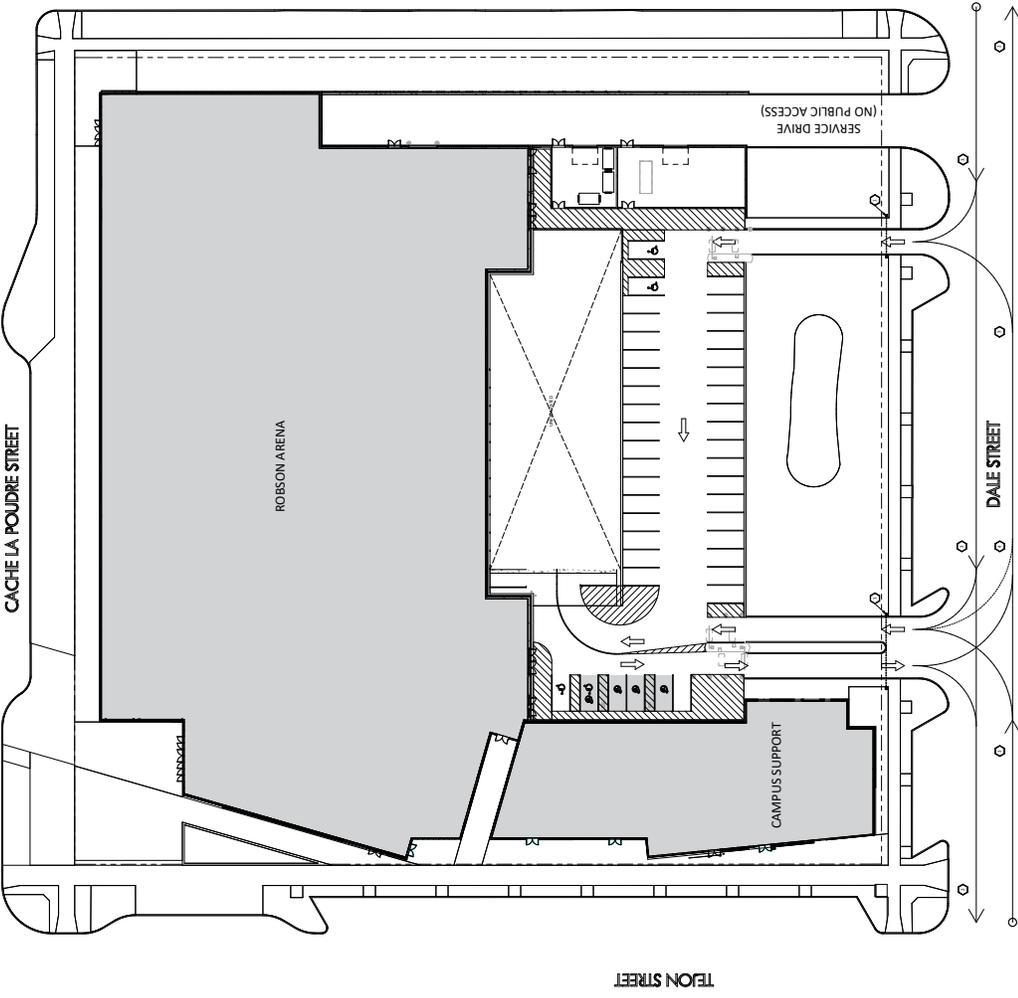
DATE: 10/07/19
 PROJECT NO: A-425
 PROVIDED BY:

CITY SUBMITTAL
 (NOT FOR CONSTRUCTION)

DATE: 10/07/19
 BY: JLG

BUILDING
 ELEVATIONS

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EDWARD J. ROBSON ARENA

SITE PLAN - PARKING RAMP FLOW

10/07/19 | JLG A-425 | © 2019 JLG ARCHITECTS



FIGURE 1

File:Colorado College\Robson Arena\SitePlan\SitePlan_10-07-19.rvt (12/27/2019 5:08:00 PM)



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EDWARD J. ROBSON ARENA
COLORADO COLLEGE

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PREPARED BY: JLG

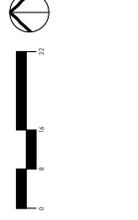
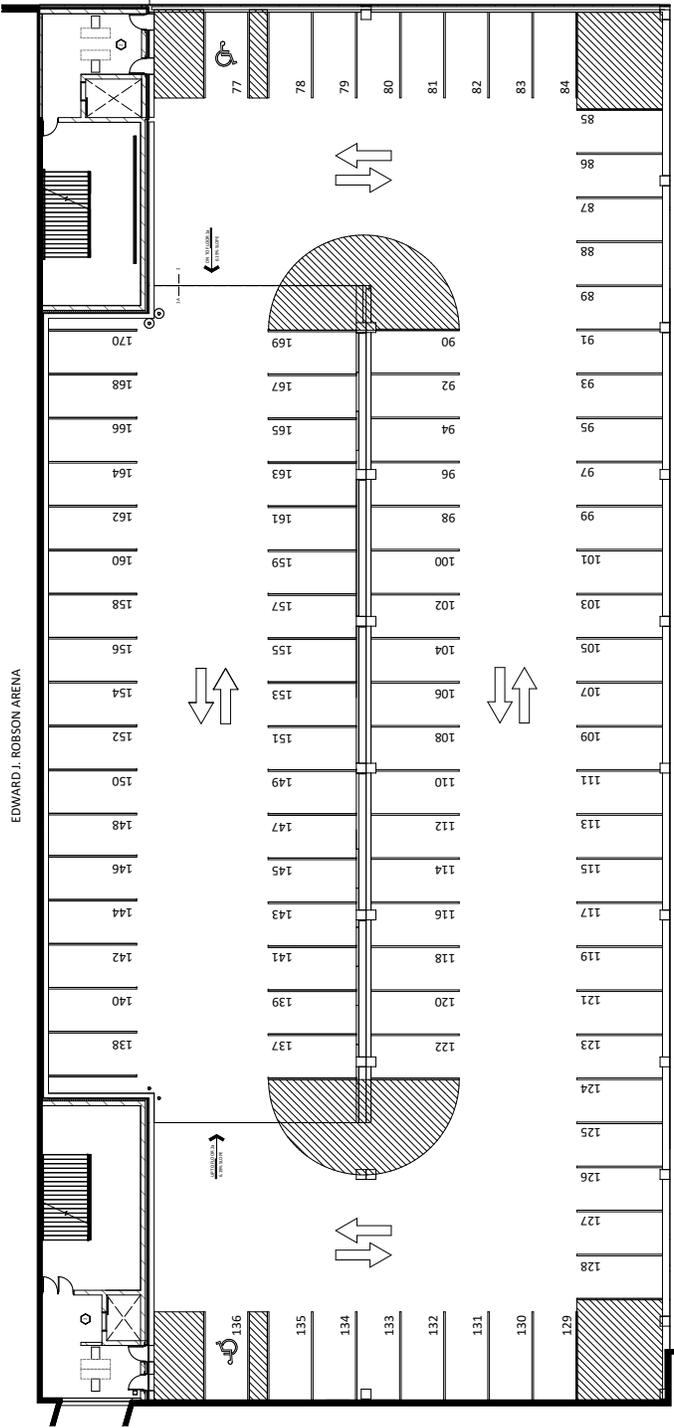
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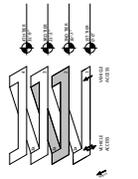
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1. THIS PLAN IS A PRELIMINARY DESIGN AND IS NOT TO BE USED FOR CONSTRUCTION.
2. ALL DIMENSIONS ARE IN FEET AND INCHES.
3. ALL DIMENSIONS ARE TO FACE UNLESS OTHERWISE NOTED.
4. ALL DIMENSIONS ARE TO FACE UNLESS OTHERWISE NOTED.
5. ALL DIMENSIONS ARE TO FACE UNLESS OTHERWISE NOTED.
6. ALL DIMENSIONS ARE TO FACE UNLESS OTHERWISE NOTED.
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8. ALL DIMENSIONS ARE TO FACE UNLESS OTHERWISE NOTED.
9. ALL DIMENSIONS ARE TO FACE UNLESS OTHERWISE NOTED.
10. ALL DIMENSIONS ARE TO FACE UNLESS OTHERWISE NOTED.



| PARKING COUNT | |
|---------------|-------|
| TYPE | COUNT |
| STANDARD | 170 |
| TOTAL | 170 |



EDWARD J. ROBSON ARENA
PARKING RAMP - SECOND LEVEL
10/03/19 | JLG A425 | © 2019 JLG ARCHITECTS



FIGURE 1



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COLORADO COLLEGE

DATE: 10/03/19
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PREPARED BY: JLG



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BUILDING ELEVATIONS

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2. ALL DIMENSIONS ARE TO FACE UNLESS OTHERWISE NOTED.
3. ALL FINISHES ARE TO BE DETERMINED BY THE ARCHITECT.
4. ALL MATERIALS AND METHODS OF CONSTRUCTION SHALL BE AS APPROVED BY THE ARCHITECT.
5. ALL WORK SHALL BE IN ACCORDANCE WITH THE CITY OF COLORADO SPRINGS SPECIFICATIONS AND STANDARDS.
6. ALL UTILITIES SHALL BE SHOWN TO THE DEPTH OF THE FOUNDATION.
7. ALL UTILITIES SHALL BE SHOWN TO THE DEPTH OF THE FOUNDATION.
8. ALL UTILITIES SHALL BE SHOWN TO THE DEPTH OF THE FOUNDATION.



JLG
DESIGN FOR LIFE

EDWARD J. ROBSON ARENA
PARKING RAMP - FOURTH LEVEL
10/03/19 | JLG A425 1 © 2019 JLG ARCHITECTS

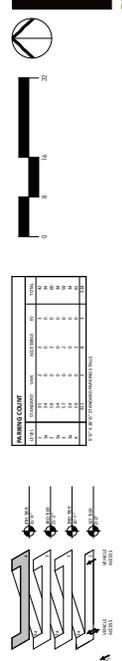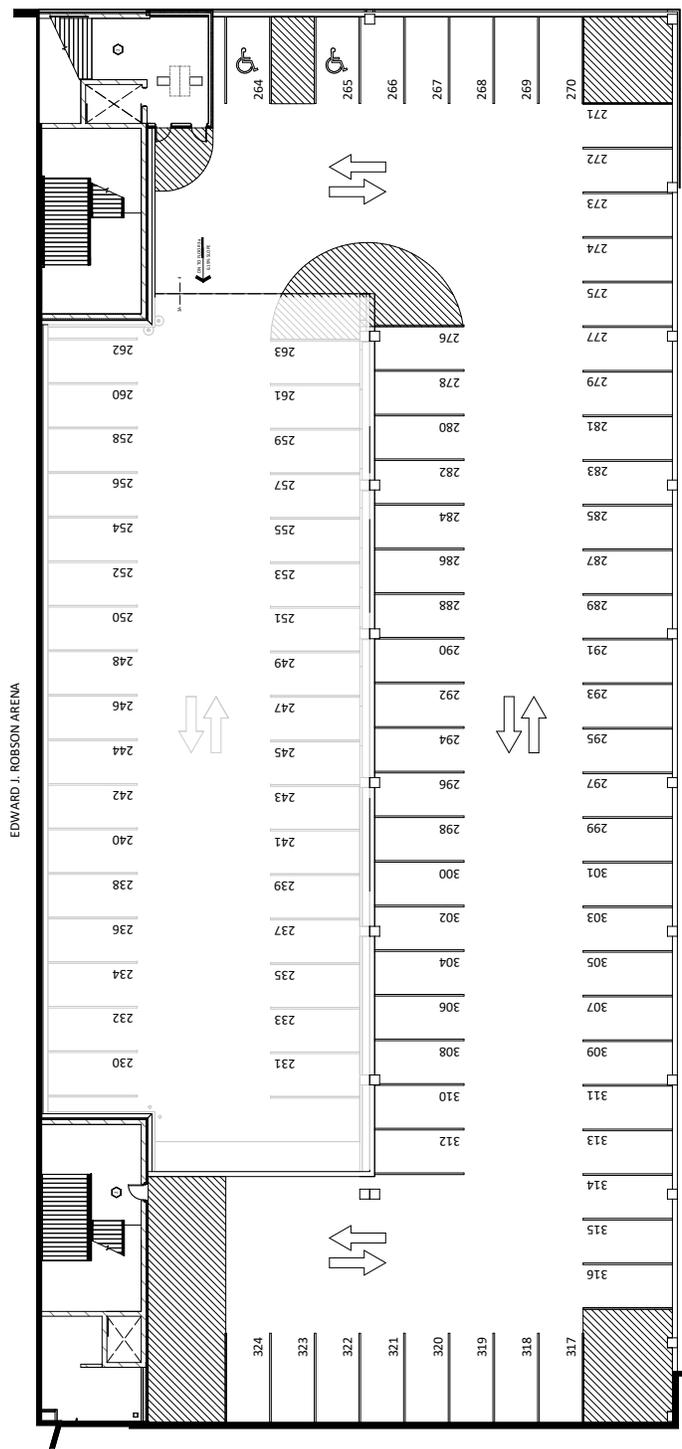

FIGURE 1

File: Colorado College\Robson Arena\425\425_1_Parking_Ramp_Level_4.dwg (12/27/2019 5:08:00 PM)

