ALICE BEMIS TAYLOR CENTER FOR EARLY CHILDHOOD EDUCATION

415 SAHWATCH STREET, COLORADO SPRINGS, COLORADO 80903 MINOR IMPROVEMENT PLAN

GENERAL NOTES

1. A minimum of 3-foot clearance around the circumfrence of all hydrants will be kept clear of any physical or visual onbstructions of the hydrant.

2. FEMA, referencing Flood Insurance Map, Map Number 08041C0729G effective on 12.07.2018, indicates this parcel of land is in Zone X (Area of minimal flood hazard).

3. Phasing: The existing day nursery structure will need to remain intact and occupied for the duration of construction. After the completion of the new building the existing day nursery will be demolished, and the new parking lot will be

4. The site is currently zoned as FBZ-CEN

5. Signage is not approved per this plan. A separate sign permit is required.

6. There is a need for a playground fencing warrant.

7. Owner is responsible for maintaining the public and private improvements within the public right-of-way immediately adjacent to the site.

8. Accessible routes, including ramps and sidewalks, within the public right-of-way shall be per the City's standard drawings and specifications. City's Engineering Development Review Inspector will have the final authority on accepting

9. Installation of eletrical devices in the public ROW shall be performed in accordance with the City Specification Section 1001 and complete the Colorado Springs Utilities "Electric Inspection in the Right-of-Way Certificate" in accordance with Utilities requirements for electrification. The certificate shall also be provided to the City Inspector.

10. All private to public storm sewer connections must be inspected by an Engineering Development Review Inspector.

11. All existing curb, gutter, sidewalks, and pedestrian ramps posing a safety hazard, damaged, exhibiting excessive deteroration or not meeting current city engineering standards will need to be removed and replaced prior to issuing the certificate of occupancy. An on-site meeting can be set up with the Engineering Development Review Inpsector to determine what, if any, improvements are required. The inspector can be reached at 719-385-5977.

12. Prior to installing the public ROW improvements, submit street and signage construction plans to EDRD and Traffic Engineering through our electronic review system called ProjectDox for review and approval. Financial assurances for all public ROW improvements shall be posted to the City prior to approving the construction plans. The amount to be submitted to the City will be agreed upon at that time. The public ROW improvements will follow EDRD's probationary and final street acceptance procedures. Reference chapter 11 in the subdivision policy manual for information.

13.All street trees and streetscape improvements located in the ROW will be maintained by the abutting property owner.

ADA NOTE

The parties responsible for this plan have familiarized themselves with all current accessibility criteria and specifications and the proposed plan reflects all site elements required by the applicable ADA design standards and guidelines as published by the United States Department of Justice. Approval of this plan by the city of Colorado Springs Does not assure compliance with the ADA or any other federal or state accessibility laws or any regulations or guidelines enacted or promulgated under or with respect to such laws. Sole responsibility for compliance with federal and state accessibility laws lies with the property owner.

SITE DATA

415 Sahwatch Street Property Address: Colorado Springs, CO 80903

Child Nursery Centers Inc, Owner/Developer: 104 E. Rio Grande Street Colorado Springs, CO 80903 719-632-1754

Applicant/Planner

RTA Architects 19 S. Tejon St. Suite #300 Colorado Springs, CO 80903 719-471-7566

Civil Engineer JPS Engineering 19 E. Willamette Ave. Colorado Springs, CO 80903

Landscape Architect

Colorado Springs, CO 80903 RTA Architects 19 S. Tejon St. Suite #300 Colorado Springs, CO 80903

0.66 (AC) 28,620 (SF)

0.33 (AC) 14,310 (SF)

31' - 0" / 2 Stories with Basement 31' - 0" / 2 Stories with Basement

FBZ-CEN Zoned

Music School

Child Care

17,000 (SF)

16,496 (SF)

2 parking spaces

27 standard stalls

2 parking spaces

Common Lawn

Civic Building

55' - 0"

619 NORTH CASCADE AVE. SUITE #200

N.E.S. INC.

Development Schedule: Site Area: Disturbed Area: Current Use: Proposed Use: Existing Building Size Proposed Building Size: Existing Building Height: Proposed Building Height: Maximum Building Height:

Parking Required: Day Nursery - ADA Accesible Parking Provided: Day Nursery - ADA Accesible

LEGAL DESCRIPTIONS

LOT 1 BLK 1 RECTORS SUB


FBZ Frontage Type: FBZ Building Type:

FENCE PRODUCT INFORMATION

MANUF: FORTRESS BUILDING PRODUCTS STYLE: A2 COMMERCIAL MATERIAL: POWDERCOATED ALUMINUM COLOR: BLACK HEIGHT: 5'-0" @ PERIMETER 3'-0" BETWEEN PLAYGROUNDS

PANELS & GATE STYLES



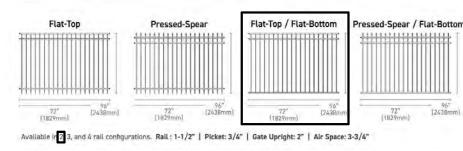



VICINITY MAP



EXISTING CONDITIONS PHOTOS











EXISTING TREES AND METERED PARKING CONDITION ALONG SAHWATCH EXISTING TREES AND METERED PARKING CONDITION ALONG SAHWATCH

PROPOSED RENDERINGS







COVER SHEET

19 SOUTH TEJON ST., SUITE 300

COLORADO SPRINGS, CO. 80903

TELE. 719-471-7566

FAX: 719-471-1174

www.rtaarchitects.com

2024-064.00

01/10/25

MINOR IMPROVEMENT PLAN 1 OF 13

0' 20' 40'



ICE BEMIS TAYLOR CENTER

© CORVEIGHT DTA

SHEET TITLE

SITE PLAN

RTA PROJECT NUMBER **2024-064.00**

DATE 03/11/25

REVISIONS


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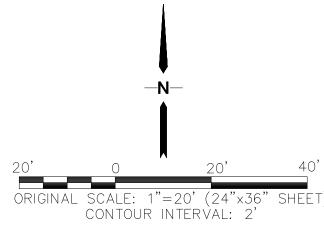
QA/QC APPROVAL:
DRAWN BY:
CHECKED BY:
CC


ISSUED FOR:
MINOR IMPROVEMENT PLAN
SHEET NO.

2 OF 13

FBZN-25-0001



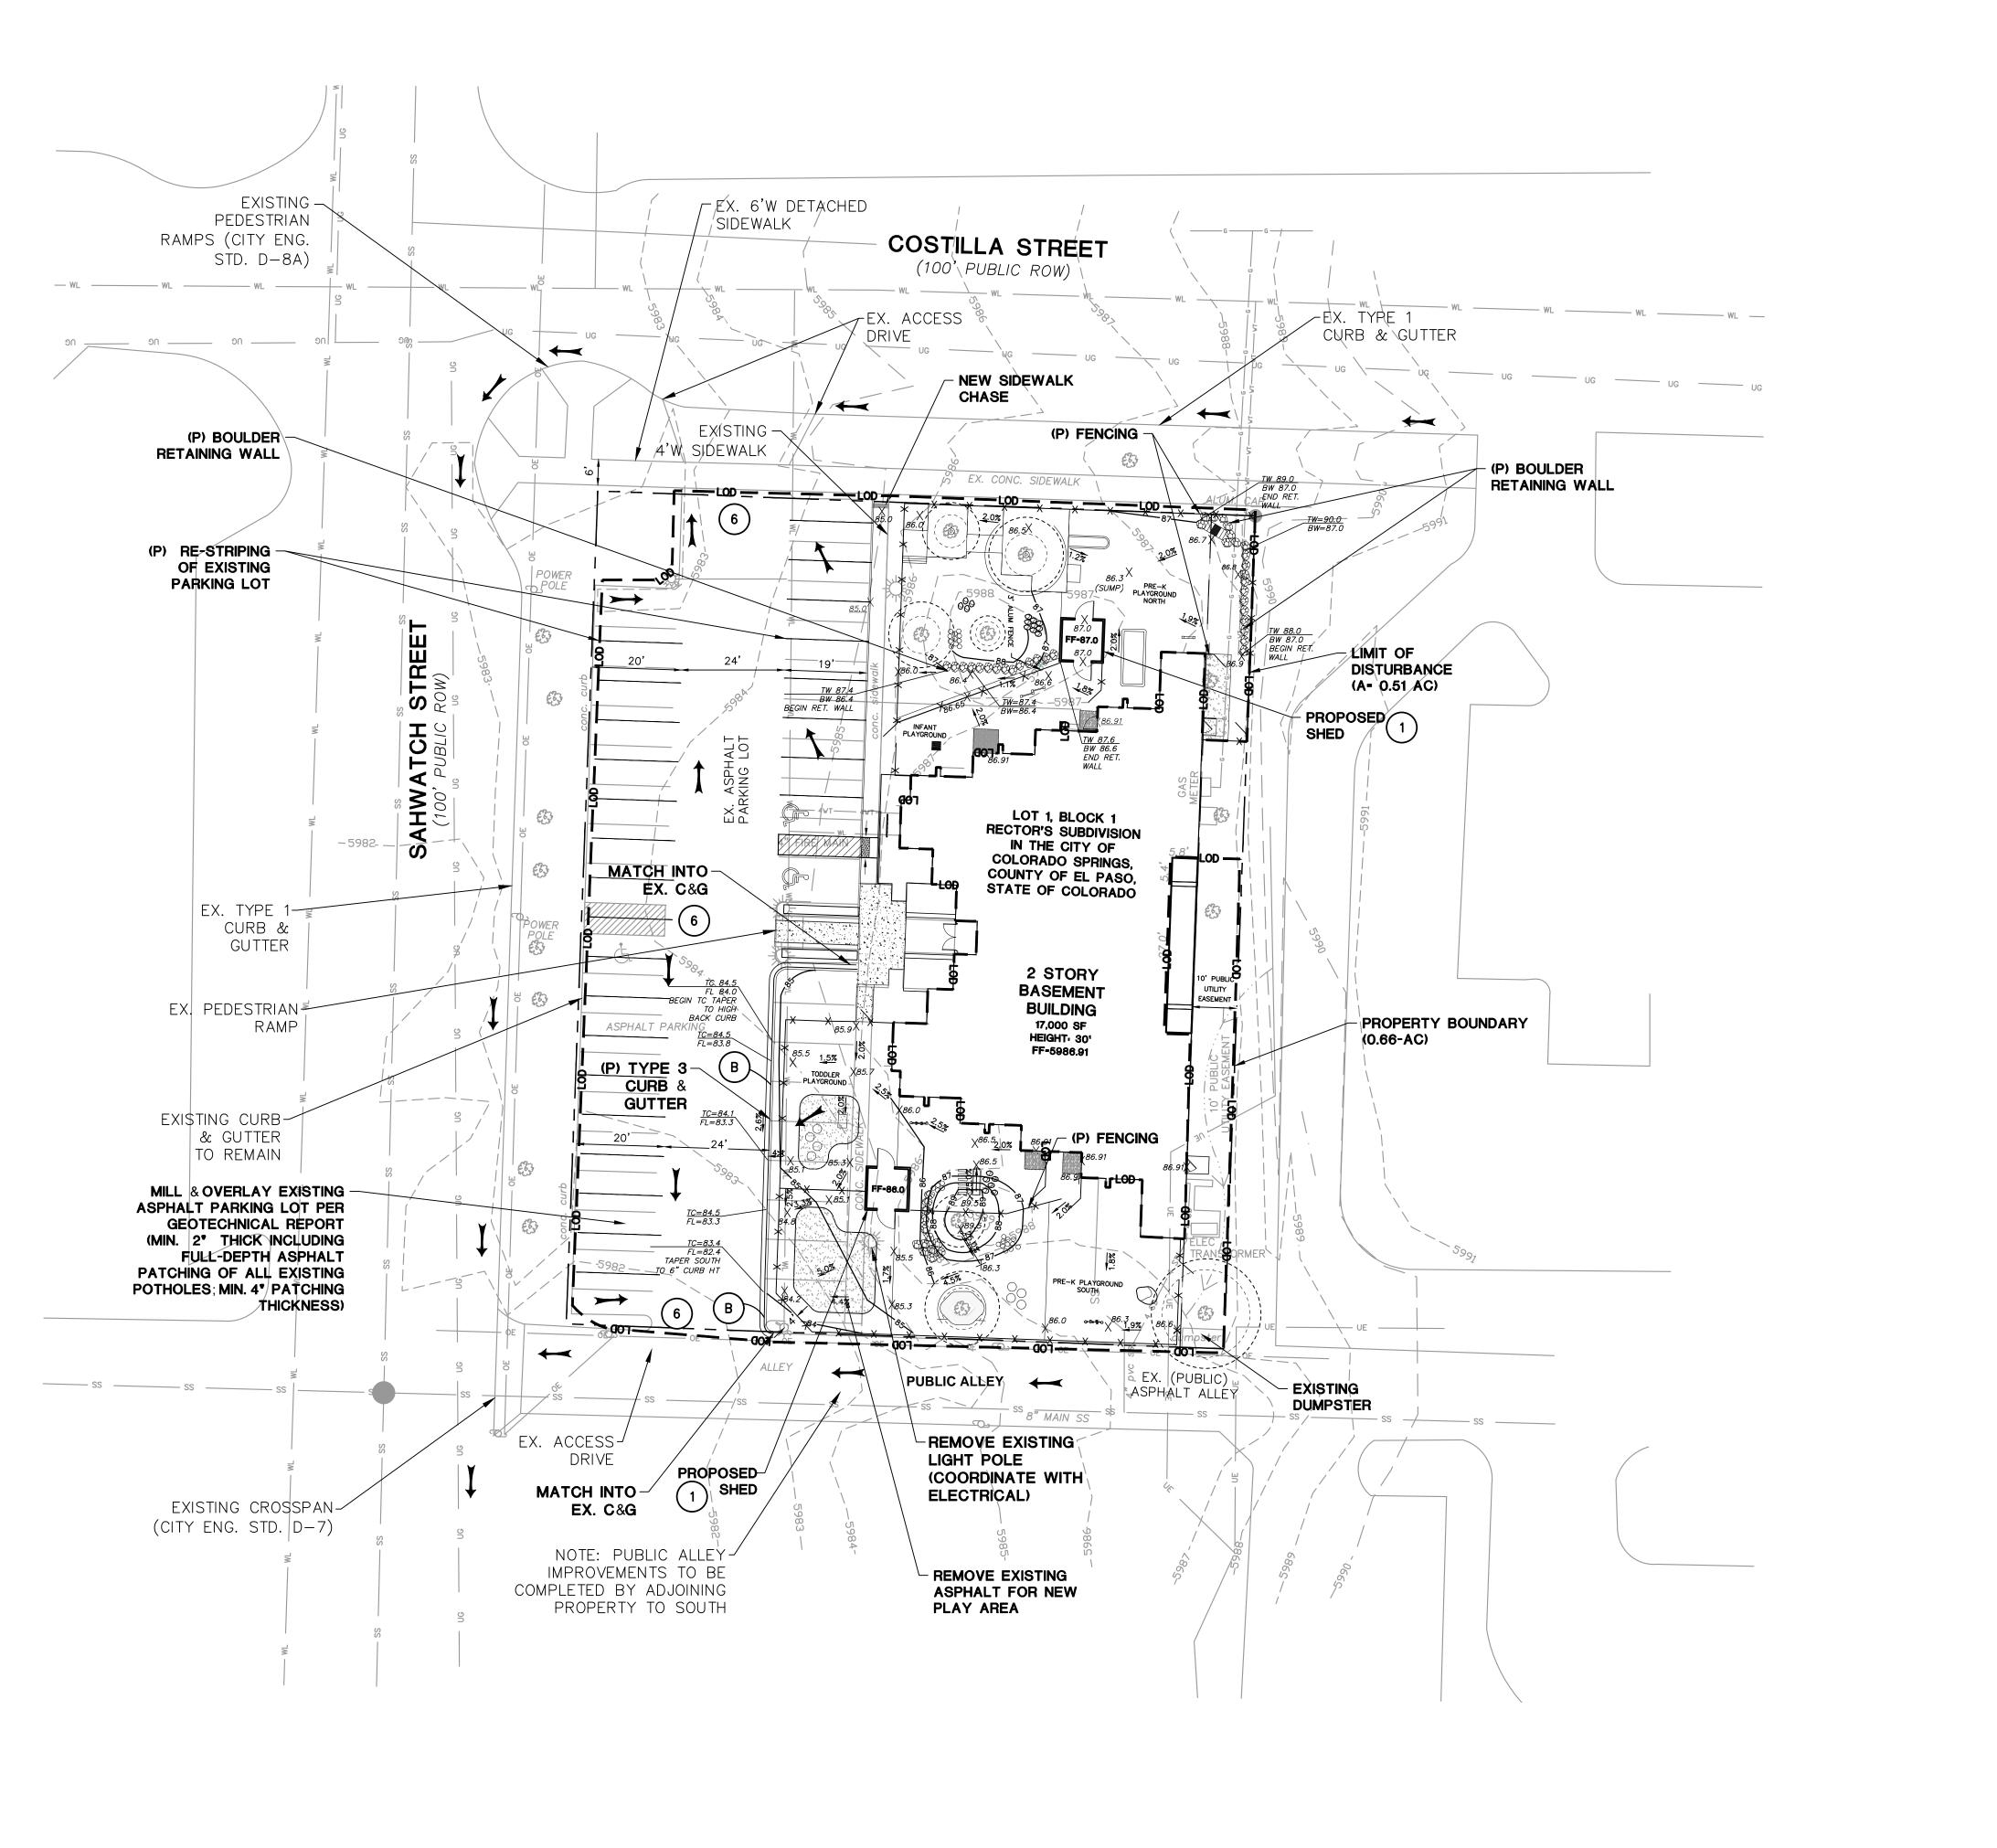

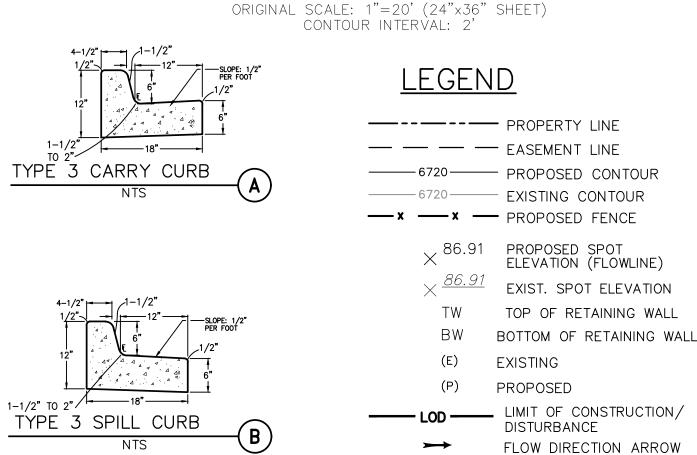


CONTROL MEASURE LEGEND:

- (VTC) VEHICLE TRACKING PAD

- (2) TOPSOIL & STRIPPINGS STOCKPILE AREA
- STORAGE AREA FOR BUILDING MATERIALS, EQUIPMENT & CONSTRUCTION WASTE (CONTRACTOR MAY ADJUST AS NEEDED)
- (5) MIN 4'x4' CONCRETE LANDING AT DOOR W/1.5% SLOPE AWAY FROM BUILDING (STRUCTURAL STOOP WITH THICK ENDED EDGE PER IBC)

ARCHITECTS 19 SOUTH TEJON ST., SUITE 300 COLORADO SPRINGS, CO. 80903 TELE. 719-471-7566 FAX: 719-471-1174 www.rtaarchitects.com

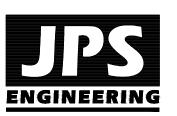

19 E. Willamette Ave. Colorado Springs, CO

PH: 719-477-9429 FAX: 719-471-0766

www.jpsengr.com

(P) NEW LANDSCAPED AREAS

(SF) SILT FENCE -----

(IP) INLET PROTECTION

(SM) SEED & MULCH

CWA) CONCRETE WASHOUT AREA

SSA STABILIZED STAGING AREA

(SP) STOCKPILE PROTECTION

KEYED NOTES:

1 PREPARE AND COMPACT BUILDING FOUNDATION & SLABS PER PROJECT GEOTECHNICAL REPORT

3 PARKING LOT PAVING PER GEOTECHNICAL REPORT (4" FULL-DEPTH ASPHALT OVER COMPACTED SUBGRADE UNLESS NOTED OTHERWISE)

6 EXISTING ASPHALT MILL & OVERLAY AREA (2" MIN. DEPTH); MATCH INTO ADJOINING ASPHALT & CURB & GUTTER

GRADING & EROSION CONTROL PLAN

2024-064.00 03/12/2025

RTA PROJECT NUMBER

DATE DESCRIPTION


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FBZN-25-0001


BENCHMARK: EXISTING BUILDING FF EL= 5986.91

PRELIMINARY

CITY APPROVAL

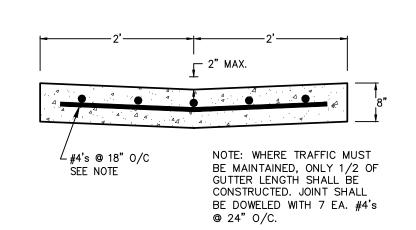


TYPICAL CONCRETE CROSSPAN (1) SCALE: 1'' = 1'-0''

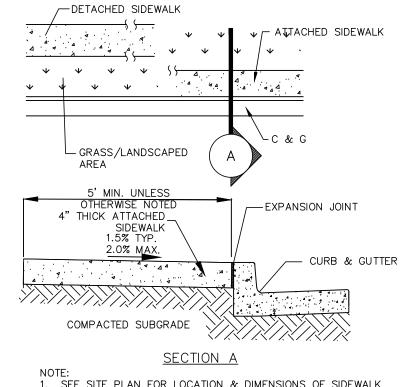


1. SEE SITE PLAN FOR LOCATION & DIMENSIONS OF SIDEWALK (5' ATTACHED SIDEWALK UNLESS NOTED OTHERWISE). 2. CONTRACTOR SHALL PROVIDE JOINTS PER CITY OF COLORADO SPRINGS STANDARD SPECIFICATIONS.

CONCRETE SIDEWALK DETAIL (2)

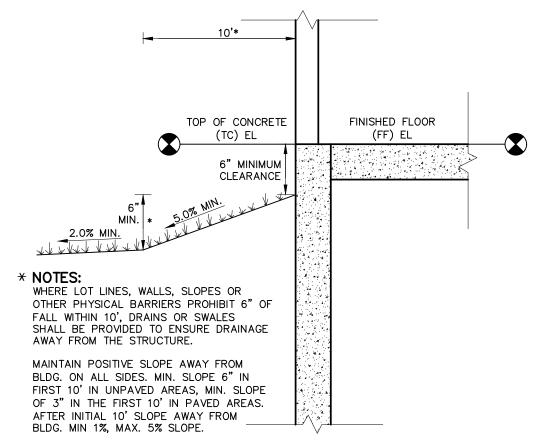

TYPICAL BUILDING DRAINAGE DETAIL (3)

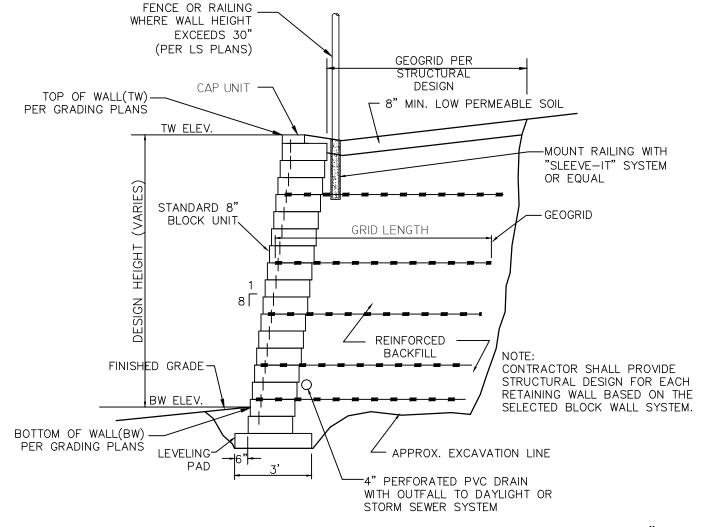


NOTE: RETAINING WALL SYSTEM SHALL BE ALLAN BLOCK "AB VERTICAL" WITH 3-DEGREE SETBACK OR APPROVED EQUAL

SIDEWALK CURB RAMPS


GENERAL NOTES AND DETAILS

COLORADO


SEGMENTAL BLOCK RETAINING WALL DETAIL 4 SCALE: NTS

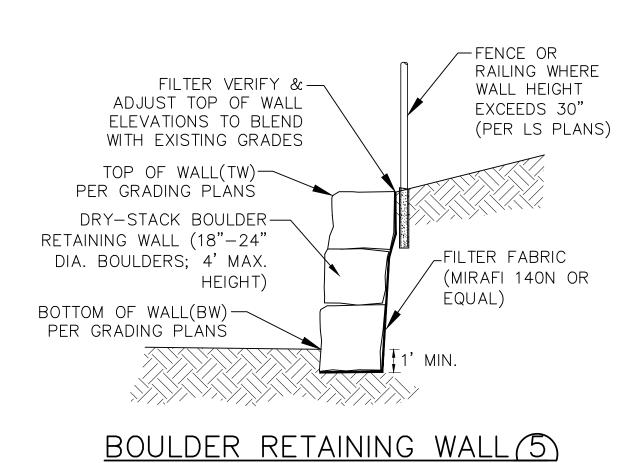


SCALE: NTS

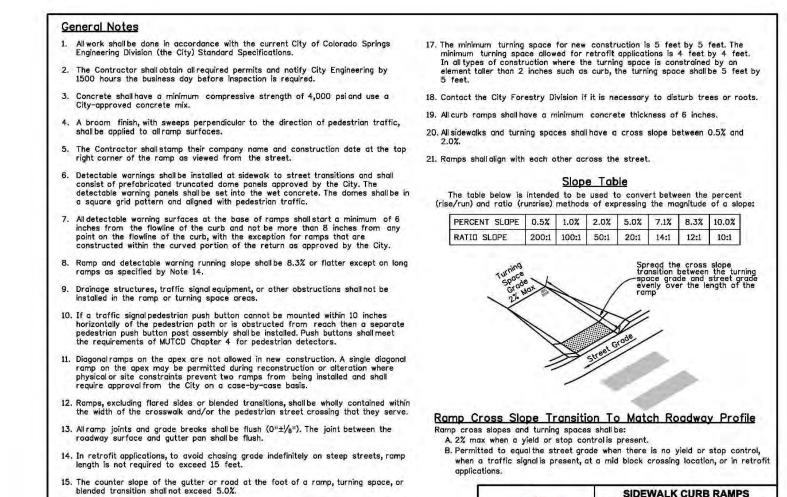


16. Flared side slopes may exceed 10% only where they abut a non-walkable surface (landscaping or domed surface) or the adjacent circulation path is blocked such that it is unlikely for a pedestrian to walk across the flared side slope.

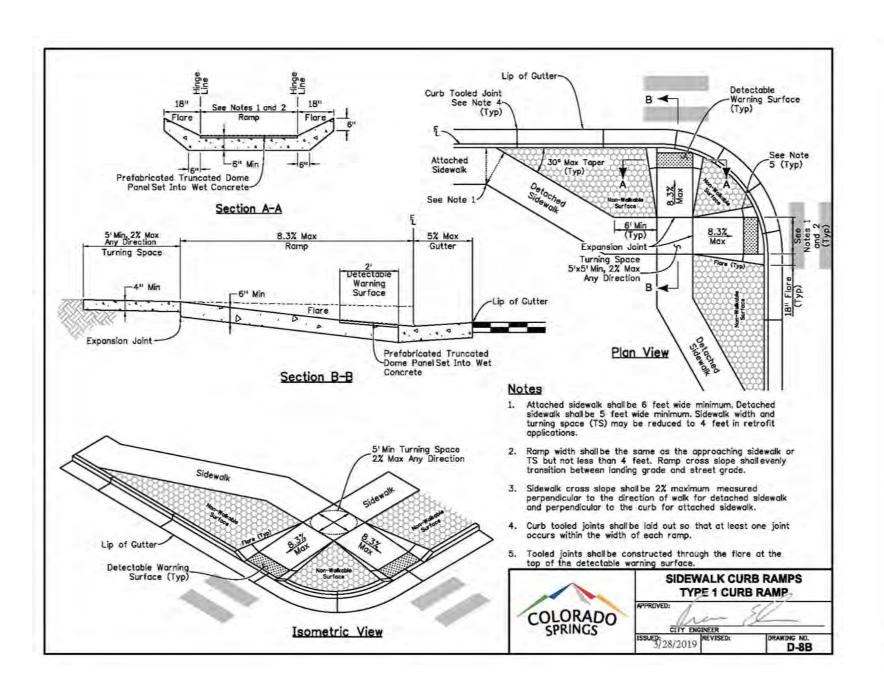

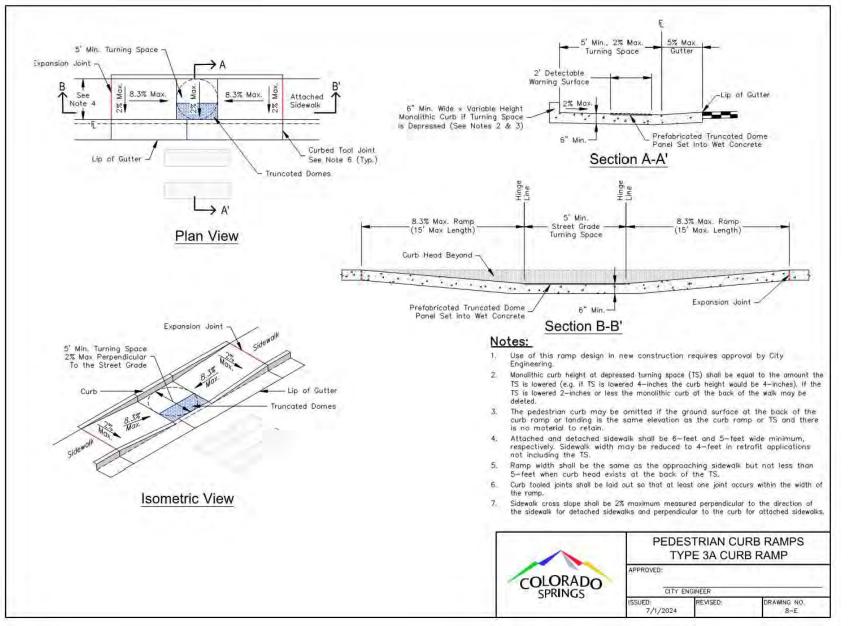

ARCHITECTS

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R

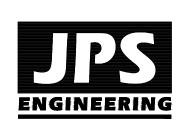CIVIL DETAILS

RTA PROJECT NUMBER 2024-064.00

CITY APPROVAL


03/12/2025


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4 OF 13 C1.2

FBZN-25-0001



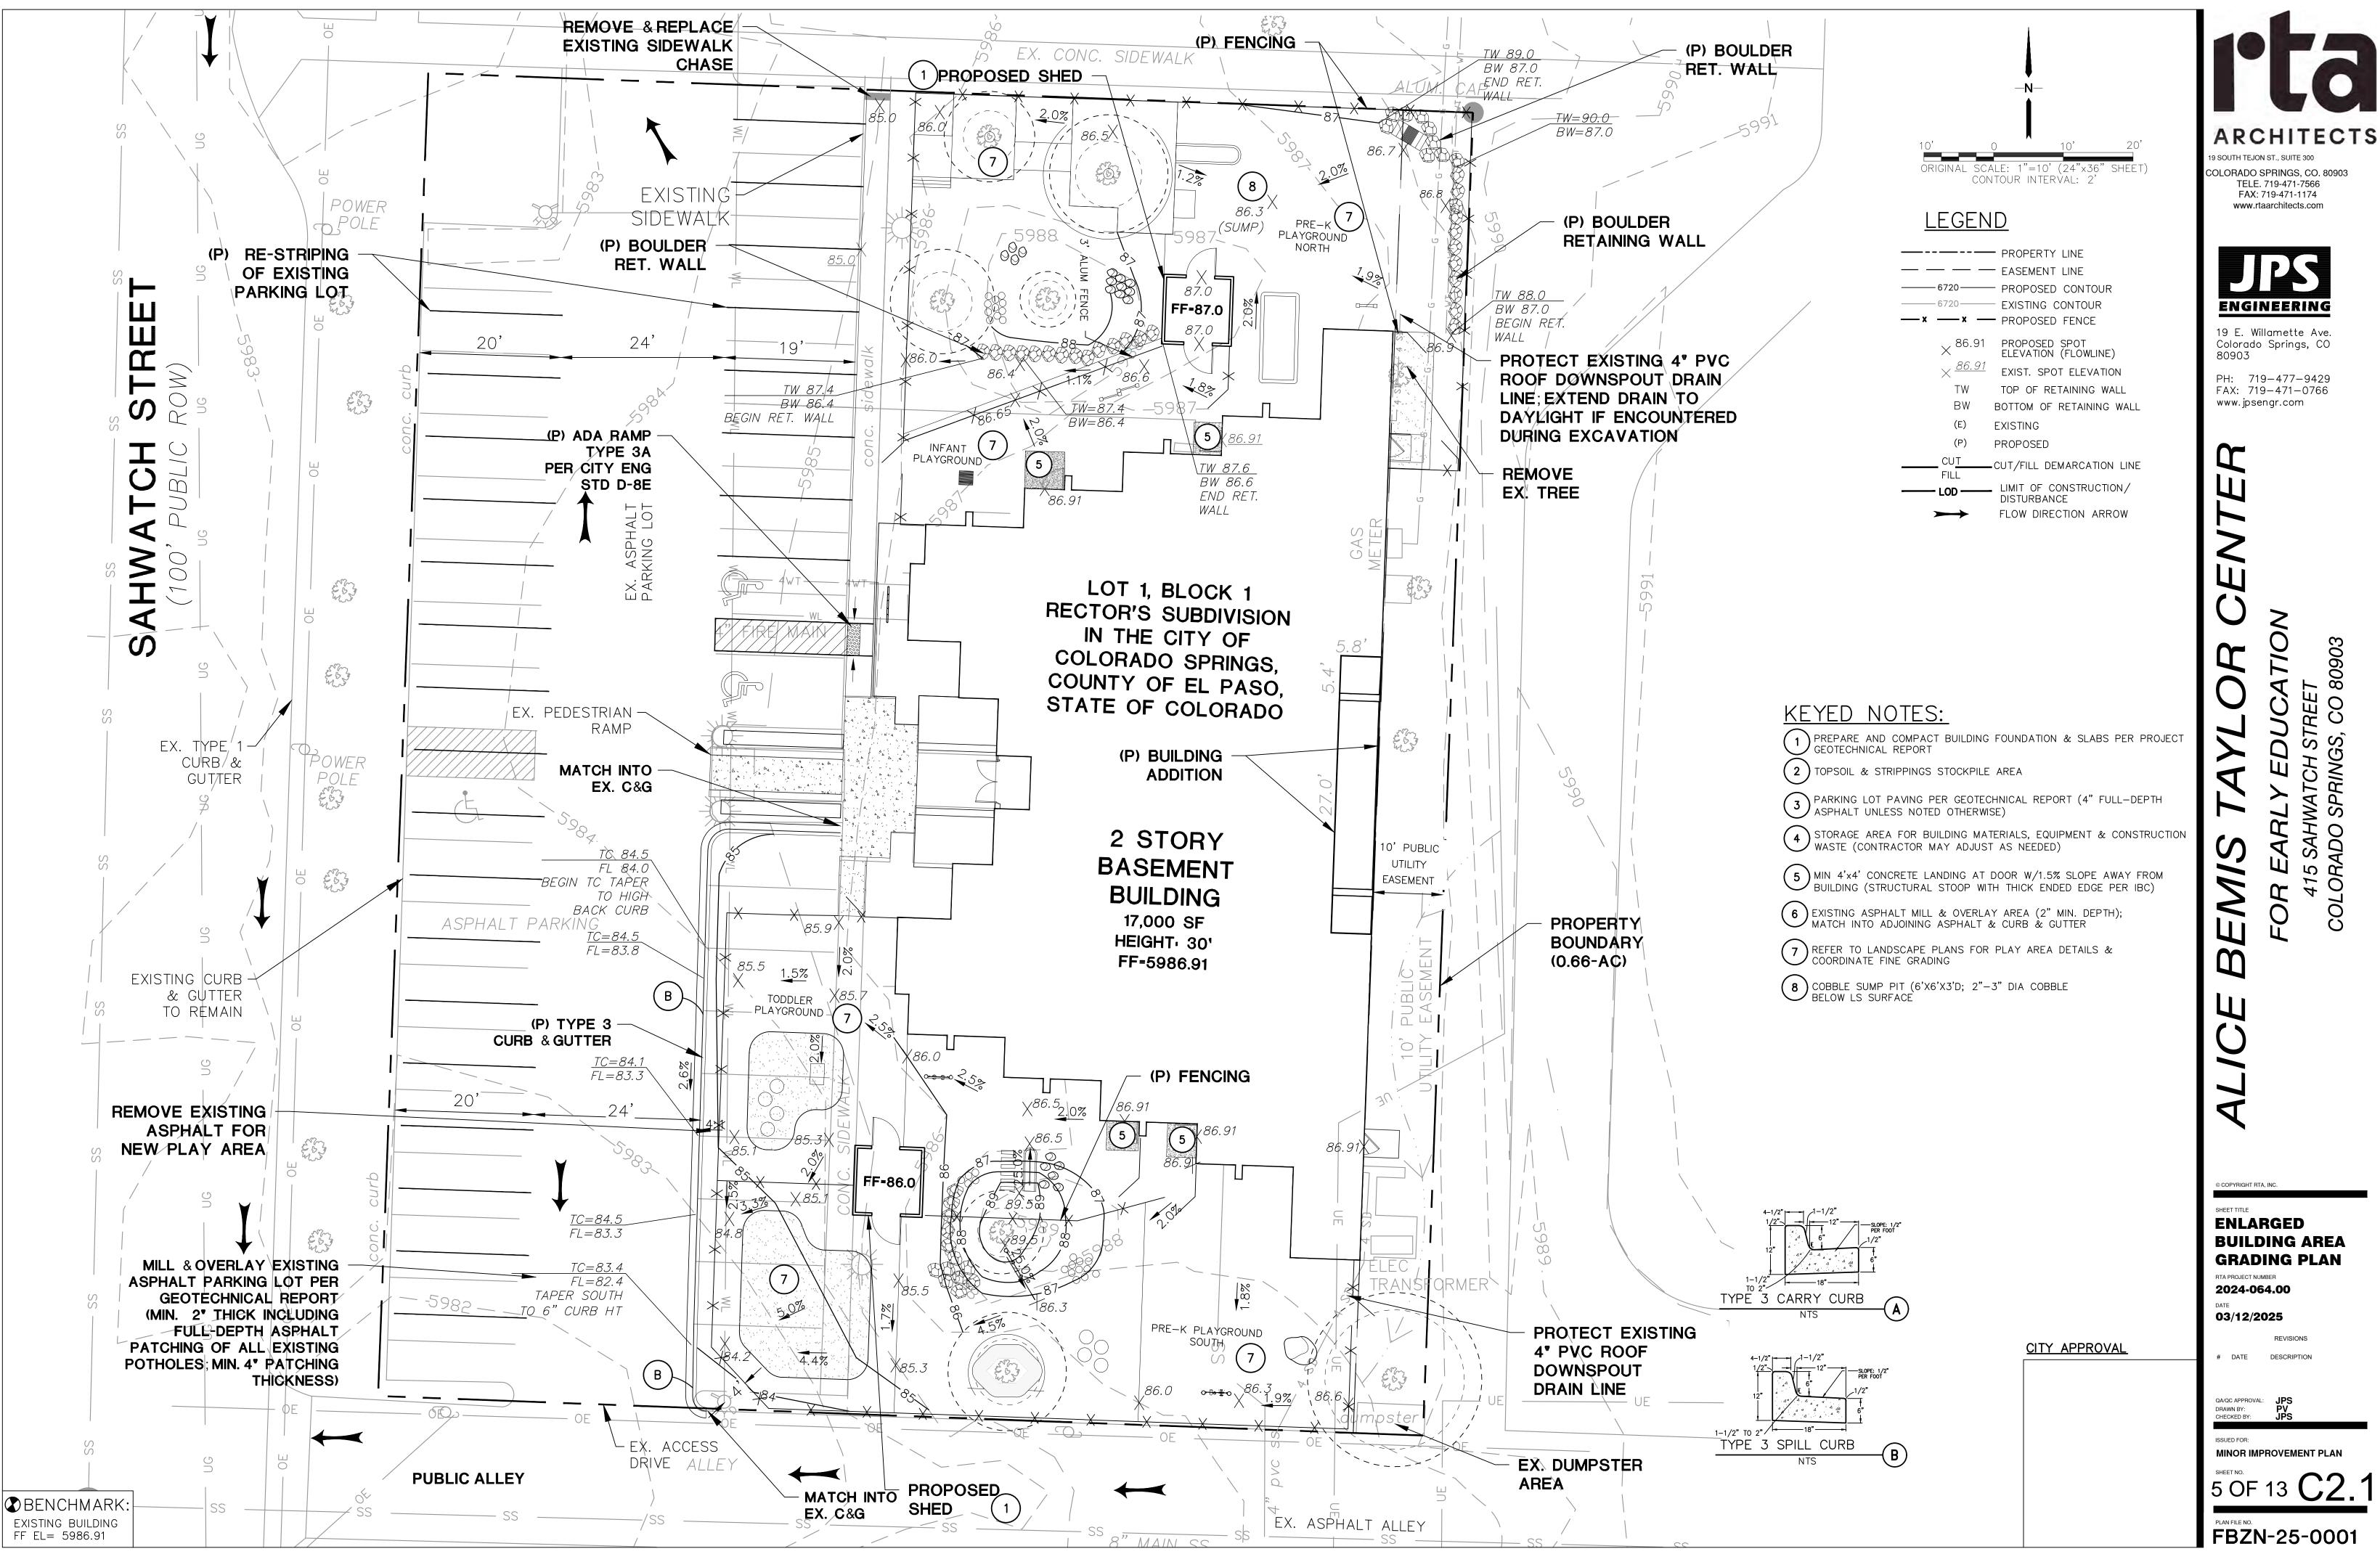

ARCHITECTS

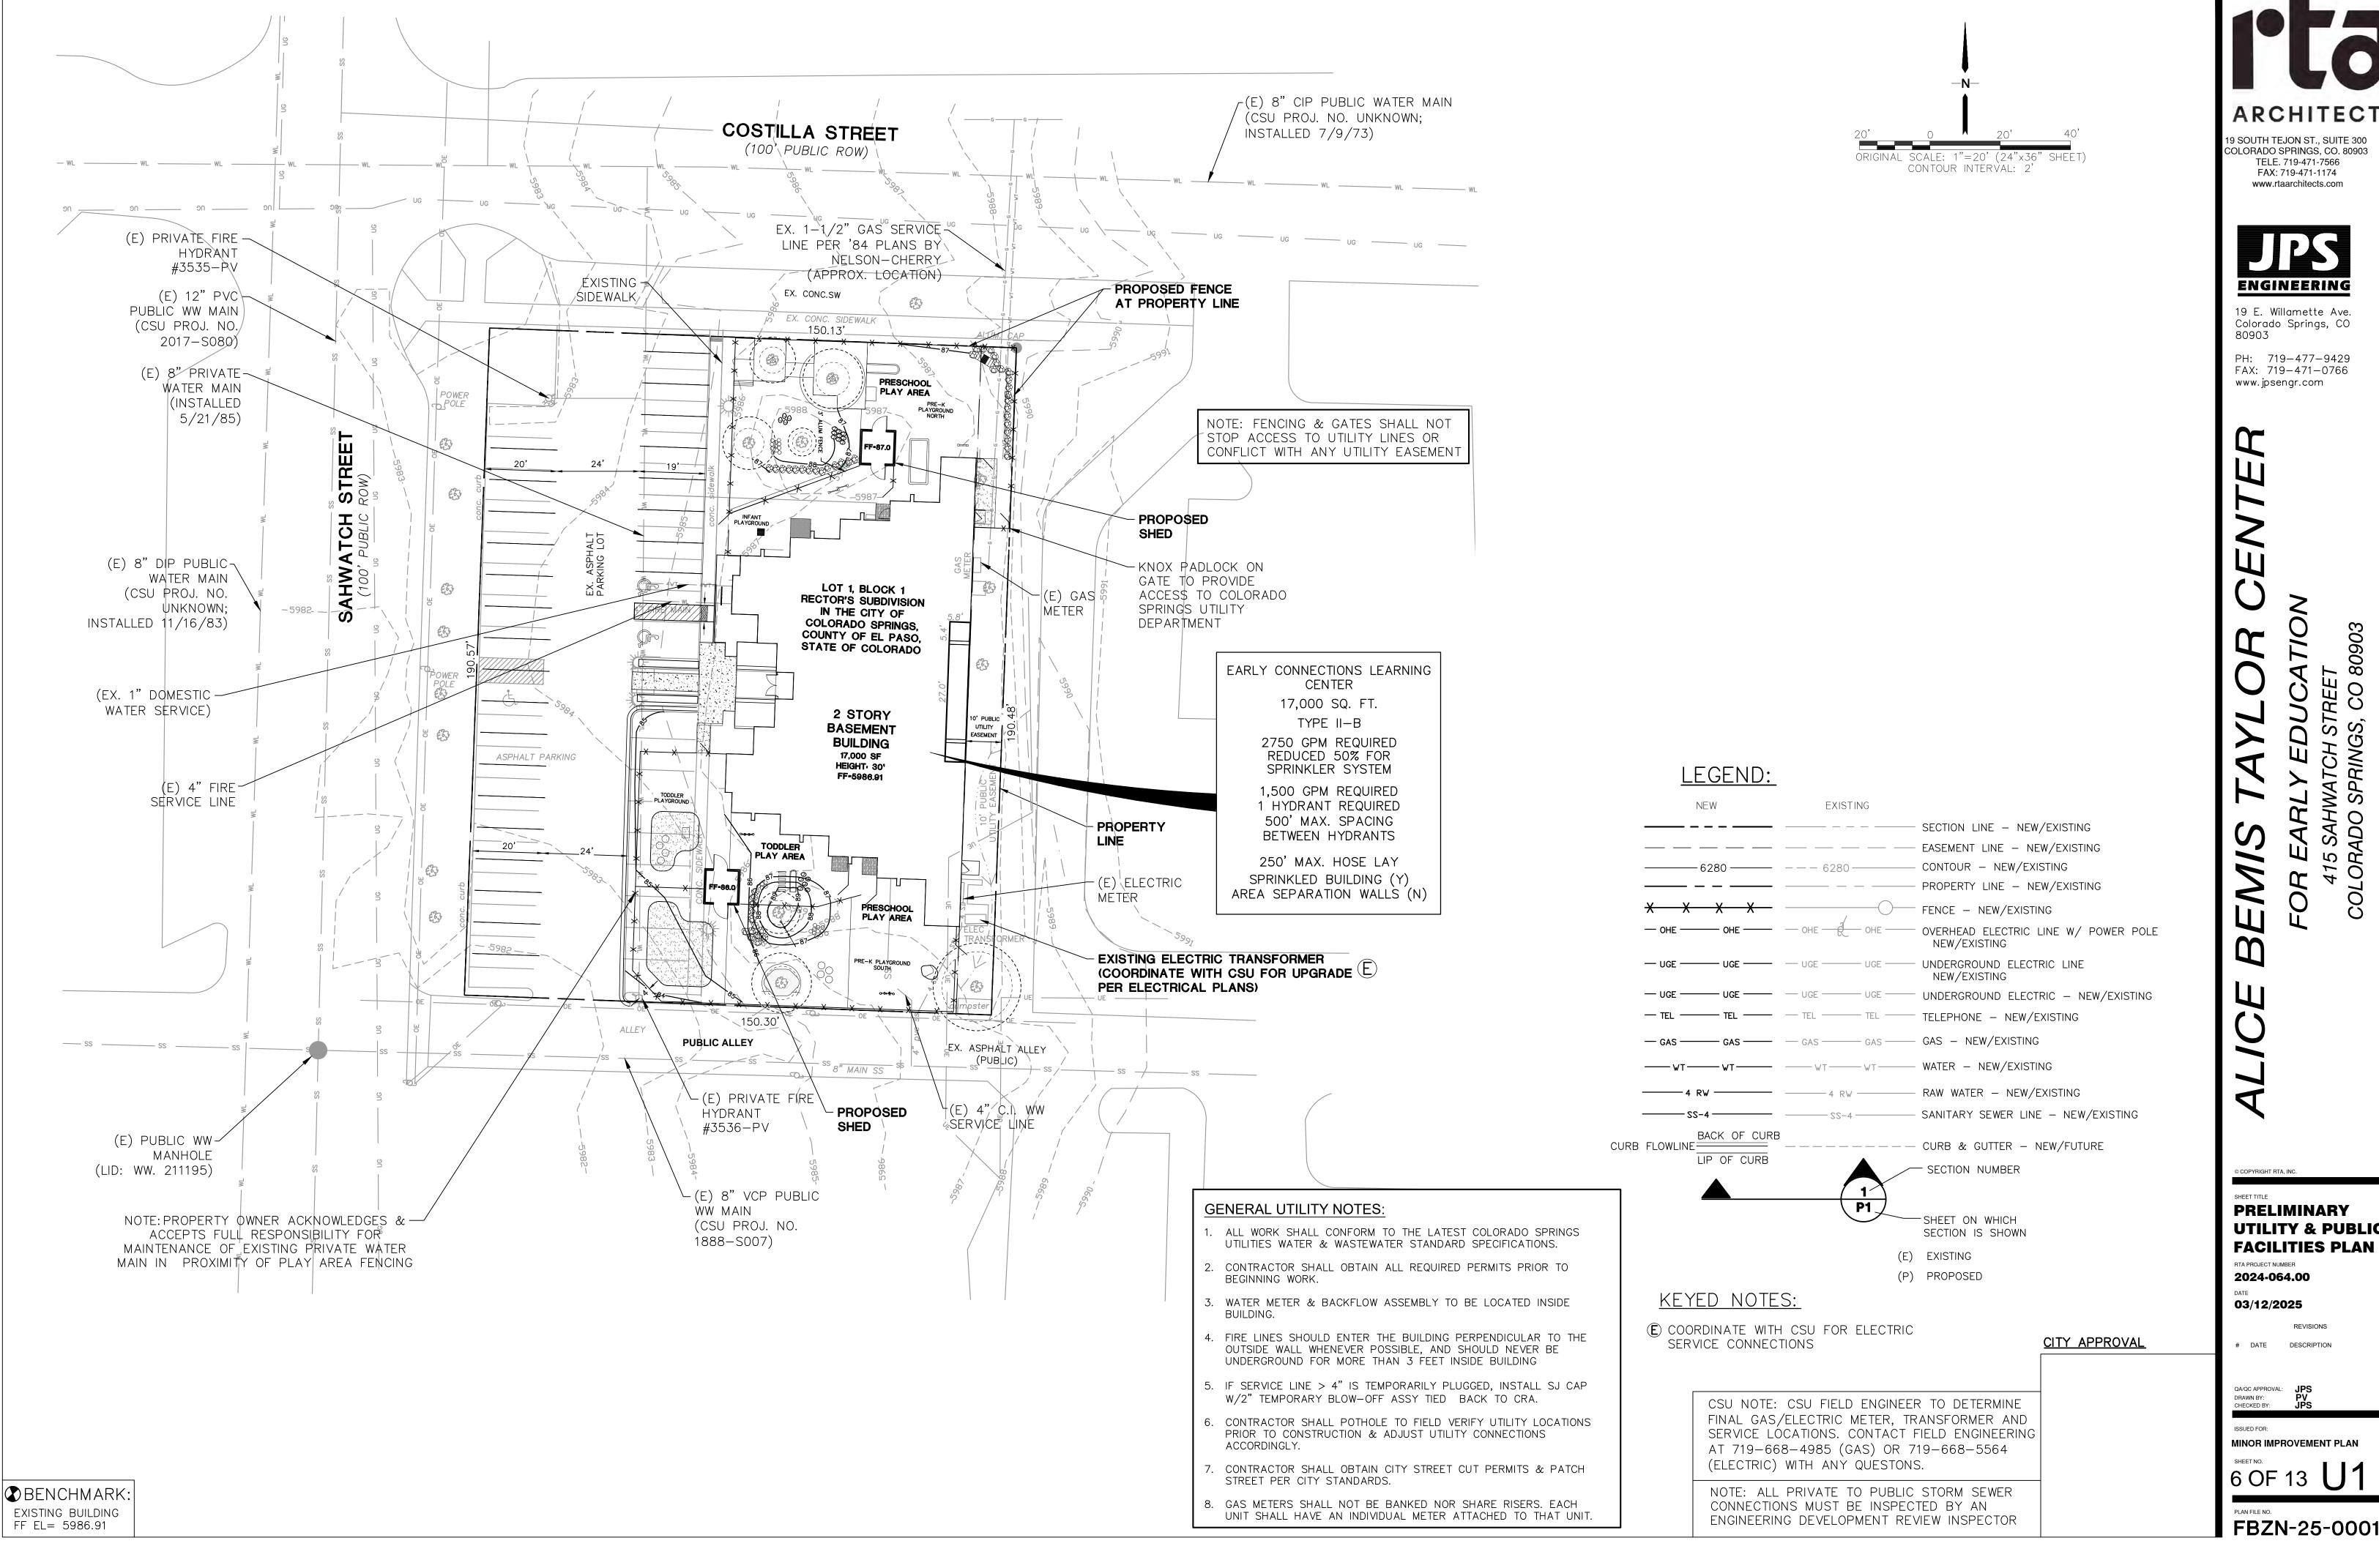UTILITY & PUBLIC



ALICE BEMIS TAYLOR CENTER

SHEET TITLE

EXTERIOR

EXTERIOR ELEVATIONS

RTA PROJECT NUMBER

2024-064.00

DATE

01/10/25


REVISIONS

DRAWN BY: CC
CHECKED BY: CC
ISSUED FOR:
MINOR IMPROVEMENT PLAN

T OF 13

QA/QC APPROVAL:

FBZN-25-0001

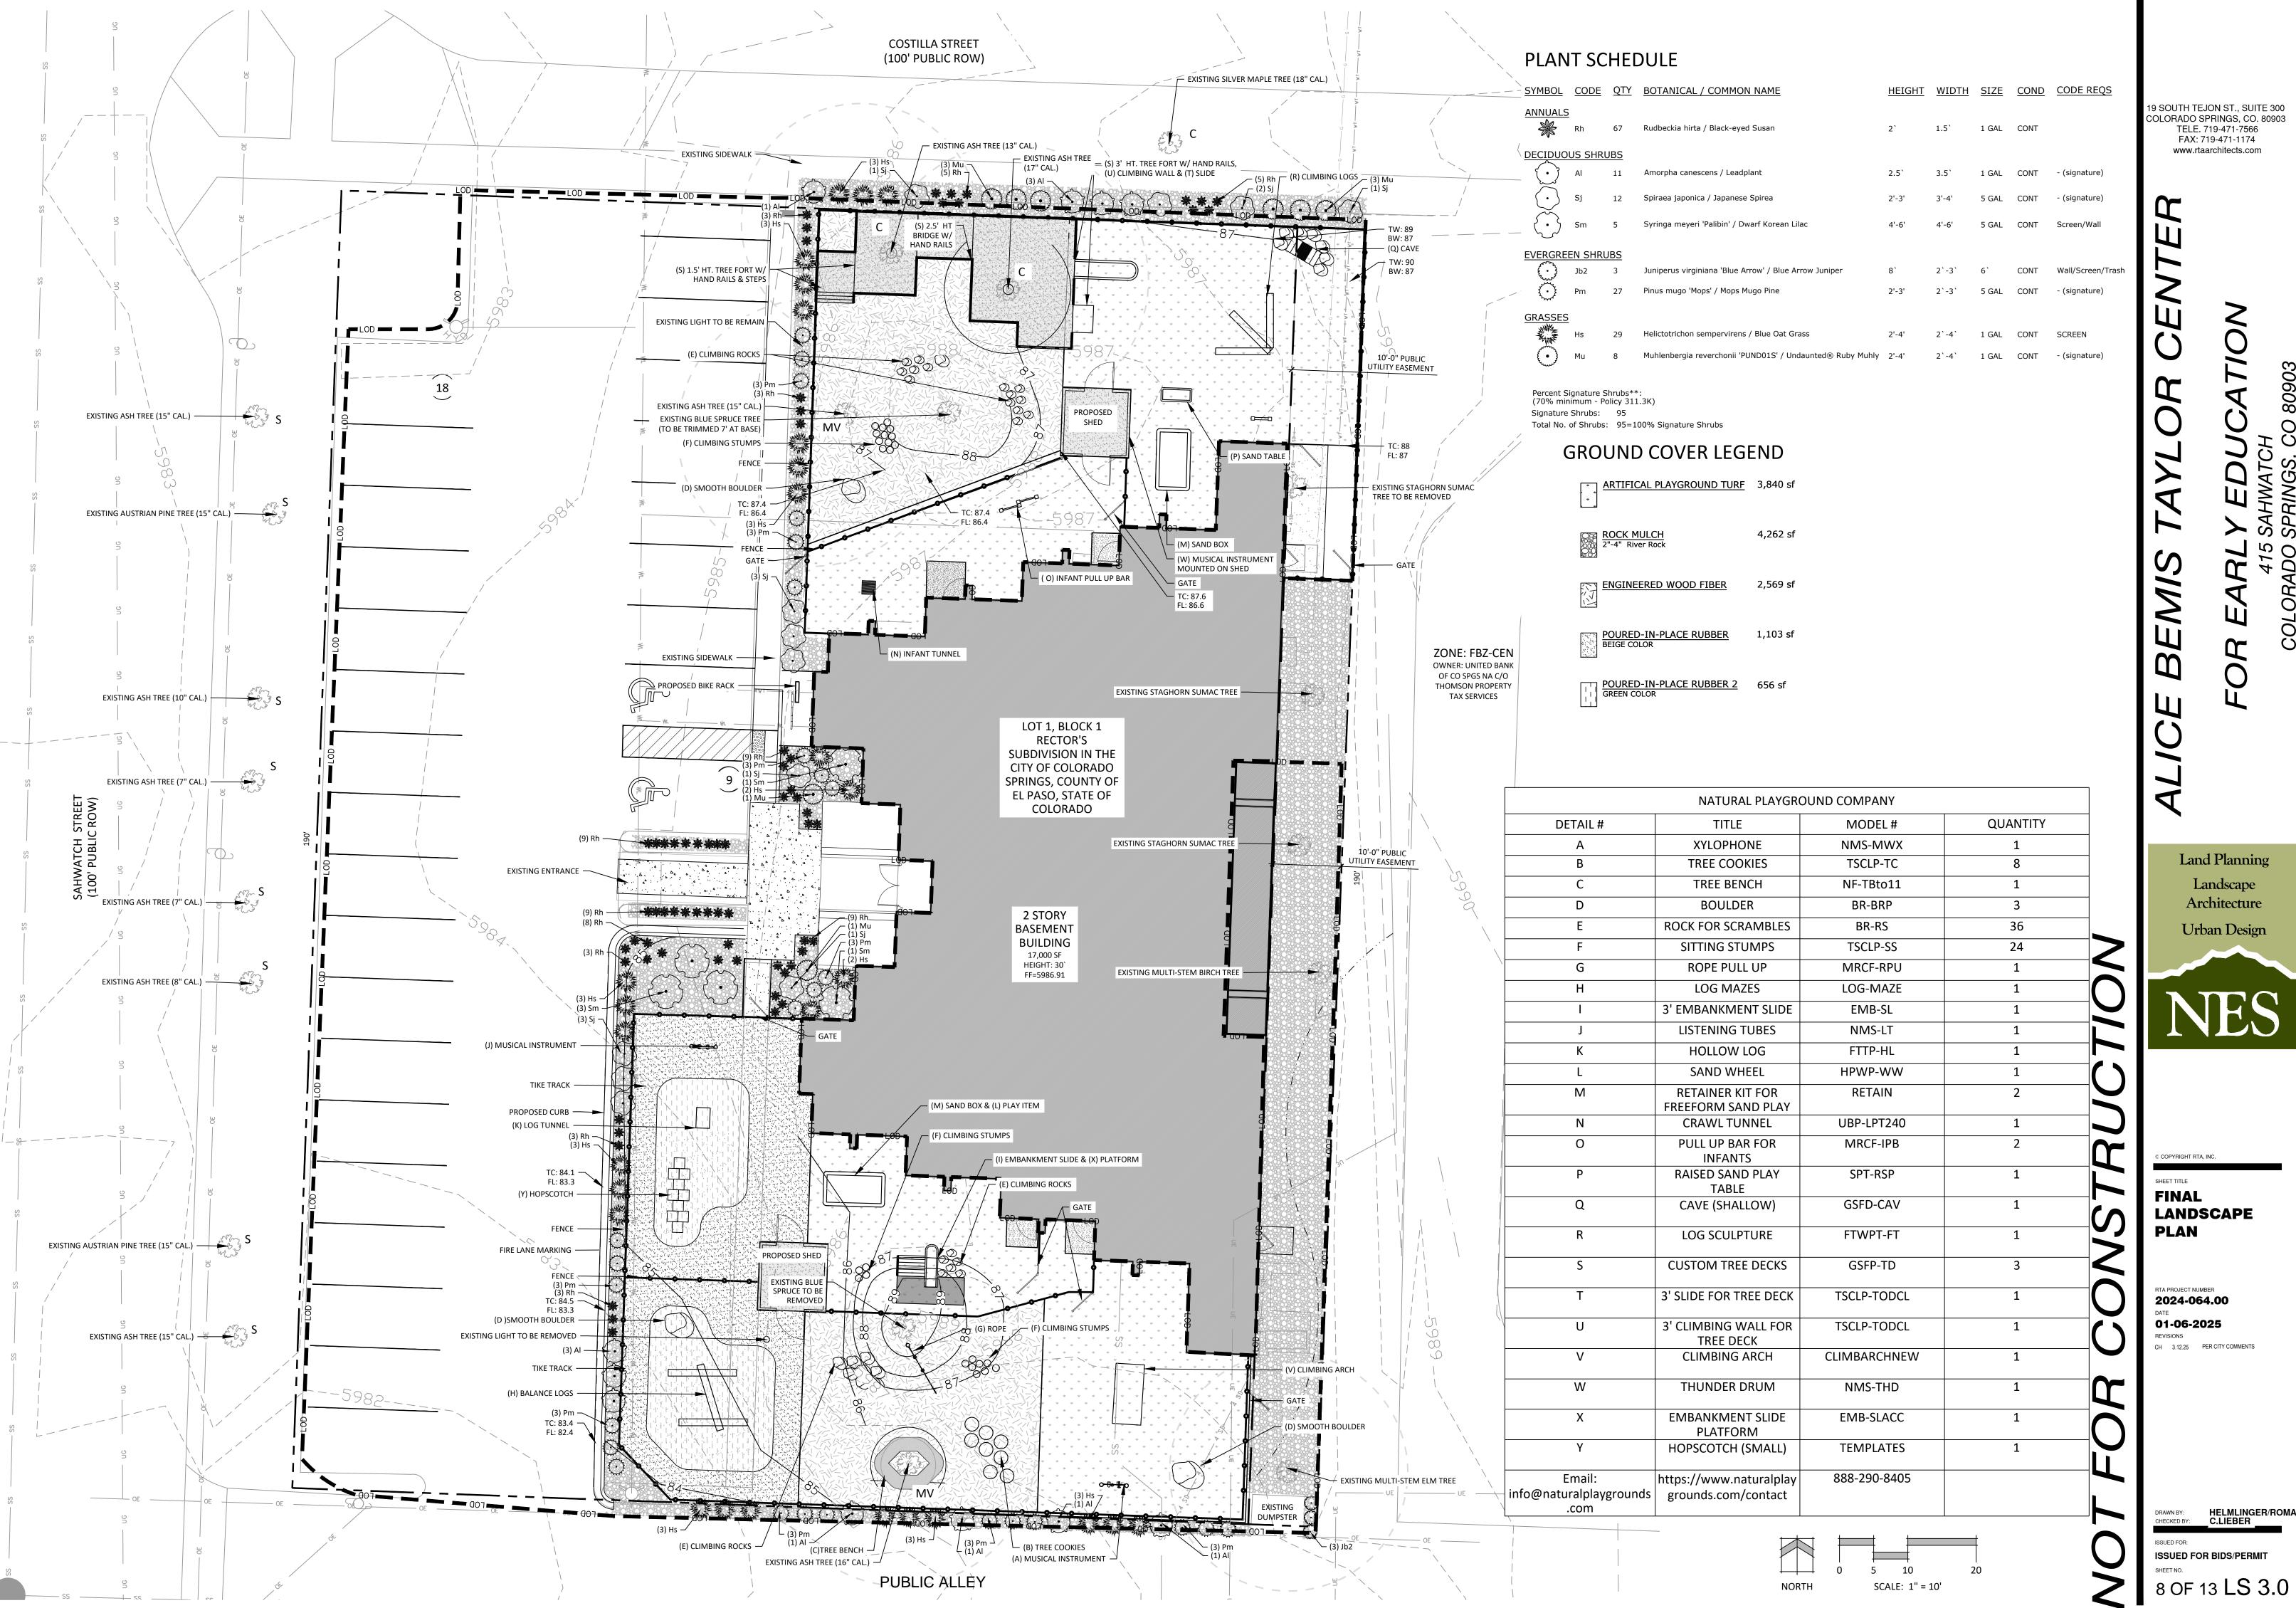

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Land Planning Landscape Architecture Urban Design

FINAL LANDSCAPE **PLAN**

2024-064.00

01-06-2025 CH 3.12.25 PER CITY COMMENTS

DRAWN BY: HELMLINGER/ROMAN C.LIEBER ISSUED FOR BIDS/PERMIT

LANDSCAPE NOTES

MANGANESE

1. SOIL AMENDMENT - INCORPORATE 3 CUBIC YARDS/1000 SF AREA OF "PREMIUM 3 ORGANIC COMPOST", OR APPROVED EQUAL, ON BLUEGRASS TURF AREAS. INCORPORATE 2 CUBIC YARDS/1000 SF AREA OF ORGANIC COMPOST (DECOMPOSED MANURE) TO ALL NATIVE SEED AREAS. TILL INTO TOP 8" OF SOIL. FOR PLANTING PIT AMENDMENTS, SEE LANDSCAPE DETAILS.

RECOMMENDED SOIL AMENDMENT FOR PLANTING PITS:

SHRUB-BROADLEAF SHRUB-CONIFER NITROGEN .01 LBS/1000SF .02 LBS/1000SF PHOSPHORUS (P205) .01 LBS/1000SF .01 LBS/1000SF POTASSIUM (K20) 0 LBS/1000SF 0 LBS/1000SF SULFUR (SO4-S)

0 LBS/1000SF 0 LBS/1000SF 0 LBS/1000SF 0 LBS/1000SF TRI-MIX III AS SUPPLIED BY C&C SAND -TO BE APPLIED AS BACKFILL IN PLANTING PITS

*SODIUM- CAUTION: REFERENCE ANALYSIS RESULTS 2. A SIGNED AFFIDAVIT ATTESTING TO THE SOIL AMENDMENTS INCORPORATED TO CORRECT DEFICIENCIES SHALL BE INCLUDED WITH THE SOIL ANALYSIS PRIOR TO ISSUANCE OF A CERTIFICATE OF OCCUPANCY.

CONTRACTOR TO UTILIZE STOCKPILED TOPSOIL FROM GRADING OPERATION AS AVAIL. TILL INTO TOP 8" OF SOIL.

FOR GRADING PLAN, REFER TO CIVIL ENGINEER'S DRAWINGS. FOR STANDARD LIGHTING AND LOCATIONS. REFER TO PHOTOMETRIC PLAN.

6. ALL PRESERVATION AREAS CONTAINING VEGETATION DESIGNATED TO BE PRESERVED, SHALL BE FENCED OFF DURING CONSTRUCTION TO MINIMIZE DISTURBANCE IN THESE AREAS. ALL FENCING SHALL BE INSTALLED AROUND PRESERVED VEGETATION PRIOR TO ANY GRADING ON THE PROPERTY. A 4-FOOT ORANGE CONSTRUCTION SAFETY FENCE SHOULD BE USED IN THIS APPLICATION. SUBMIT PRODUCT INFO TO L.A. FOR APPROVAL PRIOR TO

7. A FULLY AUTOMATED SPRINKLER IRRIGATION SYSTEM WILL DRIP IRRIGATE ALL TREE, SHRUB, AND GROUND COVER PLANTING AREAS AND SPRAY ANY TURF. IRRIGATION PLAN WILL INCLUDE AN IRRIGATION SCHEDULE THAT NOTES APPLICATION RATES BASED ON TURF TYPE, AND NOTES RATES FOR NEWLY PLANTED PLANTS VS. ESTABLISHED PLANTS AND GENERAL RECOMMENDATIONS REGARDING SEASONAL ADJUSTMENTS (SPRING AND

8. A 3' CLEAR SPACE SHALL BE MAINTAINED AROUND THE CIRCUMFERENCE OF FIRE HYDRANTS. ALL FIRE HYDRANTS WILL NOT BE OBSTRUCTED

VISUALLY OR PHYSICALLY DUE TO VEGETATION. 9. ALL FIRE DEPARTMENT CONNECTIONS (FDC) SHALL NOT BE VISUALLY OR PHYSICALLY OBSTRUCTED BY LANDSCAPING.

10. EROSION CONTROL BLANKET TO BE APPLIED ON ALL SEED AREAS WITH GREATER THAN 3:1 SLOPES.

11. ALL PLANTS AND TREES NOT INSTALLED IN PLANTING BEDS TO RECEIVE 3 INCH DEPTH WOOD MULCH RING UNLESS OTHERWISE SPECIFIED. MULCH

RINGS TO BE SIZED PER PLANTING DETAILS. 12. SOD SHALL BE KENTUCKY BLUEGRASS BLEND.

13. USE SOLID STEEL EDGING EXCEPT WHERE NOTED ON THE DETAILS.

14. ALL TREES TO BE STAKED WITH WOOD STAKES. FOR 3" CAL. DECIDUOUS TREES AND EVERGREEN TREES OVER 8' USE 3 WOOD STAKES (STAKE TO GROUND LEVEL). SUBMIT STAKING MATERIALS PRODUCT INFO TO L.A. FOR APPROVAL PRIOR TO INSTALLATION.

15. ALL TREES TO BE STAKED FOR A MINIMUM OF 18 MONTHS. REMOVE STAKING MATERIALS ONCE TREE IS ESTABLISHED, WHICH MAY DEPEND ON

TREE SPECIES, MATURITY AND SITE CONDITIONS. 16. ROCK MULCH: INSTALL GEOTEXTILE FABRIC UNDER ALL ROCK AREAS.

17. AN IRRIGATION PLAN, WITH APPLICABLE SUPPORT MATERIAL, MAY BE SUBMITTED AT TIME OF BUILDING PERMIT APPLICATION. REVIEW AND APPROVAL OF THESE PLANS SHALL OCCUR THIRTY (30) DAYS SUBSEQUENT TO BUILDING PERMIT ISSUANCE OR PRIOR TO ISSUANCE OF CERTIFICATE OF OCCUPANCY, WHICHEVER OCCURS FIRST. UPON REQUEST BY THE APPLICANT, AN IRRIGATION PLAN, WITH APPLICABLE SUPPORT MATERIAL, SHALL BE SUBMITTED NINETY (90) DAYS SUBSEQUENT TO BUILDING PERMIT ISSUANCE AND APPROVED PRIOR TO ISSUANCE OF A CERTIFICATE OF 18. INSPECTION AND APPROVAL: NOTIFICATION FOR IRRIGATION INSPECTION AFFIDAVIT SHALL BE GIVEN DURING CONSTRUCTION WHILE TRENCH IS

OPEN AND AFTER COMPLETION OF SYSTEM INSTALLATION PRIOR TO SEEDING OR SODDING. THE LANDSCAPE ARCHITECT SHALL BE NOTIFIED AT

LEAST 48 HOURS PRIOR TO CLIENT SEEKING CERTIFICATE OF OCCUPANCY FOR FINAL LANDSCAPE INSPECTION AFFIDAVIT. 19. ANY FIELD CHANGES OR DEVIATIONS TO THESE PLANS WITHOUT PRIOR CITY APPROVAL OF AN AMENDED DEVELOPMENT PLAN MAY RESULT IN A

DELAY OF FINAL APPROVAL AND ISSUANCE OF A CERTIFICATE OF OCCUPANCY. 20. ALL STREET TREES AND STREETSCAPE IMPROVEMENTS IN THE R.O.W. WILL BE MAINTAINED BY THE ABUTTING PROPERTY OWNER.

STANDARD CITY OF COLORADO SPRINGS LANDSCAPE NOTES

1. A FINAL LANDSCAPE AND IRRIGATION PLAN, WITH APPLICABLE SUPPORTING MATERIAL, SHALL BE SUBMITTED AT TIME OF BUILDING PERMIT APPLICATION AND SHALL BE APPROVED BEFORE ANY BUILDING PERMIT APPROVAL, ANY LANDSCAPING OR IRRIGATION CONSTRUCTION, AND ISSUANCE OF A CERTIFICATE OF OCCUPANCY.

2. ALL PROPOSED LANDSCAPING SHALL BE WATERED BY AN AUTOMATIC IRRIGATION SYSTEM WHICH WILL PROVIDE DRIP IRRIGATION TO ALL SHRUB BEDS AND TREES WITHIN NATIVE SEED AREAS AND SPRAY IRRIGATION TO ALL HIGH-WATER USE TURF AND NATIVE SEED AREAS. 3. THE OWNER OR DEVELOPER IS REQUIRED TO PROVIDE INSPECTION AFFIDAVITS EXECUTED BY THE COLORADO LICENSED LANDSCAPE ARCHITECT OR CERTIFIED IRRIGATION DESIGNER OF RECORD FOR THE PROJECT, WHICH CERTIFIES THAT THE PROJECT WAS INSTALLED AND IN COMPLIANCE WIT THE APPROVED FINAL LANDSCAPE AND IRRIGATION PLAN ON FILE IN CITY PLANNING. THIS SHOULD REQUIRE LIMITED CONSTRUCTION OBSERVATION VISITS TO ACCURATELY COMPLETE THE AFFIDAVITS. WHEN READY TO CALL FOR INSPECTION AND SUBMIT AFFIDAVITS, FIRST

CONTACT THE CITY PLANNER OF RECORD FOR THE PROJECT (719-385-5905) AND AS NECESSARY OUR DRE OFFICE (719-385-5982). 4. COPIES OF RECEIPTS/DELIVERY TICKETS FOR SOIL AMENDMENTS INSTALLED ON THE PROJECT ARE REQUIRED TO BE PROVIDED WITH THE

5. IF SOIL IN THE PARKING LOT HAS BEEN COMPACTED BY GRADING OPERATIONS, THE SOIL WITHIN THE PLANTER SHALL BE TILLED, OR REMOVED TO A DEPTH OF THIRTY (30) INCHES AND REPLACED WITH AN ACCEPTABLE GROWING MEDIUM FOR THE SPECIES BEING INSTALLED. 6. TILLING OF THE EXISTING SOIL TO INCORPORATE AMENDMENTS AND COUNTER ANY COMPACTION OR SOIL CONSOLIDATION SHALL BE REQUIRED

FOR ALL LANDSCAPE PLANTING AREAS. 7. TREES SHALL MAINTAIN A 15-FOOT MINIMUM SEPARATION FROM WATER AND WASTEWATER MAINS AND A 6-FOOT MINIMUM SEPARATION FROM ELECTRIC AND GAS DISTRIBUTION LINES.

LANDSCAPE REQUIREMENTS

Landscape Setbacks See Code Section/Policy 7.4.905 Width (in Ft.) Tree/Feet Street Name or No. of Trees Classification Zone Boundary Req./ Prov. Costilla St Collector 150' 1 / 25' 6/3 -- / --8 /8 Sahwatch St Commercial -- / --190' 1 / 25' Ornamental Grass Sub. Setback Plant Abbr. Shrub Substitutes Percent Ground Plane

Veg. Req. / Provided

75% / 75%

75% / 75%

Motor Vehicle Lots See Code Section/Policy 7.4.907

30/30

Required / Provided

-- / --

-- / --


No. of Vehicles Spaces Provided	Shade Trees (1/15 spaces) Required /Provided	Plant Abbr. on Plan	Vehicle Lot Frontages	Length of Frontage (excluding driveways)	
27	2 /2	MV			
2/3 Length	Length of Screening	Min. 3' Screening	Evergreen Plants	Percent Ground Plane	
of Frontage (ft.)	Wall or Berm Provided	Plants Req. /Prov.	Req. (50%) / Prov.	Veg. Req. / Prov.	
		/	/	75% / 75%	

PLANT SCHEDULE


SYMBOL	CODE	QTY	BOTANICAL / COMMON NAME	HEIGHT	WIDTH	SIZE	<u>COND</u>	CODE REQS	ARTIFICAL PLAYGROUND TURF	3,840 sf
ANNUALS	_	67	Dudhackin hints / Black avad Cusan	2,	1 E'	1 641	CONT		,	.,.
	Rh	67	Rudbeckia hirta / Black-eyed Susan	2`	1.5`	1 GAL	CONT		POCK MILLON	4 262 cf
DECIDUO	OUS SHR	<u>UBS</u>							ROCK MULCH 2"-4" River Rock	4,262 sf
	Al	11	Amorpha canescens / Leadplant	2.5`	3.5`	1 GAL	CONT	- (signature)		
\odot	Sj	12	Spiraea japonica / Japanese Spirea	2'-3'	3'-4'	5 GAL	CONT	- (signature)	ENGINEERED WOOD FIBER	2,569 sf
	Sm	5	Syringa meyeri 'Palibin' / Dwarf Korean Lilac	4'-6'	4'-6'	5 GAL	CONT	Screen/Wall		
EVERGRE	EN SHR	<u>UBS</u>							POURED-IN-PLACE RUBBER BEIGE COLOR	1,103 sf
Exercise Services	Jb2	3	Juniperus virginiana 'Blue Arrow' / Blue Arrow Juniper	8,	2`-3`	6`	CONT	Wall/Screen/Trash	BEIGE COLOR	
	Pm	27	Pinus mugo 'Mops' / Mops Mugo Pine	2'-3'	2`-3`	5 GAL	CONT	- (signature)	POURED-IN-PLACE RUBBER 2	656 sf
<u>GRASSES</u>									GREEN COLOR	230 5.
ANN E	Hs	29	Helictotrichon sempervirens / Blue Oat Grass	2'-4'	2`-4`	1 GAL	CONT	SCREEN		

Muhlenbergia reverchonii 'PUND01S' / Undaunted® Ruby Muhly 2'-4' 2`-4` 1 GAL CONT - (signature)

Percent Signature Shrubs**: (70% minimum - Policy 311.3K) Signature Shrubs: 95 Total No. of Shrubs: 95=100% Signature Shrubs

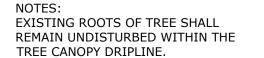


CONTRACTOR SHALL REPAIR/REPLACE ANY EXISTING IRRIGATION COMPONENTS, DAMAGE DUE TO CONSTRUCTION.

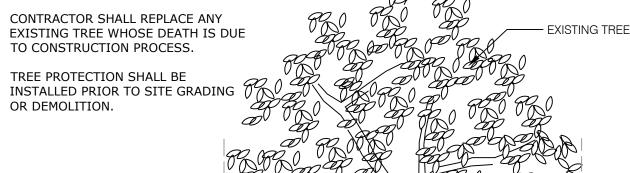

PLASTIC ORANGE · CONSTRUCTION FENCE TIED TO T-POST T-POST AT 8' O.C. (TYP.) —

EXISTING TREE PROTECTION DETAIL

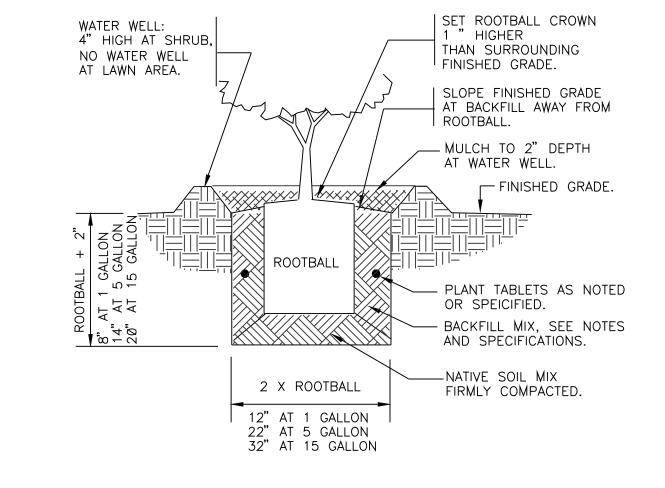

GROUND COVER LEGEND

SHRUB PLANTING

02-11

P-2019.005-24

329333.13-01

P-GR-46

- PERENNIALS/ORNAMENTAL GRASSES SIZES PER PLAN. PLANT AT ORIGINAL NURSERY DEPTH. WOOD MULCH UNDISTURBED SOIL -BACKFILL MIXTURE REFER -TO SPECIFICATIONS

WEAR COURSE 1 MIN. — CUSHION LAYER, DEPTH VARIES DEPENDING ON FALL HEIGHT AND PRODUCT ┌─ 1/2" EXPANSION JOINT WITH SILICON SEALANT COLOR TO MATCH SURROUNDING SURFACE ⅓ TO ½ OF BOULDER SHALL BE BURIED 4" COMPACTED AGGREGATE BASE, 3" MINUS IRREGULAR STONE COMPACTED

PERENNIAL / ORNAMENTAL GRASS PLANTING

3

LANDSCAPE BOULDER AT PLAY SURFACE

TO 95% IN 2" LIFTS

TELE. 719-471-7566 FAX: 719-471-1174 www.rtaarchitects.com

SOUTH TEJON ST., SUITE 300 COLORADO SPRINGS, CO. 80903

Land Planning Landscape Architecture Urban Design

TA PROJECT NUMBER 2024-064.00 01-06-2025 CH 3.12.25 PER CITY COMMENTS

NOTES

LANDSCAPE

C.HELMLINGER C.LIEBER

ISSUED FOR BIDS/PERMIT

CHECKED BY:



19 SOUTH TEJON ST., SUITE 300 OLORADO SPRINGS, CO. 80903

TELE. 719-471-7566 FAX: 719-471-1174 www.rtaarchitects.com

Land Planning Landscape Architecture Urban Design

HYDROLOGY DIAGRAM

2024-064.00

01-06-2025

CH 3.12.25 PER CITY COMMENTS

DRAWN BY: HELMLINGER/ROMAN C.LIEBER

ISSUED FOR BIDS/PERMIT 10 OF 13 LS 5.0

Munding Design, LLC Irrigation Design and Landscape Architecture 302 E. Geneseo St. _afayette, Colorado 80026

IRRIGATION CHARTS

NOTE ON PRESSURE AT EACH ZONE: 1. ALL TORO PRECISION SPRAY ZONES OPERATE

AT 30 PSI. 2. ALL MP ROTATOR ZONES OPERATE AT 40 PSI.

3. ALL DRIP ZONES OPERATE AT 30 PSI. 4. ALL ROTOR ZONES OPERATE AT 35 PSI.

PRESSURE LOSS CALCULATIONS

NOTE: IRRIGATION SCHEDULE IS PROVIDED FOR INFORMATION ONLY BY DESIGNER. FINAL CONTROLLER PROGRAMING IS THE RESPONSIBILITY OF THE THE OWNER AND OR THEIR MAINTENANCE CONTRACTOR. INFORMATION PROVIDED FOR MONTHLY RUNTIMES IS BASED ON HISTORICAL EVAPORATION RATES. ESTABLISHED RUN TIMES ARE AN AVERAGE AT A STANDARD 24 WEEK IRRIGATION SEASON FROM MID APRIL TO LATE SEPTEMBER FOR COLORADO.

Total irrigation sf for the whole site is 164,898, 23,316 sf of sod, 41,184 st of native seed and 100,398 sf of plantings.


2 SAMPLE IRRIGATION SCHEDULE

STANDARD CITY OF COLORADO SPRINGS IRRIGATION NOTES:

- The City has adopted permanent water—wise regulations as of January 1, 2020, which will affect the overall operation of the irrigation system.
- From May 1 to October 15, sprinklers can be operated before 10 a.m. and after 6 p.m. Watering is limited to three days a week (Drip irrigation is allowed at any time). Establishment permits are required from Colorado Springs Utilities for customers who need to temporarily water more than three days a week to establish new landscapes. Allocation plans are available for customers who need more watering schedule flexibility from Colorado Springs Utilities.
- For all design irrigation systems, if more than three days a week are required to provide required coverage with spray/rotor stations/valves, a Water Allocation Plan is required from Colorado Springs Utilities.
- City Affidavit Note The design professional of record is to complete the irrigation inspection affidavit based on approved Irrigation Plan. This should require limited construction observation visits and a functional test of the irrigation system shall be performed to accurately complete the affidavit. Final CO or financial assurances rélease shall not be processed until an executéd and approved affidavit is submitted to City Staff. When ready to call for inspection and submit affidavits, first contact the city planner of record for the project (719-385-5905) and as necessary our DRE office (719-385-5982).

Note: Starting June 2023 the City of Colorado Springs has enacted a new policy manual and irrigation check list. These plans comply with the new landscape manual and irrigation check list.

720-273-3884

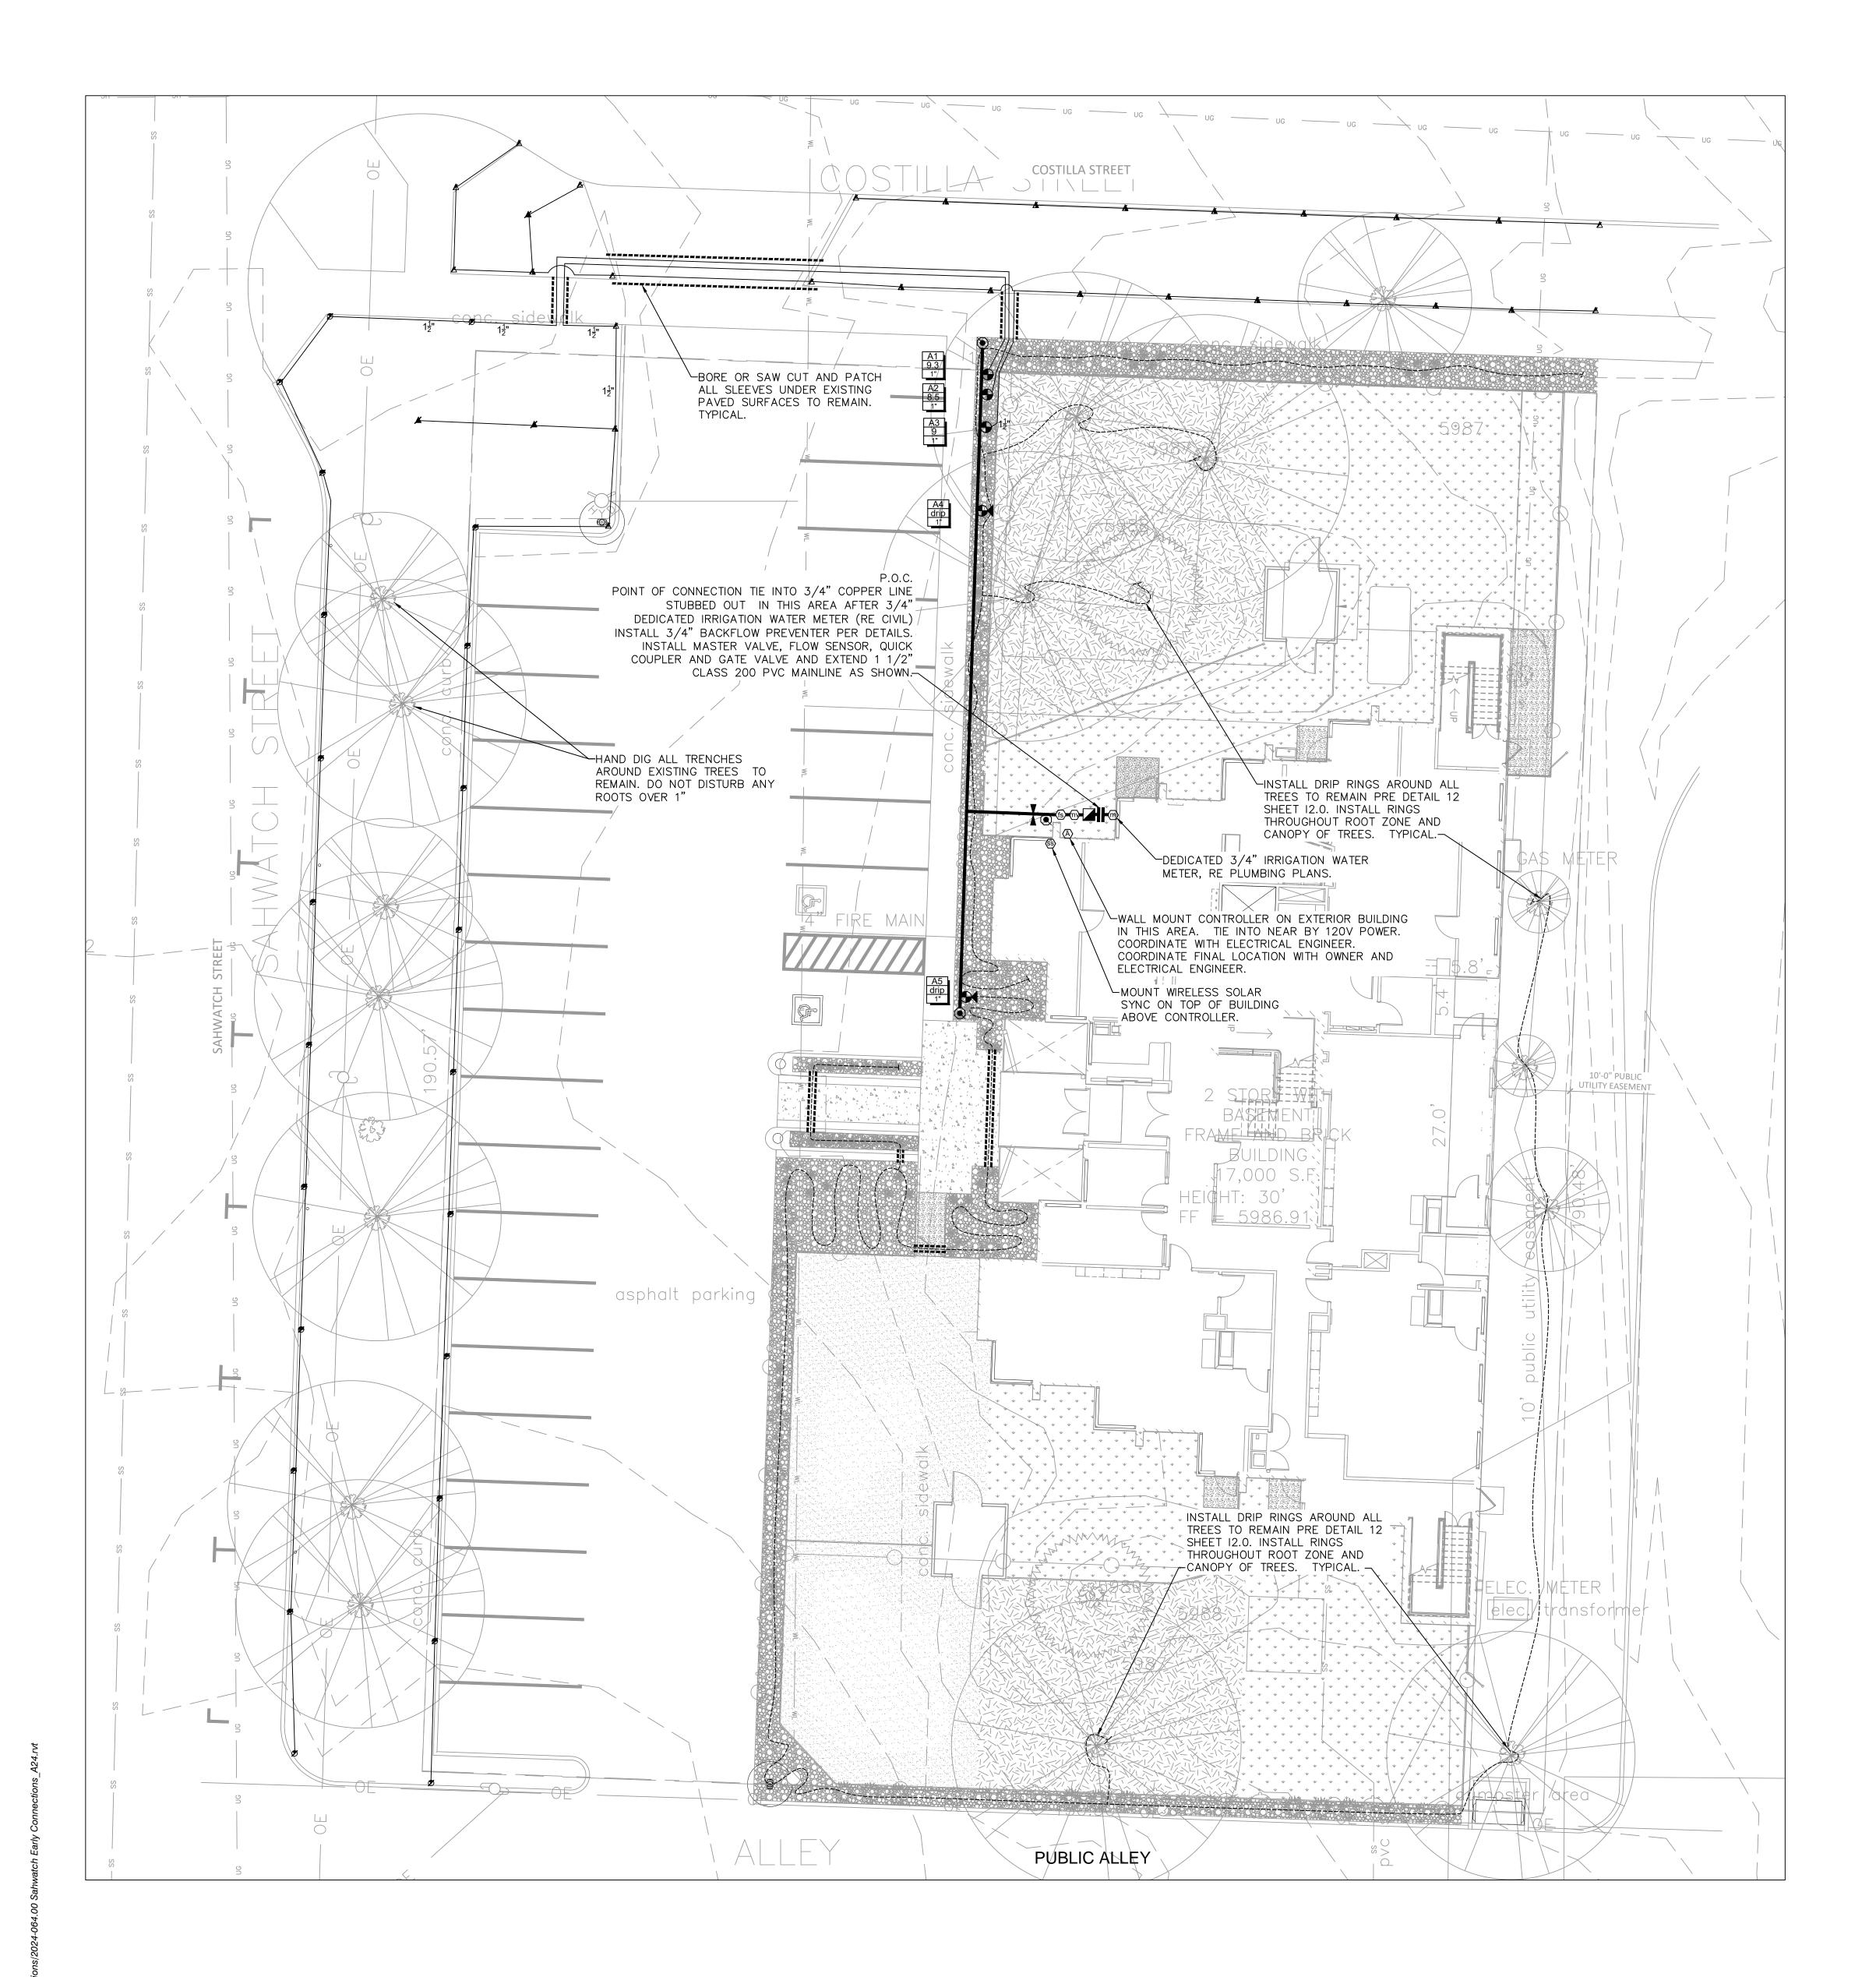

MP ROTATOR SPRINKLER: HUNTER PROS-06-PRS40-CV MP1000 NOZZLE PRESSURE: 40 PSI RADIUS: 10-14 FEET FLOW (GPM): Q - 0.19 H - 0.37 F - 0.75 6"POP UP HEIGHT Precip. rate (in/hr): 0.40 Ø ● MP ROTATOR SPRINKLER: HUNTER PROS-06-PRS40-CV MP2000 NOZZLE PRESSURE: 40 PSI RADIUS: 13-19 FEET FLOW (GPM): Q - 0.40 H - 0.74 F - 1.47 6"POP UP HEIGHT Precip. rate (in/hr): 0.40 BACKFLOW PREVENTER: 3/4" FEBCO 825YA INSTALLED PER DETAILS ZONE CONTROL VALVE: HUNTER ICV SIZE AS NOTED DRIP CONTROL VALVE ASSEMBLY: HUNTER ICZ DRIP ZONE KIT 1" VALVE QUICK COUPLER: RAINBIRD 44LRC GATE VALVE - RESILIENT WEDGE, SQUARE NUT TOP, LINE SIZE EMITTER LATERAL PIPE: UV RADIATION RESISTANT POLYETHYLENE, 1" SIZE (ROUTING IS DIAGRAMMATIC) INSTALL CHECK VALVE IN LINE ON DRIP LATERAL EVERY 10' OF ELEVATION DIFFERENCES THAT ARE MORE THAN 10' IN ONE ZONE. DRIP FLUSH PLUG ASSEMBLY MAINLINE PIPE: 1 1/2" BELL END CLASS 200 PVC WITH GLUED FITTINGS. LATERAL PIPE TO SPRINKLERS: CLASS 200 PVC PIPE (1-INCH SIZE UNLESS OTHERWISE INDICATED) UNCONNECTED PIPE CROSSING UNCONNECTED PIPE CROSSING, TWO DIFFERENT PIPES P.O.C. - POINT OF CONNECTION CLASS 200 PVC SLEEVING, 4" UNLESS OTHERWISE NOTED —— INDICATES CONTROLLER AND CONTROLLER STATION NUMBER - INDICATES LATERAL DISCHARGE IN GPM -INDICATES REMOTE CONTROL VALVE SIZE IN INCHES NEW HUNTER ACC2 TWO WIRE 225 STATION CONTROLLER IN PLASTIC ENCLOSURE. MODEL # A2C-225-P. INSTALL GROUNDING AT CONTROLLER AND ALONG TWO WIRE PATH A'S REQUIRED PER HUNTER SPECIFICATIONS. USE 1 STATION HUNTER DECODERS FOR EACH SINGLE VALVE MODEL # ICD-100, INSTALL PER HUNTER SPECIFICATIONS. INSTALL GROUNDING ALONG MAINLINE PATH AND AT CONTROLLER PER HUNTER REQUIREMENTS. CONTRACTOR TO PROVIDE SHOP DRAWINGS FOR ALL FINAL EQUIPMENT AND INSTALLATION DETAILS PRE HUNTER SPECIFICATIONS. HUNTER 1 1/2" MASTER VALVE MODEL# ICV 1 1/2" HUNTER 1" FLOW SENSOR MODEL# FTC-100 HUNTER WIRELESS SOLAR SYNC MODEL # WSS-SEN DEDICATED 3/4" IRRIGATION WATER METER REFER TO CIVIL AND MEP IRRIGATION NOTES 1. Irrigation system is designed to operate off of an existing pressure of 80 psi before water meter and backflow preventer. Contractor to verify pressure <u>PRIOR TO INSTALLATION</u> and notify OWNER of any differences. Design pressure at heads to be as noted in legend. 2. No irrigation work to begin until final grade has been approved. 3. Locate all heads 6" min. from any wall, walk, or curb, and 12" min. from any curb adjacent to parking stalls. 4. Bury all mainlines 24" underground to top of pipe. Bury all laterals 12"" underground to top of pipe. 5. Pipes in shared trenches are not allowed. 6. Brand all appropriate box lids with 1" minimum letters with the following abbreviations: GV Gate Valvė SV# Section Valve & Corresponding Controller Station # 7. All pipe under pavement to be sleeved in 4" minimum PVC class 200 extend 12" beyond each edge of pavement, sloped to drain. Install prior to paving. Sleeve wires separately in 4" min. pipe. 8. All valve wire is to be 14 gauge direct burial Paige 2—wire. All wire splices shall be done with 3M 9. Heads will be diagrammatic. Contractor to select and install correct arcs as needed for part circle heads. Adjust radii and arc as necessary for no overspray/backwash onto adjacent buildings, walls, 10. Plan has been prepared using limited on—site observation. Plan is diagrammatic and does not reflect all equipment, etc., that could be encountered during construction. All tie locations, mainline locations and lateral locations are approximate and shall require exact location by Contractor.

Rain Bird XB-10PC

Rain Bird XB-20PC

Rain Bird XB-20PC

2 ea.

6 ea.

4 ea.

6 ea.

11. Install drip emitters as described below:

Deciduous Trees (1-1/2"-2 1/2") Rain Bird XB-20PC Deciduous Trees (3"-4" CAL.) Rain Bird XB-20PC

1 gallon material

5 gallon material

Evergreen Trees (6'-10')

Evergreen Trees (11'-14')

12. See sheet I2.0 for irrigation details.








Y EDU SAHWATCH SPRINGS, C

Munding Design, LLC Irrigation Design and Landscape Architecture 302 E. Geneseo St. _afayette, Colorado 80026 720-273-3884



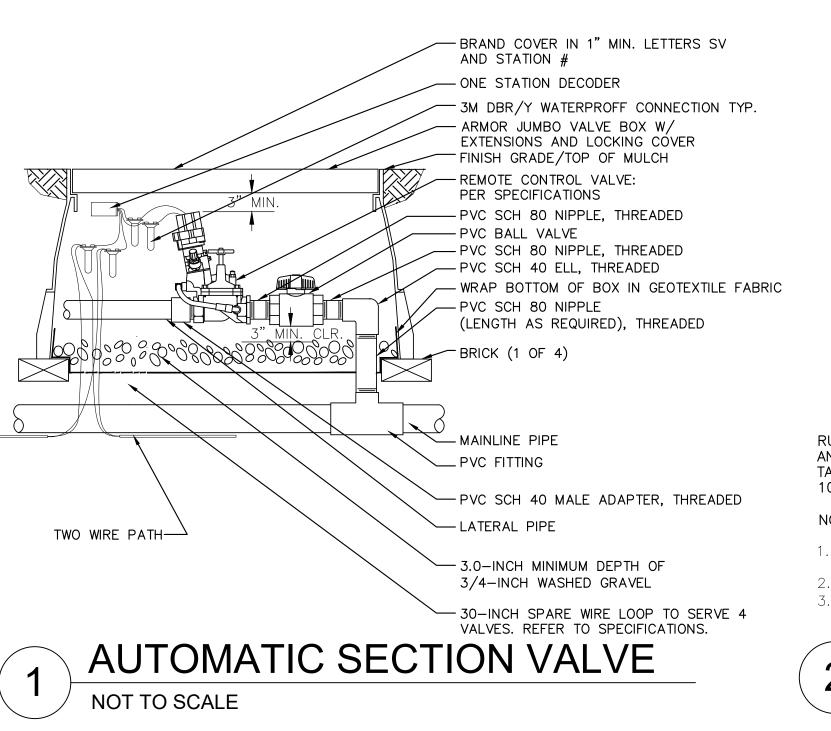

1. NOMINAL SIZE OF GATE VALVE TO MATCH NOMINAL MAINLINE SIZE.

WHEN USING PUSH ON TYPE VALVES.

MICRO-TUBING (TYP.)——

SHRUB/TREE EMITTER PLACEMENT

DRIP EMITTER, INSTALL PER DRIP— EMITTER PLACEMENT DETAIL

ISOLATION GATE VALVE


NOT TO SCALE


 $-\frac{3}{4}$ " DRIP TUBING. INSTALL 4"-6"

BELOW FINAL

NOT TO SCALE

DROP GRADE FOR SOD

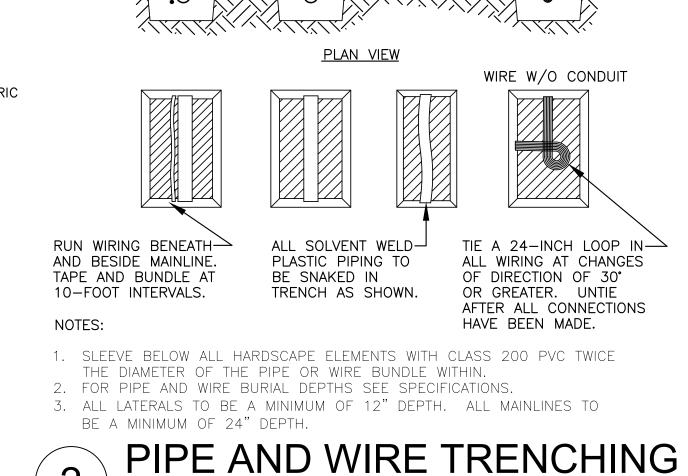

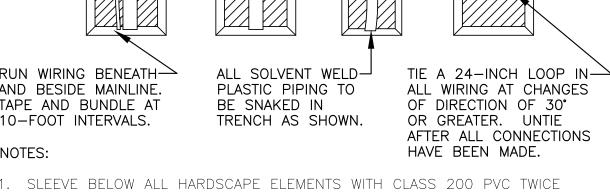

SECTION VIEW

WIRING IN

CONDUIT

MAINLINE AND

WIRING IN THE

SAME TRENCH




ARMOR STANDARD -

VALVE BOX, WITH

"QC" BRANDED ON


PVC NIPPLE -

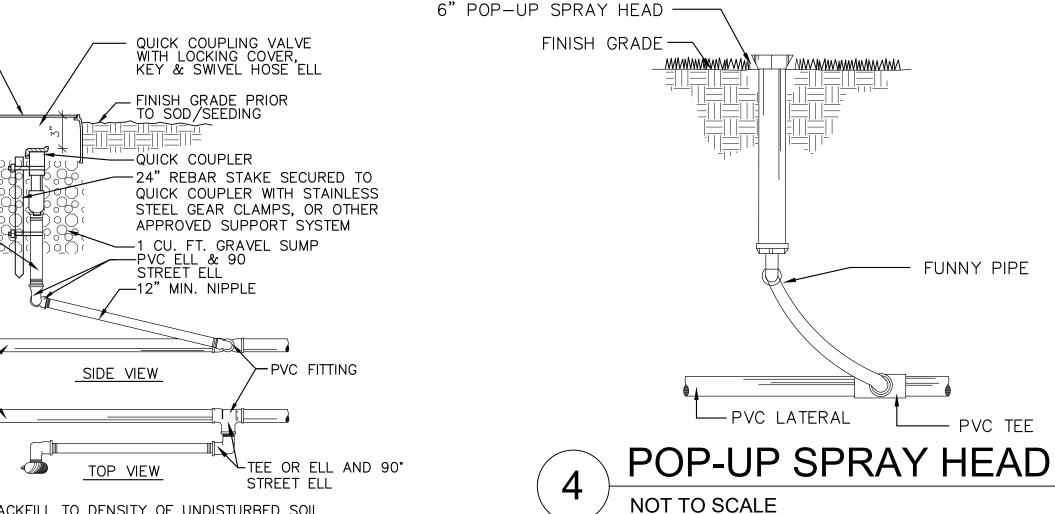



SCH 80 NIPPLE (2-INCH LENGTH, HIDDEN) AND 2

QUICK COUPLER



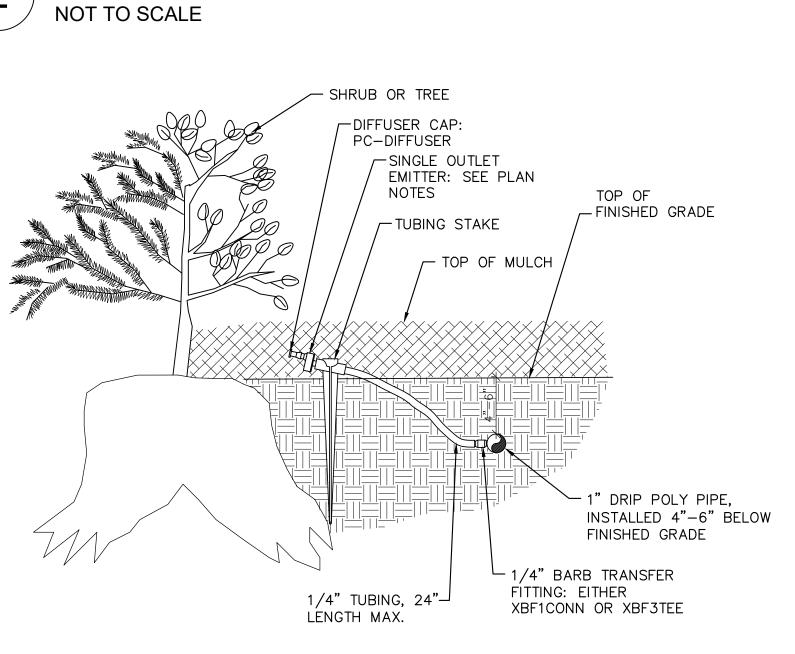

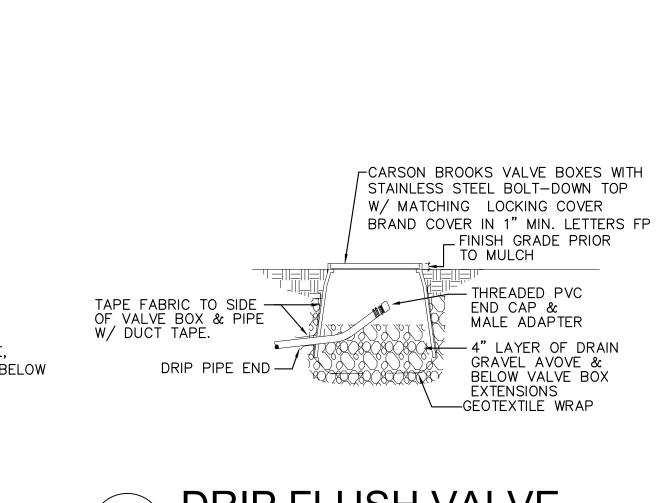

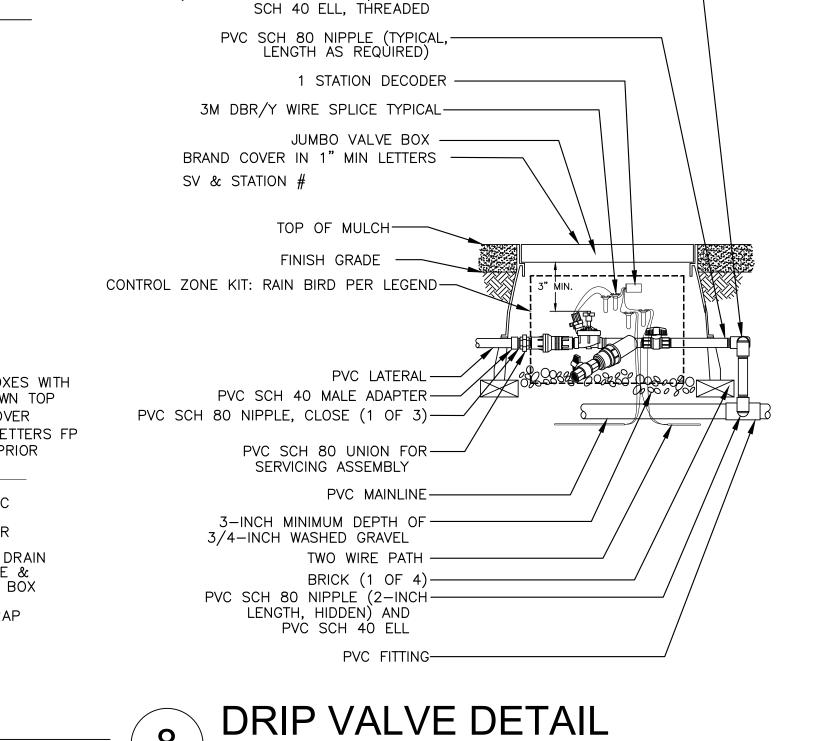

2. INSTALL A 4" THICK CONCRETE PAD BELOW VALVE WITH NO. 4 REBAR

- NETAFIM INLINE

- FINISH GRADE / TOP OF MULCH OR AREAS TO BE SEEDED

LOCKING COVER

. BRICK (1 OF 2)

RESILIENT WEDGE

NUT. LINE SIZE.

GATE VALVE WITH 2" SQUARE OPERATING

PVC MAIN LINE PIPE


- ARMOR VALVE BOX WITH

6" PVC_CL_200_PIPE (LENGTH_AS_REQUIRED)

DRIP EMITTER PLACEMENT NOT TO SCALE

TUBING DIAMETER



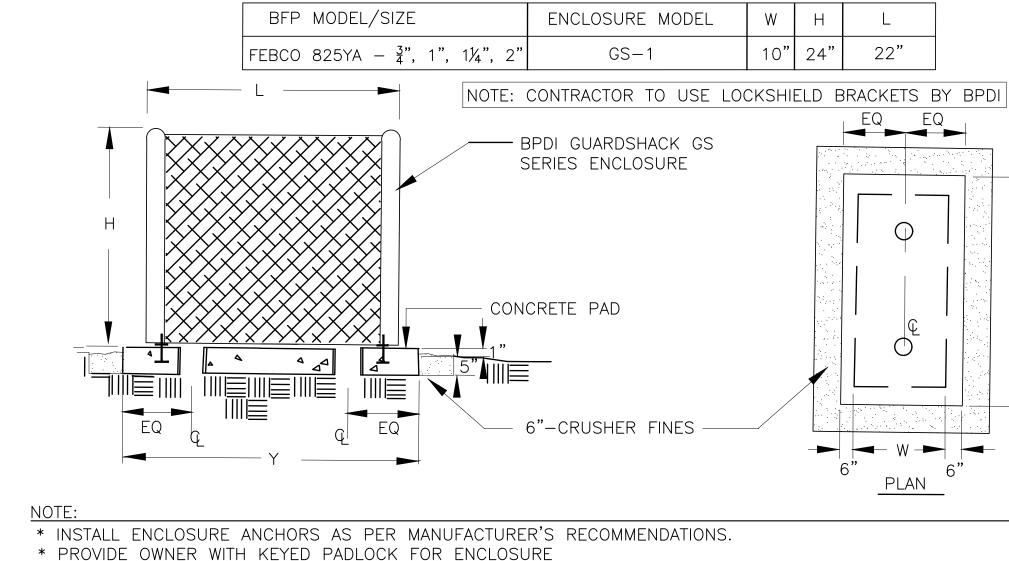

22"

 \bigcirc

PLAN

_ PLUS 6"

NOT TO SCALE


TOBITO DI MILETER
* REFER TO ENCLOSURE DETAIL FOR CONCRETE PAD DIMENSIONS REDUCED PRESSURE
* DIAMETER OF FITTINGS AND TUBING SHALL EQUAL DIAMETER BACKFLOW PREVENTER UNLESS NOTED OTHERWISE * DIAMETER BACKFLOW PREVENTER UNLESS NOTED OTHERWISE
6" CONCRETE PAD QUICK COUPLING — VALVE. INSTALL PER Q.C. DETAIL
CxM ADAPTER (TWO REQUIRED) BRASS UNIONS (2)
12" FQ CXC CXC CXC
54" MIN.
TYPE "K" CLASS 200 PVC MAINLINE HARD COPPER
TIE INTO LINE DOWNSTREAM OF

BACKFLOW PREVENTER



* CONCRETE PAD PENETRATIONS TO BE 1" LARGER THAN

* PROVIDE ENCLOSURE WITH STANDARD DARK GREEN POWDER COATED FINISH * PAD PENETRATIONS FOR BACKFLOW PREVENTER RISERS TO BE 1'' LARGER THAN RISER DIAMETER. * TOP SURFACE OF CONCRETE PAD SHALL BE 1" ABOVE FINISH GRADE BACKFLOW ENCLOSURE

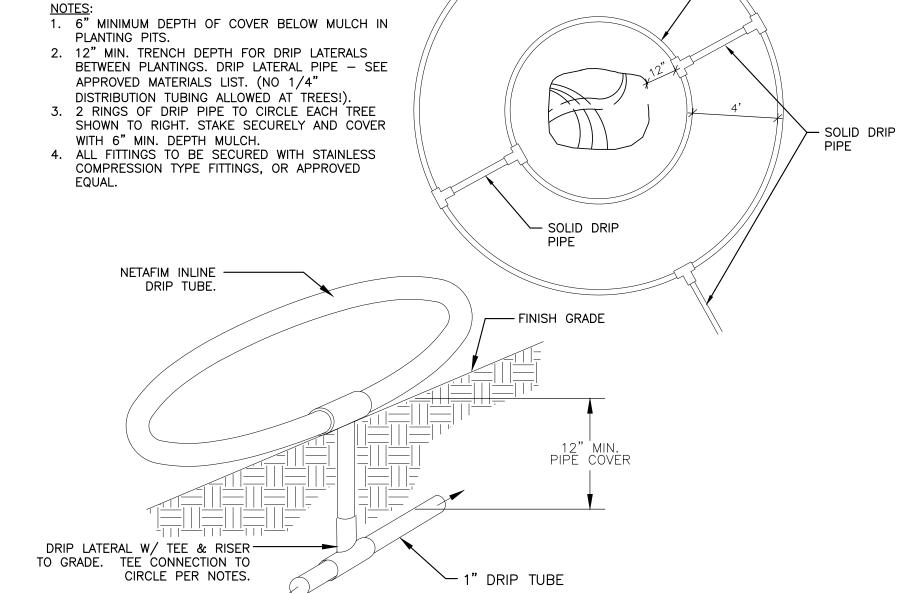

DRIP RINGS AT TREES IN NATIVE SEED NOT TO SCALE